



COMMUNITY DEVELOPMENT DEPARTMENT

45175 Ten Mile Road
Novi, MI 48375
(248) 347-0415 Phone
(248) 735-5600 Facsimile
www.cityofnovi.org

ZONING BOARD OF APPEALS STAFF REPORT

FOR: City of Novi Zoning Board of Appeals

MEETING DATE: June 11, 2024

REGARDING: 210 Buffington Drive # 50-22-03-385-026 (PZ24-0022)

BY: Alan Hall, Deputy Director Community Development

I. GENERAL INFORMATION:

Applicant

Scenic Pines Estates

Variance Type

Dimensional Variance

Property Characteristics

Zoning District: This property is zoned One-Family Residential (R-4)

Location: south of South Lake Drive, east of West Park Drive

Parcel #: 50-22-03-385-026

Request

The applicant is requesting a variance from the City of Novi Zoning Ordinance Section 3.28.6.C.iv.a to omit the requirement for a landscape berm along the east, west and south property lines.

II. STAFF COMMENTS:

The applicant is seeking a variance to not provide a landscape berm along two property lines. The site has an irregular shape with regulated woodlands and wetlands component.

History: *On November 19, 2019 – This same variance was approved, but now has expired.*

III. RECOMMENDATION:

The Zoning Board of Appeals may take one of the following actions:

1. I move that we **grant** the variance in Case No. **PZ24-0022**, sought by _____, for _____ because Petitioner has shown practical difficulty requiring _____.
_____.
_____.
- (a) Without the variance Petitioner will be unreasonably prevented or limited with respect to use of the property because _____.
_____.
_____.
- (b) The property is unique because _____.
_____.
_____.
- (c) Petitioner did not create the condition because _____.
_____.
_____.
- (d) The relief granted will not unreasonably interfere with adjacent or surrounding properties because _____.
_____.
_____.
- (e) The relief is consistent with the spirit and intent of the ordinance because _____.
_____.
_____.
- (f) The variance granted is subject to:
 1. _____.
 2. _____.
 3. _____.
 4. _____.

2. I move that we **deny** the variance in Case No. **PZ24-0022**, sought by _____, for _____ because Petitioner has not shown practical difficulty requiring _____

_____.
_____.

(a) The circumstances and features of the property including _____
_____ are not unique because they exist generally throughout the City.

(b) The circumstances and features of the property relating to the variance request are self-created because _____

_____.

(c) The failure to grant relief will result in mere inconvenience or inability to attain higher economic or financial return based on Petitioners statements that _____

_____.

(d) The variance would result in interference with the adjacent and surrounding properties by _____

_____.

(e) Granting the variance would be inconsistent with the spirit and intent of the ordinance to _____

_____.

Should you have any further questions with regards to the matter please feel free to contact me at (248) 347-0417.

Alan Hall – Deputy Director Community Development - City of Novi



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ZONING BOARD OF APPEALS APPLICATION

APPLICATION MUST BE FILLED OUT COMPLETELY

RECEIVED

MAY 01 2024

CITY OF NOVI
COMMUNITY DEVELOPMENT

I. PROPERTY INFORMATION (Address of subject ZBA Case)				Application Fee: <u>\$330.00</u>	
PROJECT NAME / SUBDIVISION SCENIC PINES ESTATES				Meeting Date: <u>6-11-24</u>	
ADDRESS 1207 Pembine, Novi (JSP18-76) 210 Buffington Dr				ZBA Case #: <u>PZ 24-0022</u>	
SIDWELL # 50-22-03 -378 -008				May be obtain from Assessing Department (248) 347-0485	
CROSS ROADS OF PROPERTY Pembine Road between Buffington Road and Hennina Road					
IS THE PROPERTY WITHIN A HOMEOWNER'S ASSOCIATION JURISDICTION? <input type="checkbox"/> YES <input checked="" type="checkbox"/> NO				REQUEST IS FOR: <input checked="" type="checkbox"/> RESIDENTIAL <input type="checkbox"/> COMMERCIAL <input type="checkbox"/> VACANT PROPERTY <input type="checkbox"/> SIGNAGE	
DOES YOUR APPEAL RESULT FROM A NOTICE OF VIOLATION OR CITATION ISSUED? <input type="checkbox"/> YES <input checked="" type="checkbox"/> NO					
II. APPLICANT INFORMATION					
A. APPLICANT		EMAIL ADDRESS Todd.Rankine@singhmail.com		CELL PHONE NO. 248-866-9799	
NAME Todd Rankine		TELEPHONE NO. 248-865-1614			
ORGANIZATION/COMPANY Singh Development		FAX NO. 248-865-1630			
ADDRESS 7125 Orchard Lake Road		CITY West Bloomfield		STATE MI	ZIP CODE 48322
B. PROPERTY OWNER <input checked="" type="checkbox"/> CHECK HERE IF APPLICANT IS ALSO THE PROPERTY OWNER					
Identify the person or organization that owns the subject property:		EMAIL ADDRESS		CELL PHONE NO.	
NAME				TELEPHONE NO.	
ORGANIZATION/COMPANY				FAX NO.	
ADDRESS		CITY		STATE	ZIP CODE
III. ZONING INFORMATION					
A. ZONING DISTRICT					
<input type="checkbox"/> R-A <input type="checkbox"/> R-1 <input type="checkbox"/> R-2 <input type="checkbox"/> R-3 <input checked="" type="checkbox"/> R-4 <input type="checkbox"/> RM-1 <input type="checkbox"/> RM-2 <input type="checkbox"/> MH <input type="checkbox"/> I-1 <input type="checkbox"/> I-2 <input type="checkbox"/> RC <input type="checkbox"/> TC <input type="checkbox"/> TC-1 <input type="checkbox"/> OTHER _____					
B. VARIANCE REQUESTED					
INDICATE ORDINANCE SECTION (S) AND VARIANCE REQUESTED:					
1. Section <u>3.28.6.C.iv.a</u> Variance requested <u>Delete the requirement for landscape berm along the east, west and south property lines</u>					
2. Section _____ Variance requested _____					
3. Section _____ Variance requested _____					
4. Section _____ Variance requested _____					
IV. FEES AND DRAWINGS					
A. FEES					
<input type="checkbox"/> Single Family Residential (Existing) \$220 <input type="checkbox"/> (With Violation) \$275 <input checked="" type="checkbox"/> Single Family Residential (New) \$275					
<input type="checkbox"/> Multiple/Commercial/Industrial \$330 <input type="checkbox"/> (With Violation) \$440 <input type="checkbox"/> Signs \$330 <input type="checkbox"/> (With Violation) \$440					
<input type="checkbox"/> House Moves \$330 <input type="checkbox"/> Special Meetings (At discretion of Board) \$660					
B. DRAWINGS 1-COPY & 1 DIGITAL COPY SUBMITTED AS A PDF					
<ul style="list-style-type: none">• Dimensioned Drawings and Plans• Site/Plot Plan• Existing or proposed buildings or addition on the property• Number & location of all on-site parking, if applicable• Existing & proposed distance to adjacent property lines• Location of existing & proposed signs, if applicable• Floor plans & elevations• Any other information relevant to the Variance application					



ZONING BOARD OF APPEALS APPLICATION

V. VARIANCE

A. VARIANCE (S) REQUESTED

☒ DIMENSIONAL ☐ USE ☐ SIGN

There is a five-(5) hold period before work/action can be taken on variance approvals.

B. SIGN CASES (ONLY)

Your signature on this application indicates that you agree to install a **Mock-Up Sign** ten-(10) days before the schedule ZBA meeting. Failure to install a mock-up sign may result in your case not being heard by the Board, postponed to the next schedule ZBA meeting, or cancelled. A mock-up sign is **NOT** to be actual sign. Upon approval, the mock-up sign must be removed within five-(5) days of the meeting. If the case is denied, the applicant is responsible for all costs involved in the removal of the mock-up or actual sign (if erected under violation) within five-(5) days of the meeting.

C. ORDINANCE

City of Novi Ordinance, Section 3107 – Miscellaneous

No order of the Board permitting the erection of a building shall be valid for a period longer than one-(1) year, unless a building permit for such erection or alteration is obtained within such period and such erection or alteration is started and proceeds to completion in accordance with the terms of such permit.

No order of the Board permitting a use of a building or premises shall be valid for a period longer than one-hundred and eighty-(180) days unless such use is established within such a period; provided, however, where such use permitted is dependent upon the erection or alteration of a building such order shall continue in force and effect if a building permit for such erection or alteration is obtained within one-(1) year and such erection or alteration is started and proceeds to completion in accordance with the terms of such permit.

D. APPEAL THE DETERMINATION OF THE BUILDING OFFICIAL

PLEASE TAKE NOTICE:

The undersigned hereby appeals the determination of the Building Official / Inspector or Ordinance made

☐ CONSTRUCT NEW HOME/BUILDING ☐ ADDITION TO EXISTING HOME/BUILDING ☐ SIGNAGE

☐ ACCESSORY BUILDING ☐ USE ☐ OTHER _____

VI. APPLICANT & PROPERTY SIGNATURES

A. APPLICANT

[Signature]
Applicant Signature

05.01.2024
Date

B. PROPERTY OWNER

If the applicant is not the owner, the property owner must read and sign below:

The undersigned affirms and acknowledges that he, she or they are the owner(s) of the property described in this application, and is/are aware of the contents of this application and related enclosures.

[Signature]
Property Owner Signature

05.01.2024
Date

VII. FOR OFFICIAL USE ONLY

DECISION ON APPEAL:

☐ GRANTED

☐ DENIED

The Building Inspector is hereby directed to issue a permit to the Applicant upon the following and conditions:

Chairperson, Zoning Board of Appeals

Date



Community Development Department

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ZONING BOARD OF APPEALS VARIANCE APPLICATION CHECKLIST

The following items are required for a complete Variance application. Incomplete applications will be returned.

☒ **Signed Application Form**

Complete the Zoning Board of Appeals application form. Application must be signed by the applicant and the property owner (if different).

☒ **Response to Variance Review Standards – Dimensional, Use, or Sign**

Select the applicable Review Standards for the requested Variance and complete in full. Use additional paper if needed. If you don't know which Review Standards to complete, call the Community Development Department at 248.347.0415 for guidance.

☒ **Dimensioned Site Plan (1 copy & 1 digital copy submitted as a PDF)**

- Existing or proposed buildings or additions on the property.
- Number and location of all on-site parking spaces.
- Existing and proposed distances to adjacent property lines.
- Location of existing and proposed signs, if applicable.
- Any other information relevant to the Variance application.

☒ **Dimensioned Drawings and Plans (1 copy & 1 digital copy submitted as a PDF)**

- Floor plans and elevations with all proposed buildings and additions.
- All existing and proposed signs on the property (photographs may be used).
- For use variances, include floor plan showing the existing and proposed layout and functions of each area.
- For multi-family residential structures or projects, a summary showing the existing and proposed number of dwelling units by type (efficiency, one-bedroom, two-bedroom, etc.)

☒ **Other Helpful Information – Optional (1 copy & 1 digital copy submitted as a PDF)**

- Photographs of the lot or structure that shows the special conditions or circumstances described in the application.
- Photographs or maps that show how other properties in the area enjoy the same type of property rights related to the Variance.
- Letters of support from the neighbors who would be most affected by your request.

☒ **Fee (make check payable to the City of Novi)**

Single Family Residential (Existing) \$220 (With Violation) \$275
Single Family Residential (New) \$275
Multiple/Commercial/Industrial \$330 (With Violation) \$440
Signs \$330 (With Violation) \$440
House Moves \$330
Special Meetings (At discretion of Board) \$660

Additional Information

In the course of reviewing the application, the Planning Department staff may request additional information from the applicant.



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REVIEW STANDARDS DIMENSIONAL VARIANCE

The Zoning Board of Appeals (ZBA) will review the application package and determine if the proposed Dimensional Variance meets the required standards for approval. In the space below, and on additional paper if necessary, explain how the proposed project meets each of the following standards. (Increased costs associated with complying with the Zoning Ordinance will not be considered a basis for granting a Dimensional Variance.)

Standard #1. Circumstances or Physical Conditions.

Explain the circumstances or physical conditions that apply to the property that do not apply generally to other properties in the same zoning district or in the general vicinity. Circumstances or physical conditions may include:

- a. **Shape of Lot.** Exceptional narrowness, shallowness or shape of a specific property in existence on the effective date of the Zoning Ordinance or amendment.
☐ Not Applicable ☒ Applicable If applicable, describe below:
See attached.

and/or

- b. **Environmental Conditions.** Exceptional topographic or environmental conditions or other extraordinary situations on the land, building or structure.
☐ Not Applicable ☒ Applicable If applicable, describe below:
See attached.

and/or

- c. **Abutting Property.** The use or development of the property immediately adjacent to the subject property would prohibit the literal enforcement of the requirements of the Zoning Ordinance or would involve significant practical difficulties.
☒ Not Applicable ☐ Applicable If applicable, describe below:

Standard #2. Not Self-Created.

Describe the immediate practical difficulty causing the need for the Dimensional Variance, that the need for the requested variance is not the result of actions of the property owner or previous property owners (i.e., is not self-created).

See attached.

Standard #3. Strict Compliance.

Explain how the Dimensional Variance in strict compliance with regulations governing area, setback, frontage, height, bulk, density or other dimensional requirements will unreasonably prevent the property owner from using the property for a permitted purpose, or will render conformity with those regulations unnecessarily burdensome.

See attached.

Standard #4. Minimum Variance Necessary.

Explain how the Dimensional Variance requested is the minimum variance necessary to do substantial justice to the applicant as well as to other property owners in the district.

See attached.

Standard #5. Adverse Impact on Surrounding Area.

Explain how the Dimensional Variance will not cause an adverse impact on surrounding property, property values, or the use and enjoyment of property in the neighborhood or zoning district.

See attached.

The Zoning Board of Appeals (ZBA) will review the application package and determine if the proposed Dimensional Variance meets the required standards for approval. In the space below, and on additional paper if necessary, explain how the proposed project meets each of the following standards. (Increased costs associated with complying with the Zoning Ordinance will not be considered a basis for granting a Dimensional Variance.)

Standard #1. Circumstances or Physical Conditions.


Explain the circumstances or physical conditions that apply to the property that do not apply generally to other properties in the same zoning district or in the general vicinity.

Circumstances or physical conditions may include:

- a. **Shape of Lot.** Exceptional narrowness, shallowness or shape of a specific property in existence on the effective date of the Zoning Ordinance or amendment. **Applicable,** described below:

The need for a variance is due to unique circumstances peculiar to this property. These conditions create an unnecessary hardship that requires relief. The property is irregularly shaped. The unusual shape of the property is a polygon with uneven lengths and 11 unique bearings. Berm construction would be irregular and haphazard if were to follow the East, South and West property lines. Additionally, the geometry of the property lines would have the berm changing direction several times creating an unusual and impractical configuration winding through the existing woodlands that won't serve the purpose intended. A berm is provided at the north property line parallel with the existing street and situated in a standard configuration to provide intended screening between residential properties. The City of Novi Ordinance Section 3104 allows the Zoning board of Appeals to permit the elimination of the berm requirement prescribed in the Zoning Ordinance because the property line configuration clearly demonstrates that the Shape of the Property is so unique that the circumstances are not generally applicable to other rectilinear properties. This property meets the required legal standard.


Exhibit 1: Shape of Property

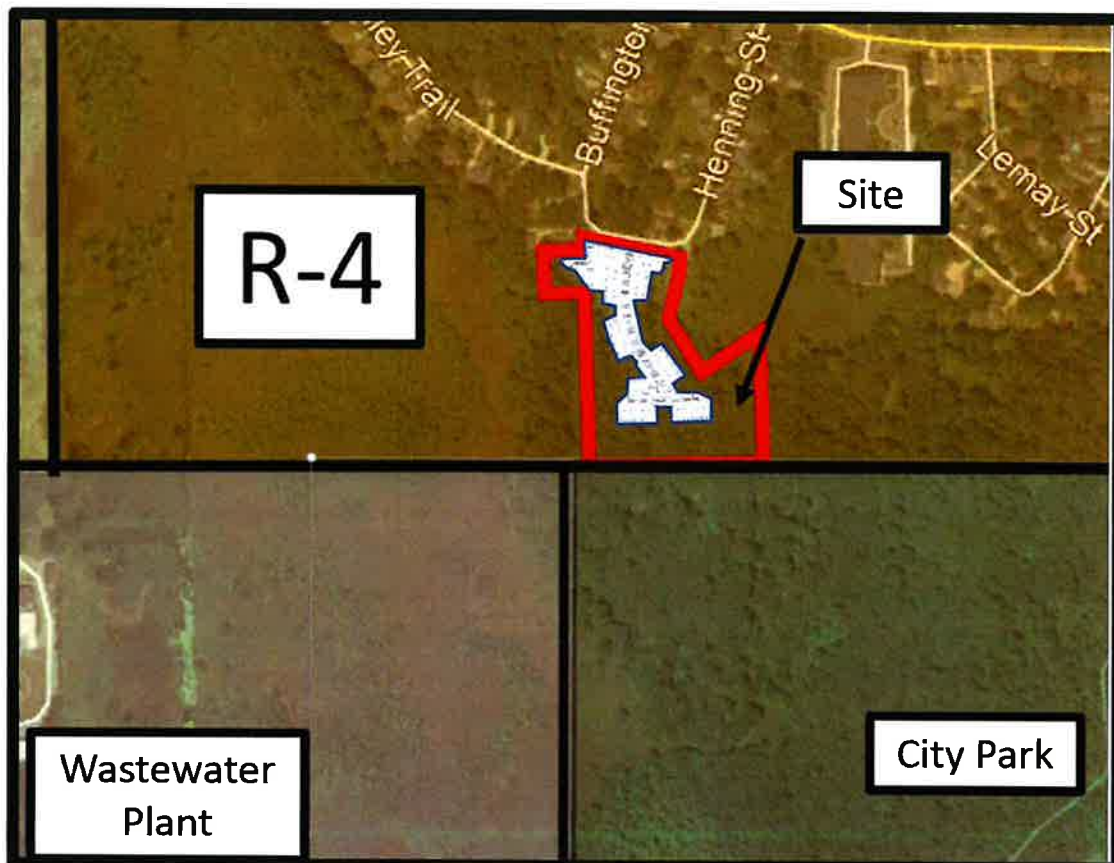

- b. **Environmental Conditions.** Exceptional topographic or environmental conditions or other extraordinary situations on the land, building or structure. **Applicable**, described below:

The need for a variance is due to unique circumstances peculiar to this property. These conditions create an unnecessary hardship that requires relief. The Site Area is 9.44 AC gross and includes 1.7 Ac of regulated wetlands and 7.45 Ac of regulated woodland that constitute 80% of the net acreage. These natural features are an important element for the property and surrounding community. The site plan strives to preserve the natural features to maximum affect by utilizing the City of Novi Cluster option which permits clustering of the units on the interior of the site to leave large sections undisturbed. The undisturbed area acts as a natural buffer between properties. The requirement to cut down trees and impact wetlands to construct a screening berm in the middle of the existing woods is impractical and undesirable. The existence of the abundant natural features on the site is the environmental condition that creates and extraordinary situation requiring relief. The City of Novi Ordinance Section 3104 allows the Zoning board of Appeals to permit the elimination of the screening berm requirement prescribed in the Zoning Ordinance because the large quantity of natural feature demonstrate that Environmental Conditions exist on the property that do not apply generally to other properties. This site clearly meets the legal standard.

Exhibit 2: Environmental Conditions

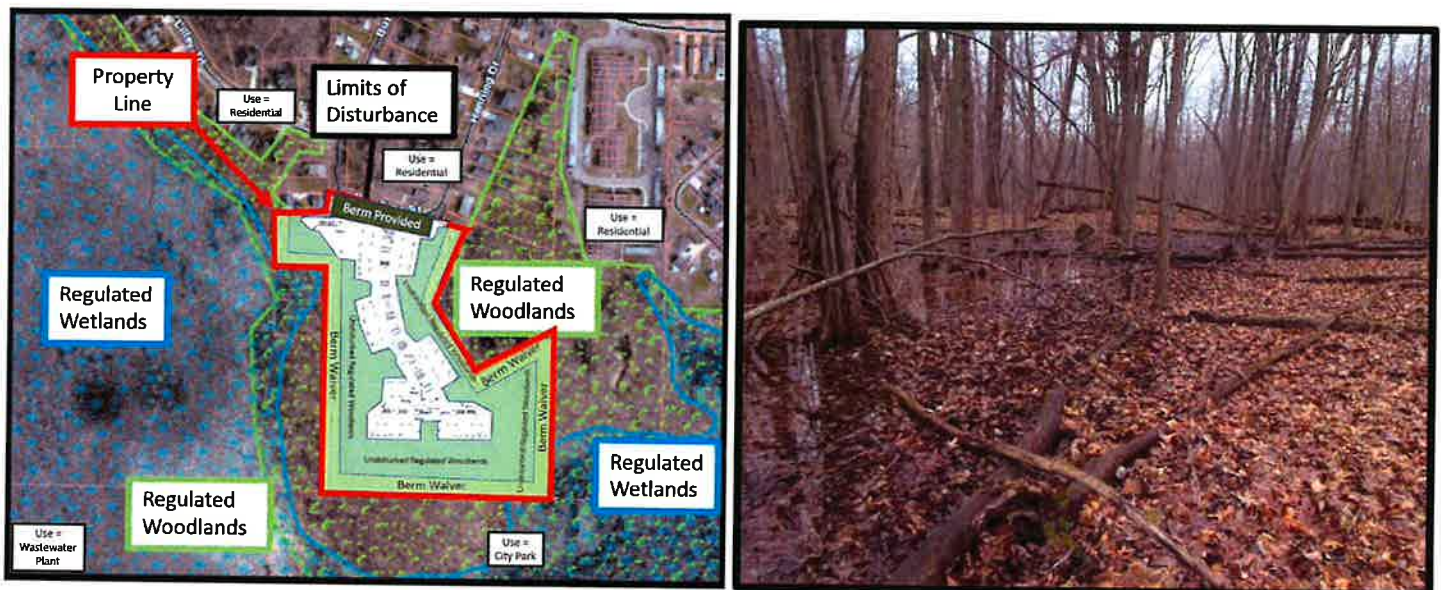

- c. **Abutting Property.** The use or development of the property immediately adjacent to the subject property would prohibit the literal enforcement of the requirements of the Zoning Ordinance or would involve significant practical difficulties. **Not Applicable/Not Required.**

Standard #2. Not Self-Created.

Describe the immediate practical difficulty causing the need for the Dimensional Variance, that the need for the requested variance is not the result of actions of the property owner or previous property owners (i.e., is not self-created).

The applicant's problem is not self-created. The problem is an unnecessary hardship on the property owner requiring relief. Per City of Novi Zoning section 3.28.6.C the Planning Commission can and on 9/25/2019 did approve a reduction to building setbacks to preserve the natural features of the site. Commission approved a reduction of front building setbacks from the streets from 30 feet from the edge of pavement to 25 feet in order to protect regulated woodlands in the back yards. The approval was conditioned on a ZBA variance for elimination of the berms in question. The reason the Planning Commission could not waive the berm requirement themselves is because Section

3.28.6.C.iv.a wording says single-family residential "districts" rather than single-family residential "use." The wording of the ordinance inadvertently moves the jurisdiction out of Planning Commission purview regarding berm construction and places it into the jurisdiction of the ZBA as a zoning matter. This applicant did not write the ordinance and had no part in choice of words. The intent of the ordinance was to create berms between uses to protect adjacent neighbors from viewing non-standard configurations. The actual situation is there are no residential uses in proximity to the east, south, and west property lines and never will be. Those adjacent properties are zoned for residential uses but can never be developed as such. There is a city park to the east and south and a wastewater plant to the west. All the adjacent property is burdened with a 300 Ac wetland that is un-buildable. If the planners who wrote the ordinance has considered the possibility of a cluster development adjacent to permanent non-residential uses in a residential district, they may have had the foresight to include the phrase "residential use" rather than "residential district." Unfortunately, not every possible situation can be anticipated when the ordinances are being written and they did use the word "district" which make this a ZBA matter. The City planner is in full support of the variance, and as stated previously, the City Planning Commission has already approved it, subject to the ZBA granting the required variance to eliminate the required berm so a 75' natural buffer can remain. The City of Novi Ordinance Section 3104 allows the Zoning board of Appeals to permit the elimination of the berm requirement prescribed in the Zoning Ordinance because the narrative demonstrates that the elimination of the berm was not Self-Created. The legal standard has been met.

Exhibit 3: Condition created by Ordinance word selection

- C. Reduced setbacks subject to the Planning Commission making the following findings:
 - i. The proposed changes will not adversely affect neighboring properties;
 - ii. Density will not exceed that permitted in the district;
 - iii. Safe access is provided to the development; and
 - iv. The following conditions are met:
 - a. A landscape berm meeting the requirements of Section 5.5.3.A.i - ii is provided adjacent to other single family residential districts.

Standard #3. Strict Compliance.

Explain how the Dimensional Variance in strict compliance with regulations governing area, setback, frontage, height, bulk, density or other dimensional requirements will unreasonably prevent the property owner from using the property for a permitted purpose or will render conformity with those regulations unnecessarily burdensome.

The property cannot be reasonably used for the purposes permitted which creates an unnecessary hardship. On 9/25/2019 the Planning commission unanimously approved the Scenic Pines Estates JSP 18-76 Special Land Use Permit, Preliminary Site Plan with One-Family clustering option and site condominium, Wetland Permit, Woodland Permit, and Stormwater Management Plan. Without ZBA approval of elimination of the berm, supported by planning staff and Planning Commission, the property owner will be unreasonably prevented from using the property for the approved and permitted purpose. Strict compliance with the berm requirement would render the City of Novi cluster option unavailable without cutting down the natural features it aims to protect. The clustered development area has

prescribed dimensional constraints, separations and requirements that limit the amount of development area. If berms were required within the development area, the area to build homes and infrastructure would be unavailable and the cluster option unobtainable. The spirit and intent of the cluster ordinance could not be achieved WITHOUT the variance. The City of Novi Ordinance Section 3104 allows the Zoning board of Appeals to permit the elimination of the berm requirement prescribed in the Zoning Ordinance because strict compliance with the berm requirement will unreasonably prevent use of the property in the permitted manner and the legal standard has been met.

Standard #4. Minimum Variance Necessary.

Explain how the Dimensional Variance requested is the minimum variance necessary to do substantial justice to the applicant as well as to other property owners in the district.

The variance requested is the minimum variance necessary. The 75' setback required by the City of Novi Cluster Option Ordinance along the three property lines in question will remain in full force and affect and will protect and preserve regulated woodland and wetlands along those property lines. The North property line is not included in this request because a berm can be built at that location without clearing abundant natural features to make way for the berm. The City of Novi Ordinance Section 3104 allows the Zoning board of Appeals to permit the elimination of the berm requirement prescribed in the Zoning Ordinance for three of the four property lines because the facts above demonstrate that the elimination of the requirement is limited to the east, west and south property lines, but EXCLUDES the north property line and is the minimum variance necessary to do substantial justice to the applicant as well as to other property owners in the district by preserving and protecting natural features rather than building a berm. The proposal meets the legal standard.

Standard #5. Adverse Impact on Surrounding Area.

Explain how the Dimensional Variance will not cause an adverse impact on surrounding property, property values, or the use and enjoyment of property in the neighborhood or zoning district.

The variance will not alter the essential character of the area but will actually enhance the character. Clearing the regulated woodlands creates an unnecessary hardship on both the property owner and the adjacent neighboring properties due to the loss of significant natural features. The spirit of the Zoning Ordinance is observed because the proposed 75' wide undisturbed regulated woodlands and wetlands on the eastern, southern, and western property lines create a natural buffer between the property and the adjacent districts so no adverse impacts will be introduced. These natural features provide a superior buffer than the alternative required by the zoning ordinance, from which we seek relief. Removal of these wonderful resources to build a less effective screening berm in their stead would be a disservice to the community and at the same time render the Cluster Option virtually pointless. Property values will not be diminished or impaired but instead will be enhanced through the preservation of the natural features for the property owner and adjacent parcels. The supply of light and air will remain exactly as they are in the existing condition by preserving the woodlands. Public safety is unaffected by the elimination of the berm because the berm requirement is not a public safety provision. Preserving the existing woodlands will not unreasonably increase the threat of fire danger because the woods currently exist naturally and is intermixed with 300 acres of wetland. The variance will not in any other respect impact the public health, safety, comfort, or morals or general welfare of residents. By granting this variance, substantial justice will be provided to the petitioner and surrounding property owners. The City of Novi Ordinance Section 3104 allows the Zoning board of Appeals to permit the elimination of the berm requirement prescribed in the Zoning Ordinance because the facts presented above demonstrate that the elimination of the berm requirement does not create an Adverse Impact on Surrounding Area and the proposed alternative meets the required legal standard.

Petitioner has met all requirements set forth to grant the variance.

All the Elements of Practical Difficulty exist. We respectfully request your support.

Exhibit 4: Enlarged version of site constraints and waiver locations


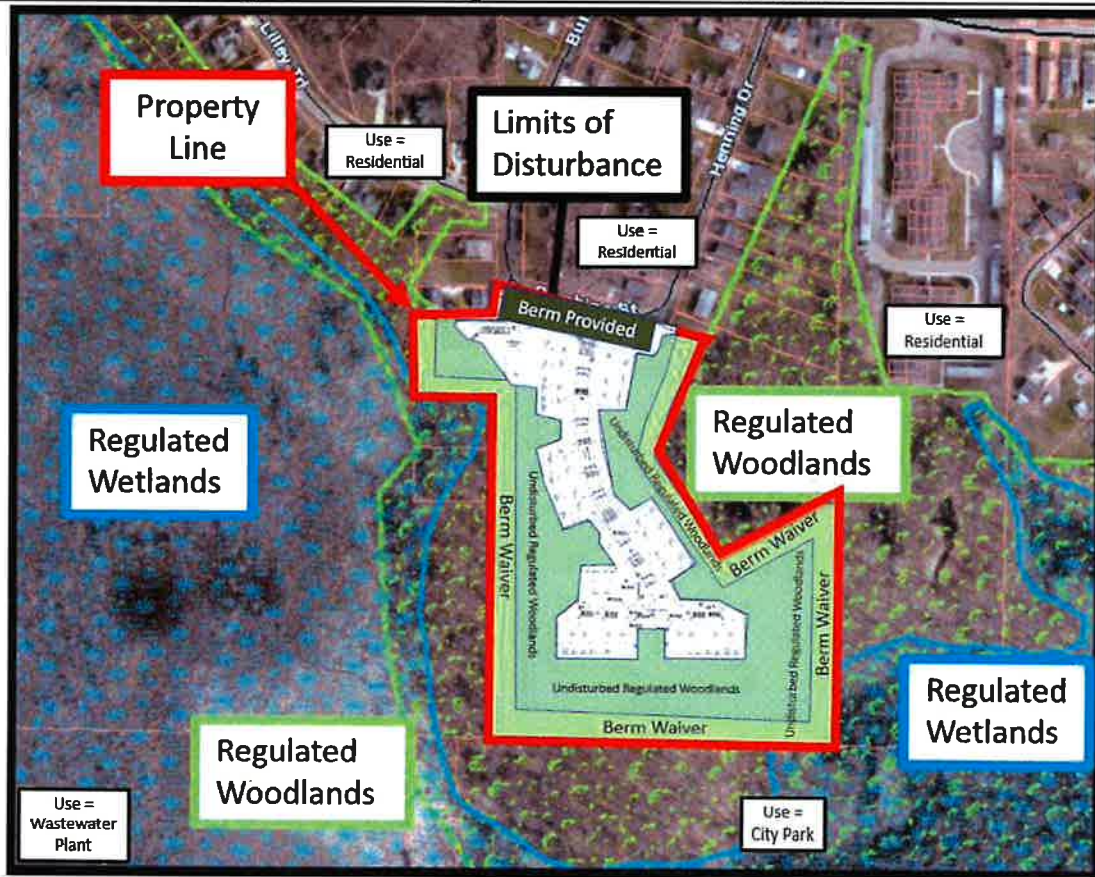


Exhibit 5: Enlarged version of surrounding zoning and site constraints

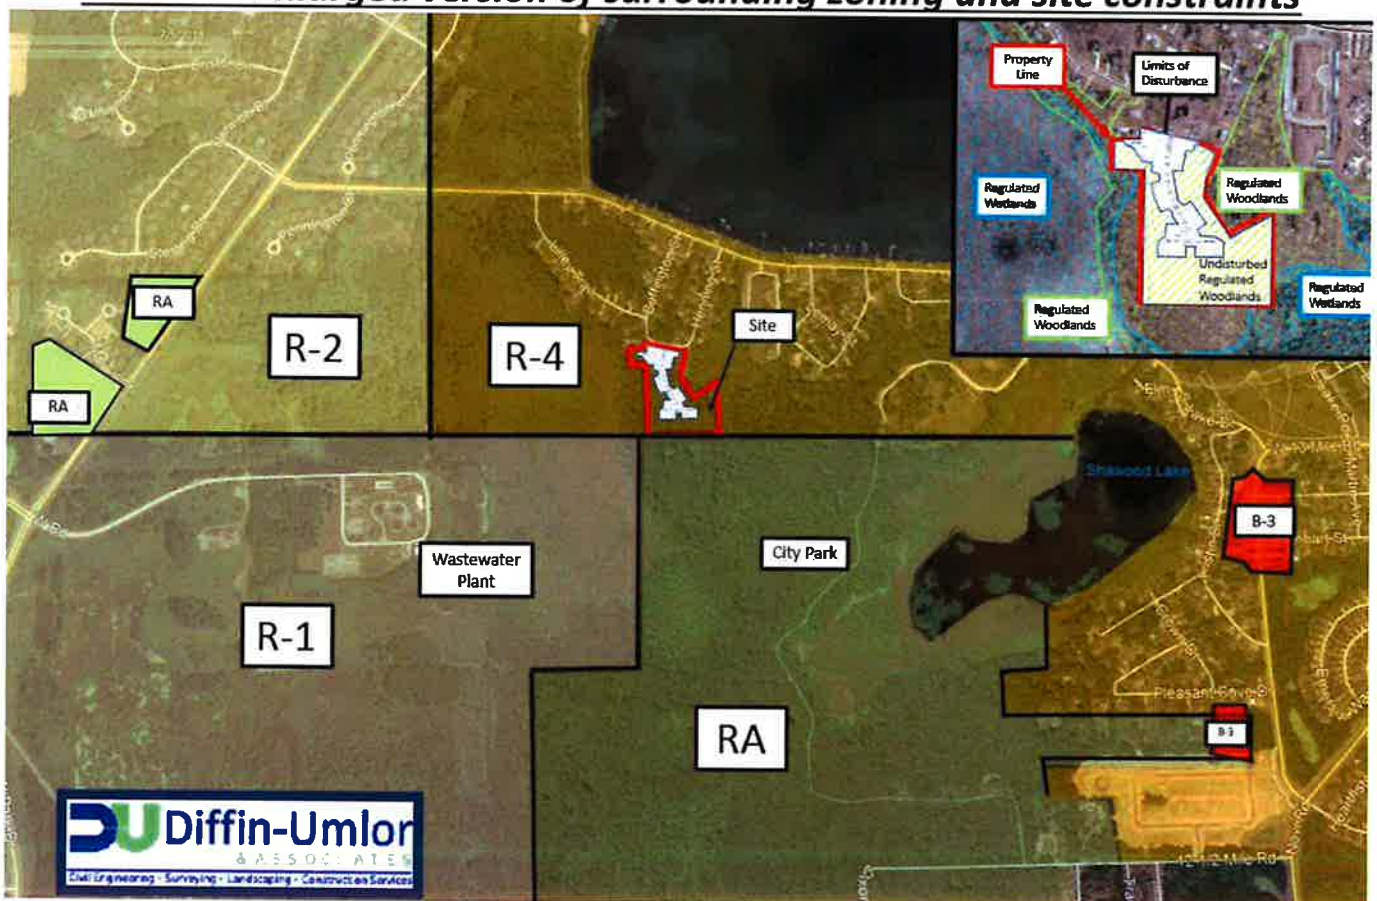

FINAL SITE PLAN/ENGINEERING DEVELOPMENT DRAWINGS

SCENIC PINES ESTATES

PROPOSED RESIDENTIAL DEVELOPMENT

CITY OF NOVI, OAKLAND COUNTY, MICHIGAN

SECTION 3, TOWN 1 NORTH, RANGE 8 EAST



CONTACT INFORMATION

CITY OF NOVI
CITY MANAGER
PETE AUGER
PHONE: (248) 347-0420
45175 WEST 10 MILE ROAD
NOVI, MI 48375

CITY OF NOVI
CITY PLANNER
BARBARA McBETH
PHONE: (248) 347-0475
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NOVI, MI 48375

CITY OF NOVI
PLANNER
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OAKLAND COUNTY, MI 48375

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LANDSCAPE ARCHITECT
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OAKLAND COUNTY, MI 48375

CITY OF NOVI
CITY REVIEW ENGINEER
KATE RICHARDSON
PHONE: (248) 347-045445175 TEN
MILE RD
OAKLAND COUNTY, MI 48375



ECT
WOODLANDS/WETLANDS CONSULTANT
PETE HILL
PHONE: (734) 769-3004
2200 COMMONWEALTH BLVD., SUITE 300
ANN ARBOR, MI 48105

SET BM
BM #10657
SET BM BENCH TIE EAST FACE
OF UTILITY POLE 18'± N SW PROP CORNER
132'± SW OF 18" RED OAK (TAG 175)
ELEV=933.59

BM #0194
SET BM TIE EAST FACE OF UTILITY POLE
267'± SOUTH OF PEMBINE RD 20'± WEST OF
14" RED OAK (TAG 22)

NOVI BM
BM ID: 333
X ON NORTH FLANGE BOLT OF FIRE HYDRANT
LOCATED 50 SOUTH OF VENTERLINE OF SOUTH
LAKE DRIVE AND WEST SIDE ENTRANCE TO
CONDOS #1127-1155 SOUTH LAKE DRIVE.

BM ID: 332
X ON NORTH RIM OF GATEWELL LOCATED 20
FEET NORTH OF VENTERLINE OF SOUTH LAKE
DRIVE AND BETWEEN HOUSES #1331 AND #1321
SOUTH LAKE DRIVE.

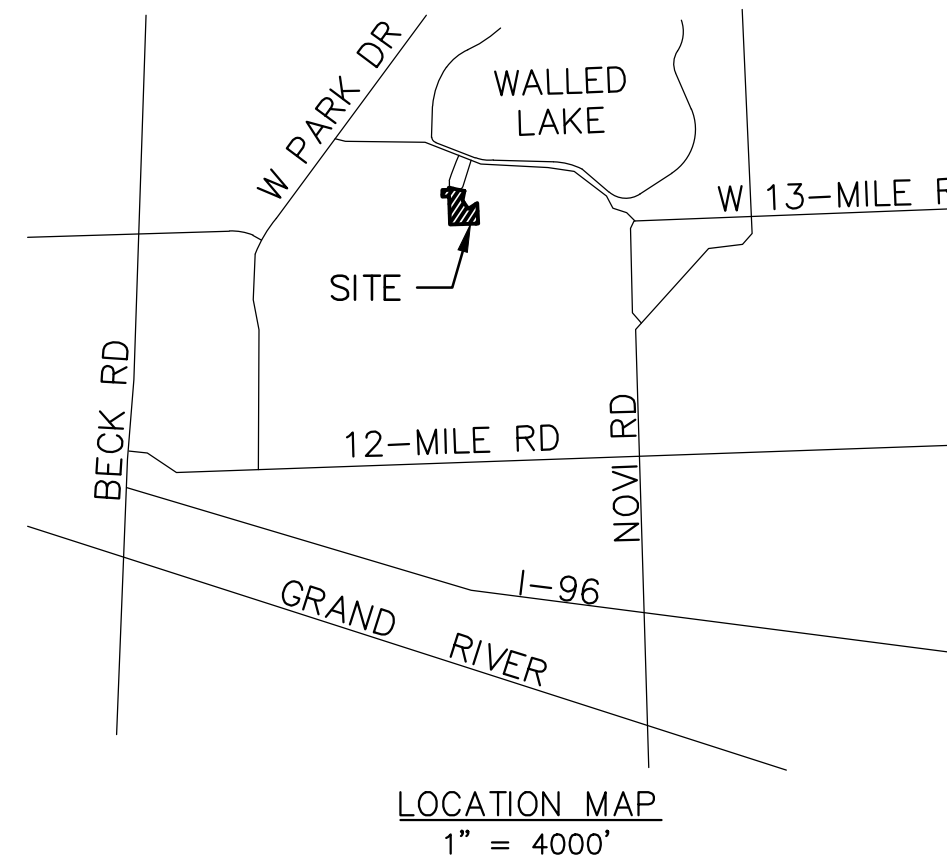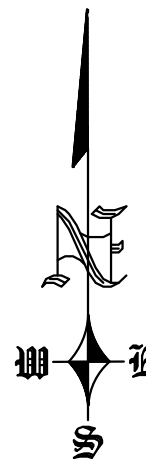

THE LOCATIONS OF EXISTING UNDERGROUND UTILITIES ARE SHOWN IN AN APPROXIMATE WAY ONLY AND HAVE NOT BEEN INDEPENDENTLY VERIFIED BY THE OWNER OR ITS REPRESENTATIVE. THE CONTRACTOR SHALL DETERMINE THE EXACT LOCATION OF ALL EXISTING UTILITIES BEFORE COMMENCING WORK, AND AGREES TO BE FULLY RESPONSIBLE FOR ANY AND ALL DAMAGES WHICH MIGHT BE OCCASIONED BY THE CONTRACTOR'S FAILURE TO EXACTLY LOCATE AND PRESERVE ANY AND ALL UNDERGROUND UTILITIES.



Know what's below.
Call before you dig.

CONSTRUCTION SITE SAFETY IS THE RESPONSIBILITY OF THE CONTRACTOR. NEITHER THE OWNER NOR THE ENGINEER SHALL BE EXPECTED TO ASSUME ANY RESPONSIBILITY FOR THE SAFETY OF THE WORK, OF PERSONS ENGAGED IN THE WORK, OF ANY NEARBY STRUCTURES, OR OF ANY OTHER PERSONS.

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LAND DEVELOPMENT SERVICES

APPROVED—PERMIT LIST

PRELIMINARY SITE PLAN APPROVED 9-25-2019

NOT APPROVED—PERMIT LIST

PRELIMINARY SITE PLAN CITY OF NOVI	APPROVED
FINAL SITE PLAN CITY OF NOVI	REQUIRED
CITY OF NOVI RIGHT-OF-WAY PERMIT CITY OF NOVI	ISSUED
GRADING PERMIT CITY OF NOVI	NOT APPROVED
RETAINING WALL PERMIT CITY OF NOVI	NOT APPROVED
SOIL EROSION AND SEDIMENTATION CITY OF NOVI	APPROVED
ACT 451 NOTICE OF COVERAGE: MICHIGAN DEPARTMENT OF ENVIRONMENTAL QUALITY	REQUIRED
PART 303 WETLAND PERMIT; MICHIGAN DEPARTMENT OF ENVIRONMENTAL QUALITY	ISSUED
WETLAND PERMIT, CITY OF NOVI	APPROVED
WETLAND BUFFER AUTHORIZATION	APPROVED
WOODLANDS PERMIT, CITY OF NOVI	APPROVED
PART 41 WASTEWATER SYSTEM PERMIT; MICHIGAN DEPARTMENT OF ENVIRONMENTAL QUALITY	REQUIRED
ACT 399 WATER SYSTEM CONSTRUCTION PERMIT, MICHIGAN DEPARTMENT OF ENVIRONMENTAL QUALITY	APPROVED

REQUESTED VARIANCES:

- DRIVEWAY SPACING: WAIVER FOR THE MINIMUM OPPOSITE SIDE DRIVEWAY SPACING IS REQUESTED
- STREET TREE LOCATION: REQUEST TO NOT PLANT 3 STREET TREES DUE TO LACK OF ROOM AS A RESULT OF CLUSTERING
- CLUSTERS ARE REQUIRED TO BE 30' FROM EDGE OF PAVEMENT DRIVE. PROPOSED SET BACK FROM CURB IS 25' TO PRESERVE NATURAL FEATURE TO GREATEST EXTENT POSSIBLE CONSTANT WITH PRIOR APPROVAL (EXPIRED) WAIVER IS REQUESTED
- WAIVER REQUESTED FOR NOT MEETING THE MINIMUM DISTANCE BETWEEN THE SIDEWALK AND THE CURB IN LIMITED AREAS (IN FRONT OF UNITS ONLY)

ENGINEER/SURVEYOR



LAND DEVELOPMENT SERVICES

Wes Lee O. Umlor, P.E.

49287 WEST ROAD
WIXOM, MI 48393
Phone: (248) 773-7656
Fax: (866) 690-4307
E-mail: wumlor@umlorgroup.com
Web: www.umlorgroup.com Michigan

OWNER/DEVELOPER

SINGH DEVELOPMENT LLC

7125 ORCHARD LAKE ROAD
BLOOMFIELD HILLS, MICHIGAN 48322
PH: (248) 865-1600



WETLAND CONSULTANT

WILSON ROAD GROUP

303 W. NEPESSING ST
LAPEER, MI 48446
PH: (810) 664-6300

LANDSCAPE ARCHITECT

ALLEN DESIGN

PH: (248) 467-4669
EMAIL: JCA@WIDEONWEST.COM


GEOTECHNICAL CONSULTANT

MCDOWELL & ASSOCIATES

DAVID QUINTAL (248) 399-2066
EMAIL: DAVID.QUINTAL@MCDOWASC.COM

SITE MAP

SCALE: 1"=200'

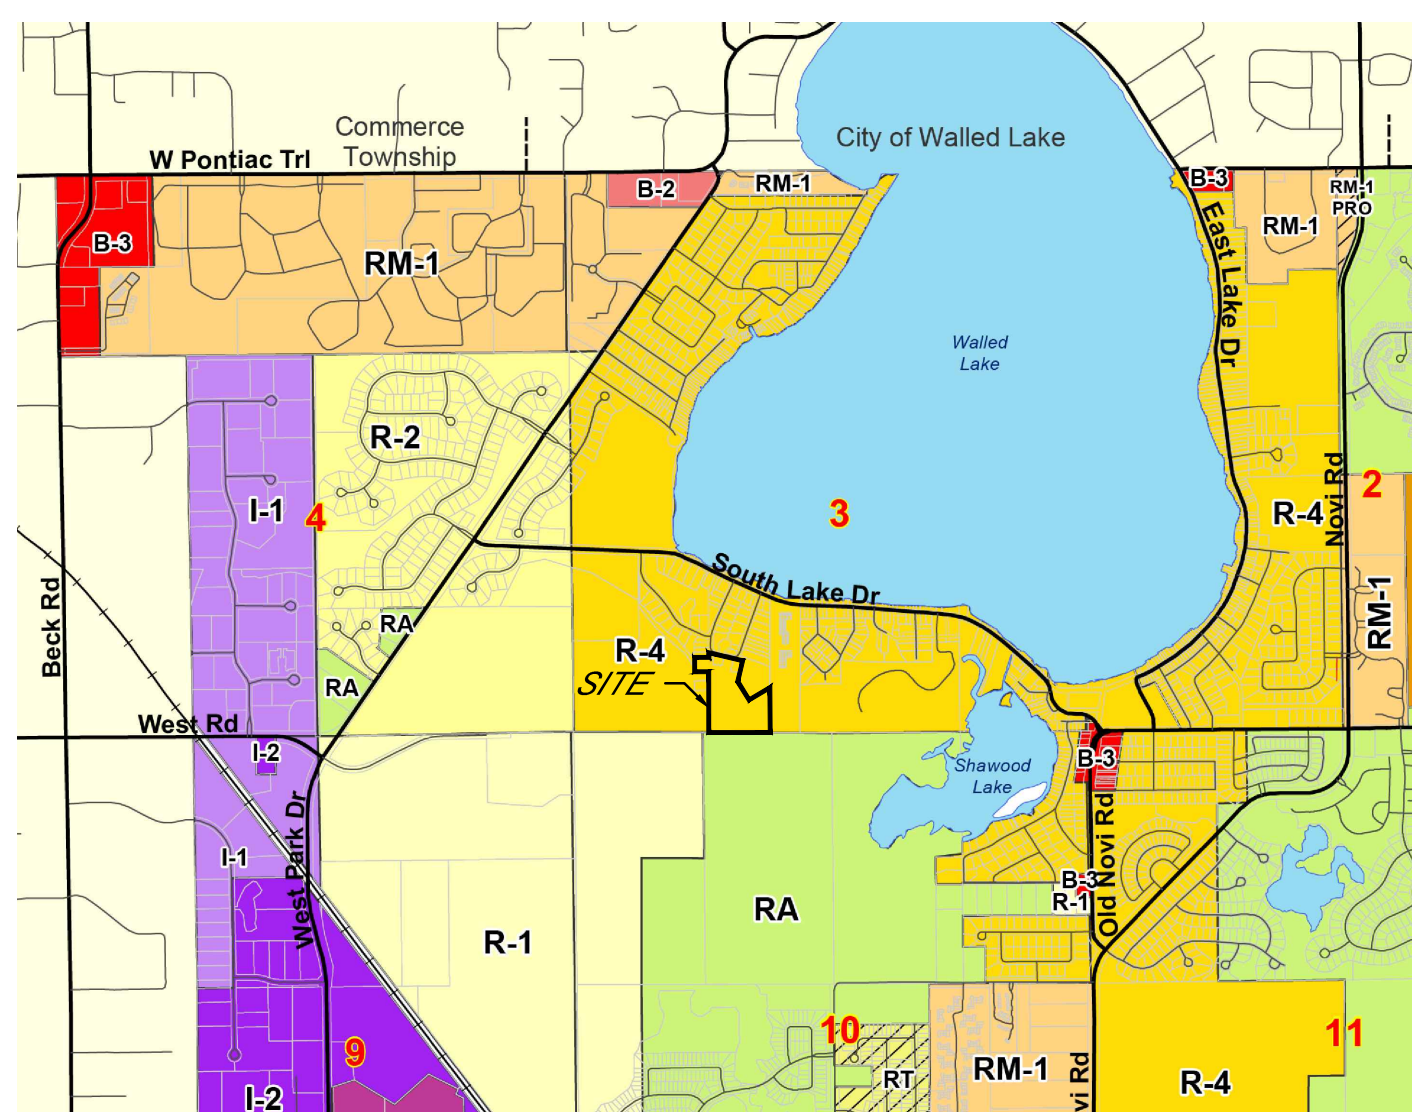

ZONING DISTRICT MAP

SCALE: 1"=200'

Zoning Districts	
R-A: Residential Acreage	GE: Gateway East
R-1: One-Family Residential	FS: Freeway Service
R-2: One-Family Residential	I-1: Light Industrial
R-3: One-Family Residential	I-2: General Industrial
R-4: One-Family Residential	NCC: Non-Center Commercial
RT: Two-Family Residential	OS-1: Office Service
RM-1: Low-Density Multiple-Family	OSC: Office Service Commercial
RM-2: High-Density Multiple-Family	OST: Office Service Technology
MH: Mobile Home	EXO: OST District with EXO Overlay
B-1: Local Business	RC: Regional Center
B-2: Community Business	P-1: Vehicular Parking
B-3: General Business	TC: Town Center
C: Conference	TC-1: Town Center-1
EXPO: Expo	

GENERAL NOTES:

- ALL WORK SHALL CONFORM TO THE CITY OF NOVI'S CURRENT STANDARDS AND SPECIFICATIONS, UNLESS OTHERWISE APPROVED.
- ALL PAVEMENT MARKINGS, TRAFFIC CONTROL SIGNS, AND PARKING SIGNS SHALL COMPLY WITH THE DESIGN AND PLACEMENT REQUIREMENTS OF THE 2011 MICHIGAN MANUAL ON UNIFORM TRAFFIC CONTROL DEVICES.
- CONTRACTOR TO FIELD VERIFY ALL EXISTING UTILITY LOCATIONS, INVERTS AND GRADES PRIOR TO START OF WORK.
- TWO (2) COPIES OF AS-BUILT PLANS SHALL BE SUBMITTED TO THE CITY ENGINEER WITHIN THIRTY (30) DAYS OF THE COMPLETION OF THE UTILITY INSTALLATION AS PER SECTION 31-7 (A) CITY OF NOVI ORDINANCE.
- CITY OF NOVI HAS NO RESPONSIBILITY TO IMPROVE OR MAINTAIN THE PRIVATE STREETS CONTAINED WITHIN OR PRIVATE STREETS PROVIDING ACCESS TO THE PROPERTY DESCRIBED IN THIS PLAN.
- "ECONOMIC IMPACT: 25 HOMES X \$500,000 (APPROX) = \$12,500,000 INCREASE TAX BASE AT BUILDOUT". HOME SIZE & EXPECTED SALES PRICE OF NEW HOMES: 1,800-2,200 Sq ft, \$450,000-\$600,000.
- THE SITE PLAN SHALL BE DESIGNED IN ACCORDANCE WITH THE DESIGN AND CONSTRUCTION STANDARDS (CHAPTER 11).

FIRE DEPARTMENT NOTES

- ALL FIRE HYDRANTS AND WATER MAINS SHALL BE INSTALLED AND IN SERVICE PRIOR TO ABOVE FOUNDATION BUILDING CONSTRUCTION.
- ALL ROADS SHALL BE PAVED AND CAPABLE OF SUPPORTING 35 TONS PRIOR TO CONSTRUCTION OF ABOVE FOUNDATIONS.
- BUILDING ADDRESSES SHALL BE POSTED FACING THE STREET DURING ALL PHASES OF CONSTRUCTION. ADDRESSES SHALL BE A MINIMUM OF THREE INCHES IN HEIGHT ON A CONTRASTING BACKGROUND.
- PROVIDE 4"-6" DIAMETER OF CONCRETE FILLED STEEL POST 48" ABOVE FINISH GRADE AT EACH HYDRANT AS REQUIRED.
- FIRE LANES SHALL BE POSTED WITH "FIRE LANE - NO PARKING" SIGNS IN ACCORDANCE WITH ORDINANCE #85.99.02.

THE LOCATIONS OF EXISTING UNDERGROUND UTILITIES ARE SHOWN IN AN APPROXIMATE WAY ONLY AND HAVE NOT BEEN INDEPENDENTLY VERIFIED BY THE OWNER OR ITS REPRESENTATIVE. THE CONTRACTOR SHALL DETERMINE THE EXACT LOCATION OF ALL EXISTING UTILITIES BEFORE COMMENCING WORK, AND AGREES TO BE FULLY RESPONSIBLE FOR ANY AND ALL DAMAGES WHICH MIGHT BE OCCASIONED BY THE CONTRACTOR'S FAILURE TO EXACTLY LOCATE AND PRESERVE ANY AND ALL UNDERGROUND UTILITIES.

ALL WORK SHALL CONFORM TO CITY OF NOVI & OAKLAND COUNTY STANDARDS AND SPECIFICATIONS.

THE CONTRACTOR SHALL BE RESPONSIBLE FOR THE PROTECTION OF AND/OR RELOCATION OF ALL UTILITIES THAT MAY INTERFERE WITH CONSTRUCTION.

NOTE: SEE ESTIMATED QUANTITIES ON SHEET 10

UTILITY WARNING

UNDERGROUND UTILITY LOCATIONS AS SHOWN ON THE PLAN, WERE OBTAINED FROM UTILITY OWNER AND NOT FIELD LOCATED.

CITY OF NOVI / OAKLAND CO. STANDARD DETAILS

- PAVEMENT DETAILS
- STORM SEWER DETAILS
- SANITARY SEWER DETAILS NO. 1
- SANITARY SEWER DETAILS NO. 2
- WATER SYSTEM DETAILS NO. 1
- WATER SYSTEM DETAILS NO. 2
- LANDSCAPE DETAILS
- DETAILS FOR PATHWAYS & BOARDWALKS

SITE DATA:

GROSS ACREAGE	9.44 AC.
PROPOSED RIGHT OF WAY	0.13 AC.
NET SITE ACREAGE (PRESERVATION)	9.31 AC.
REGULATED WETLANDS	1.70 AC.
NET SITE ACREAGE (DENSITY)	7.61 AC.
PROPOSED DENSITY	3.3 DU AC.
RESIDENTIAL UNITS PERMITTED	25.146 UNITS
RESIDENTIAL UNITS PROPOSED	25 UNITS
PERCENT OF SITE THAT IS REGULATED WOODLANDS	79%
REGULATED WOODLANDS ACREAGE	7.45
ACRES OF WOODLANDS TO REMAIN	4.96
PERCENT OF SITE PERMANENTLY PRESERVED	53.3% (4.96 AC.)
TREES REMOVED	220
REPLACEMENT TREES REQUIRED	
CURRENT ZONING	R-4 ONE FAMILY RESIDENTIAL
PROPOSED ZONING	R-4 ONE FAMILY RESIDENTIAL
MASTER PLAN	-CLUSTER OPTION SINGLE FAMILY RESIDENTIAL



DATE:	11-27-2019
REVISIONS	
PER CITY 03-24-2020	
PER CITY 10-12-2020	
PER CITY 01-18-2021	
DR BY:	SDT
CK BY:	SDT/JMY
P.M.	SA
SCALE	0
AS NOTED	
JOB NO.	180905
SHEET NO.	1
SHEET 1 OF 38	

NOTE:

- EXISTING ROADS SHALL BE MAINTAINED DURING CONSTRUCTION AND RECONSTRUCTED AS NECESSARY UPON COMPLETION OF CONSTRUCTION.
- DUST CONTROL TECHNIQUES SHALL BE EMPLOYED FOR THE DURATION OF SITE CONSTRUCTION ACTIVITIES.
- EXISTING ROADS SHALL BE DOCUMENTED VIA VIDEO TAPE PRIOR TO CONSTRUCTION. UPON COMPLETION OF CONSTRUCTION, EXISTING ROADS SHALL BE RE-VIDEO TAPED TO DETERMINE RECONSTRUCTION REQUIREMENTS, IF ANY.
- CONSTRUCTION ACTIVITIES SHALL BE COORDINATED WITH RESPECT TO THE ELEMENTARY SCHOOL BUS SCHEDULE.

INTERNATIONAL FIRE CODE NOTES:

- SHOWS THE 120' HAMMERHEAD ACCESS ROAD DIMENSIONAL REQUIREMENTS IN SECTION D103.1 (20' WIDE LANES, 28' RADIUS, MIN 60 LONG EACH LEG)
- TABLE D103.4 SHOWS NO TURN AROUND IS REQUIRED FOR 150' LONG DEAD END. THE HAMMERHEAD IS THE TURN AROUND FOR PRISTINE LANE WE HAVE TWO 150' DEAD ENDS.

D103.1 Access road width with a hydrant.

Where a fire hydrant is located on a fire apparatus access road, the minimum road width shall be 26 feet (7925 mm), exclusive of shoulders (see Figure D103.1).

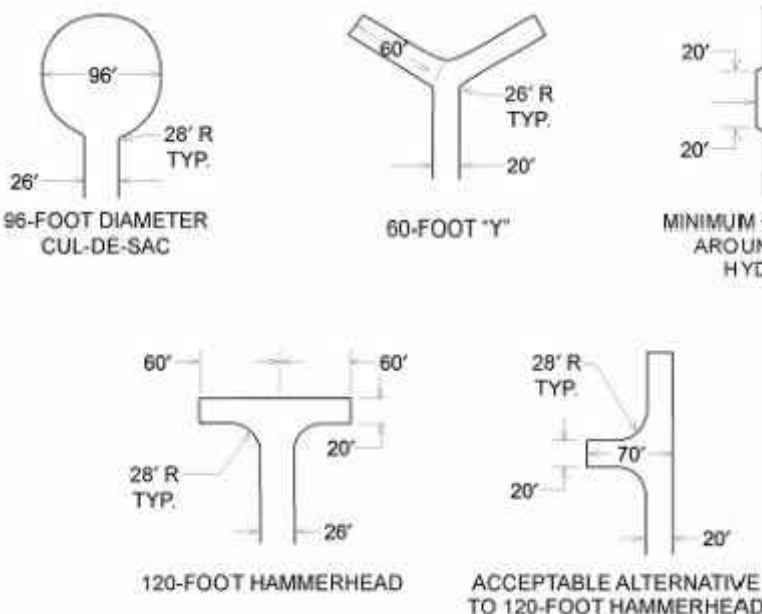


TABLE D103.4
REQUIREMENTS FOR DEAD-END
FIRE APPARATUS ACCESS ROADS

LENGTH (feet)	WIDTH (feet)	TURNAROUNDS REQUIRED
0-150	20	None required
151-500	20	120-foot Hammerhead, 60-foot "Y" or 96-foot diameter cul-de-sac in accordance with Figure D103.1
501-750	26	120-foot Hammerhead, 60-foot "Y" or 96-foot diameter cul-de-sac in accordance with Figure D103.1
Over 750		Special approval required




PROPOSED CLUSTER SEPARATION TABLE


CLUSTER 1	CLUSTER 2	TOTAL NUMBER OF HOMES	MINIMUM DISTANCE REQUIRED (FRONT & REAR)	PROPOSED (FRONT & REAR)	MINIMUM DISTANCE REQUIRED(SIDE)	PROPOSED (SIDE)
8-9-10-11	4-5-6-7	8	100	105, N/A	75	N/A
18-19-20-21	4-5-6-7	8	100	N/A	75	N/A
4-5-6-7	12-13-14-15	8	100	138, N/A	75	N/A
1-2-3	22-23-24-25	7	85	78, N/A	75	N/A
1-2-3	18-19-20-21	7	85	N/A	75	N/A
12-13-14-15	16-17	6	75	75, N/A	60	N/A
4-5-6-7	16-17	6	75	83, N/A	60	N/A
8-9-10-11	16-17	6	75	N/A	60	N/A
8-9-10-11	12-13-14-15	8	100	N/A	75	75
22-23-24-25	18-19-20-21	8	100	N/A	75	75
1-2-3	4-5-6-7	7	85	N/A	75	199
18-19-20-21	16-17	6	75	N/A	60	105

GENERAL NOTES:
THE LOT LOCATED ON THE NORTH SIDE OF SOUTH LAKE DRIVE (50-22-03-327-004) IS NOT PART OF THIS SITE PLAN, NO CHANGES TO THAT LOT ARE PROPOSED BY APPLICANT. APPROVAL OF THIS SITE PLAN DOES NOT INCLUDE SITE PLAN APPROVAL FOR THAT LOT.

NOTE:
ALL UNITS SHOWN PROVIDE 6 FEET OF SEPARATION BETWEEN BUILDINGS. PER SECTION 3.28, 4. B MINIMUM BETWEEN UNITS WITH WALLS WITH OPENINGS: 10 FEET MINIMUM BETWEEN UNITS WITH WALLS WITH NO OPENINGS: 6 FEET

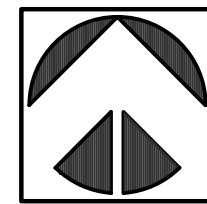

NORTH

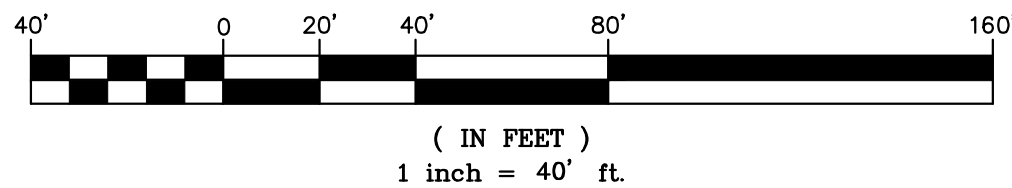

LEGEND

SYMBOL	DESCRIPTION
	PR ASPHALT
	PR CONC
	PR CROSS WALK
	PR DEVELOPED OPEN SPACE
	PRESERVED WOODLANDS OPEN SPACE

SIGN TABLE


SIGN #	SIGN TYPE	REQUIRED
R1-1	STOP (30")	2
D3-2	STREET NAME SIGN	2
R8-3A	NO PARKING (18")	8

- NOTES:**
- ALL SIGNS WILL COMPLY WITH CURRENT 2011 MMUTCD STANDARDS
 - ALL TRAFFIC CONTROL SIGNS WILL COMPLY WITH FHWA STANDARD ALPHABET SERIES.
 - ALL TRAFFIC CONTROL SIGNS WILL USE HIGH INTENSITY PRISMATIC (HIP) SHEETING TO MEET FHWA RETRO-REFLECTIVITY REQUIREMENTS.
 - CITY OF NOVI HAS NO RESPONSIBILITY TO IMPROVE OR MAINTAIN THE PRIVATE STREETS WITHIN OR PRIVATE STREETS PROVIDING ACCESS TO THE PROPERTY DESCRIBED IN THIS PLAN.

SITE DATA

SITE AREA	9.44 AC.
R.O.W. DEDICATION	0.13 AC.
NET SITE AREA (PRESERVATION)	9.31 AC.
REGULATED WETLANDS	1.70 AC.
NET SITE AREA (DENSITY)	7.61 AC.
PROPOSED DENSITY	3.3 UNITS/AC.
RESIDENTIAL UNITS PERMITTED	25,146
RESIDENTIAL UNITS PROPOSED	25
REGULATED WOODLAND	7.45 AC.
RWA/NSA (7.45/9.31)	80%
WOODLANDS REQUIRED TO REMAIN	4.67 AC.
PERCENT OF SITE PERMANENTLY PRESERVED	53.3% (4.96 AC.) (CLUSTER OPTION)
MAX. LOT COVERAGE < 25%	
(ALL BUILDINGS)	
MIN. FLOOR AREA > (1000 Sq ft)	1,318-1,518 Sq ft
MAX. BUILDING HEIGHT	35 (2.5 STORIES)
BUILDING HEIGHT PROVIDED	30
TOTAL LOT COVERAGE (BUILDING TOTAL)	35'x50'=1,750 SQ-FT./UNIT x 17 = 29,750 SQ-FT., 32'x50'=1,600 SQ-FT./UNIT x 8 = 12,800 SQ-FT., 29,750 +12,800 = 42,550 SQ-FT. = 0.98 ACRES
	0.98 AC/9.31 AC. = 10.52% < 25%
	25,009 Sq ft

PROPOSED PRIVATE ROAD PAVEMENT AREA

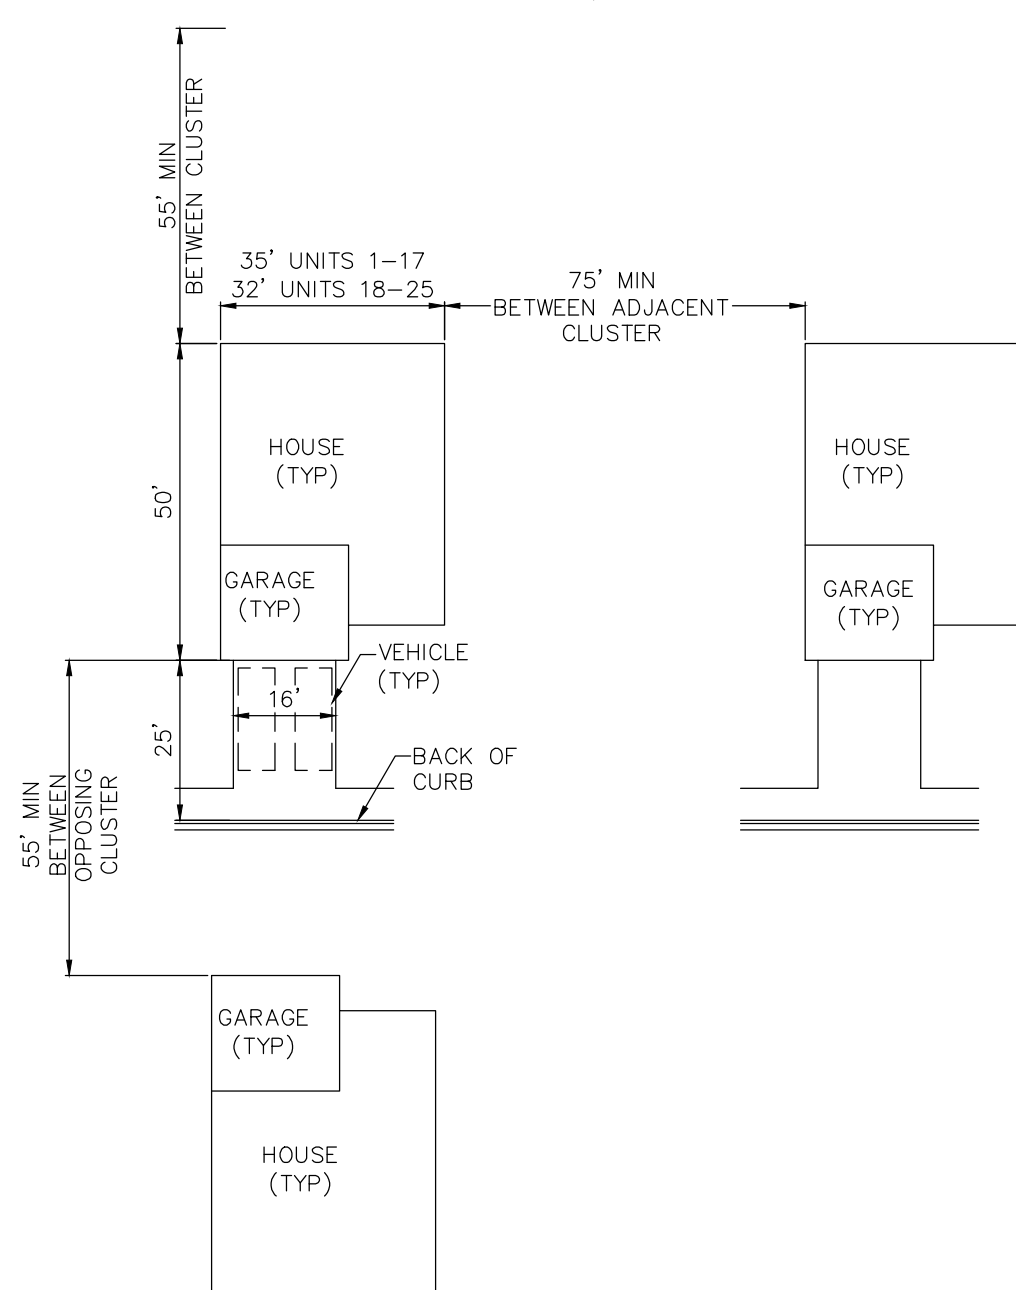

NOTE:

- TRASH SHALL BE WEEKLY CURB SIDE PICKUP
- PER SECTION 26.5-35(C), A STATEMENT IS REQUIRED ON ANY PLAN CONTAINING A PRIVATE STREET WITH THE FOLLOWING LANGUAGE: "CITY OF NOVI HAS NO RESPONSIBILITY TO IMPROVE OR MAINTAIN THE PRIVATE STREETS CONTAINED WITHIN OR PRIVATE STREETS PROVIDING ACCESS TO THE PROPERTY DESCRIBED IN THIS PLAN".



THE LOCATIONS OF EXISTING UNDERGROUND UTILITIES ARE SHOWN IN AN APPROXIMATE WAY ONLY AND HAVE NOT BEEN INDEPENDENTLY VERIFIED BY THE OWNER OR ITS REPRESENTATIVE. THE CONTRACTOR SHALL DETERMINE THE EXACT LOCATION OF ALL EXISTING UTILITIES BEFORE COMMENCING WORK, AND AGREES TO BE FULLY RESPONSIBLE FOR ANY AND ALL DAMAGES WHICH MIGHT BE OCCASIONED BY THE CONTRACTOR'S FAILURE TO EXACTLY LOCATE AND PRESERVE ANY AND ALL UNDERGROUND UTILITIES.



Know what's below. Call before you dig.


CONSTRUCTION SITE SAFETY IS THE RESPONSIBILITY OF THE CONTRACTOR. NEITHER THE OWNER NOR THE ENGINEER SHALL BE EXPECTED TO ASSUME ANY RESPONSIBILITY FOR SAFETY OF THE WORK, OF PERSONS ENGAGED IN THE WORK, OF ANY NEARBY STRUCTURES, OR OF ANY OTHER PERSONS.

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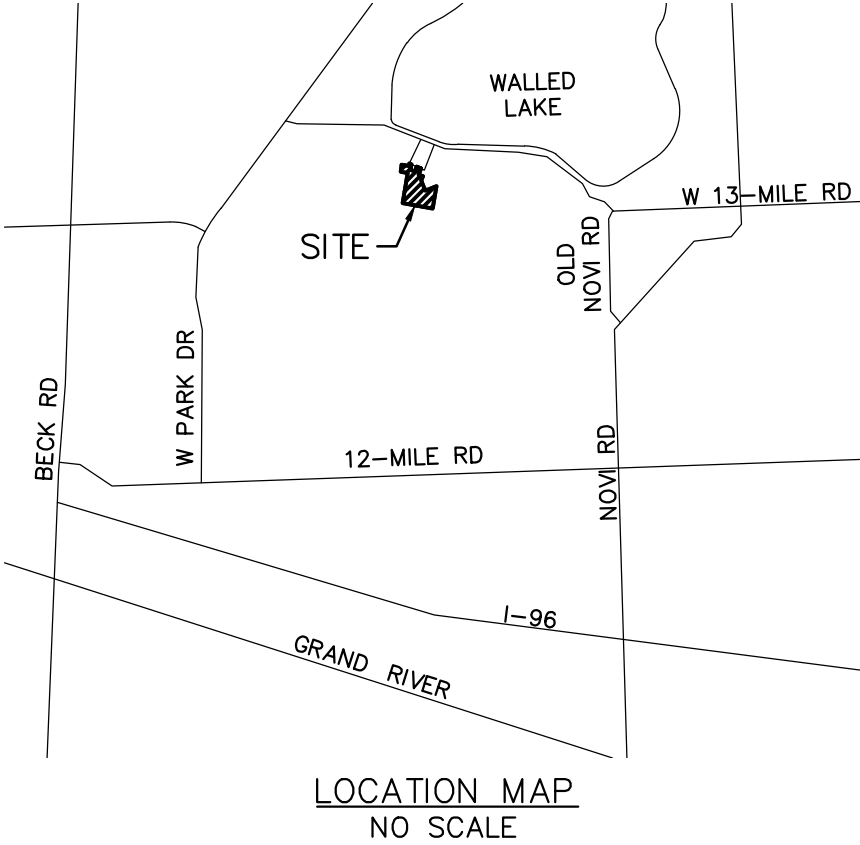
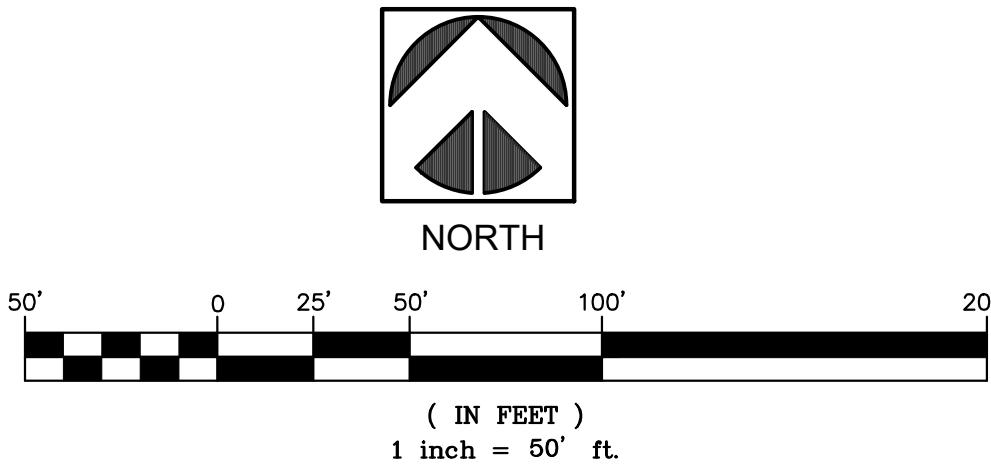


SECTION 3	TOWN 1 NORTH, RANGE 8 EAST	CITY OF NOVI	OAKLAND COUNTY, MICHIGAN
SCENIC PINES	SINGH DEVELOPMENT, LLC. 7125 ORCHARD LAKE ROAD BLOOMFIELD HILLS, MICHIGAN 48322	SITE PLAN	
CLIENT:			
DATE:	11-27-2019		
REVISIONS			
PER CITY 03-24-2020			
PER CITY 10-12-2020			
PER CITY 01-18-2021			
OR BY: SDT			
CK BY: SDT/JMY			
P.M. SA			
SCALE 0 20 40			
1" = 40 FEET			
JOB NO. 180905			
SHEET NO. 2			
SHEET 2 OF 38			



Map Unit Symbol	Map Unit Name
13B	Oshtemo-Boyer loamy sands, 0 to 6 percent slopes
27	Houghton and Adrian mucks
54A	Mather-ton sandy loam, 0 to 3 percent slopes
40A	Udorthents, loamy, nearly level

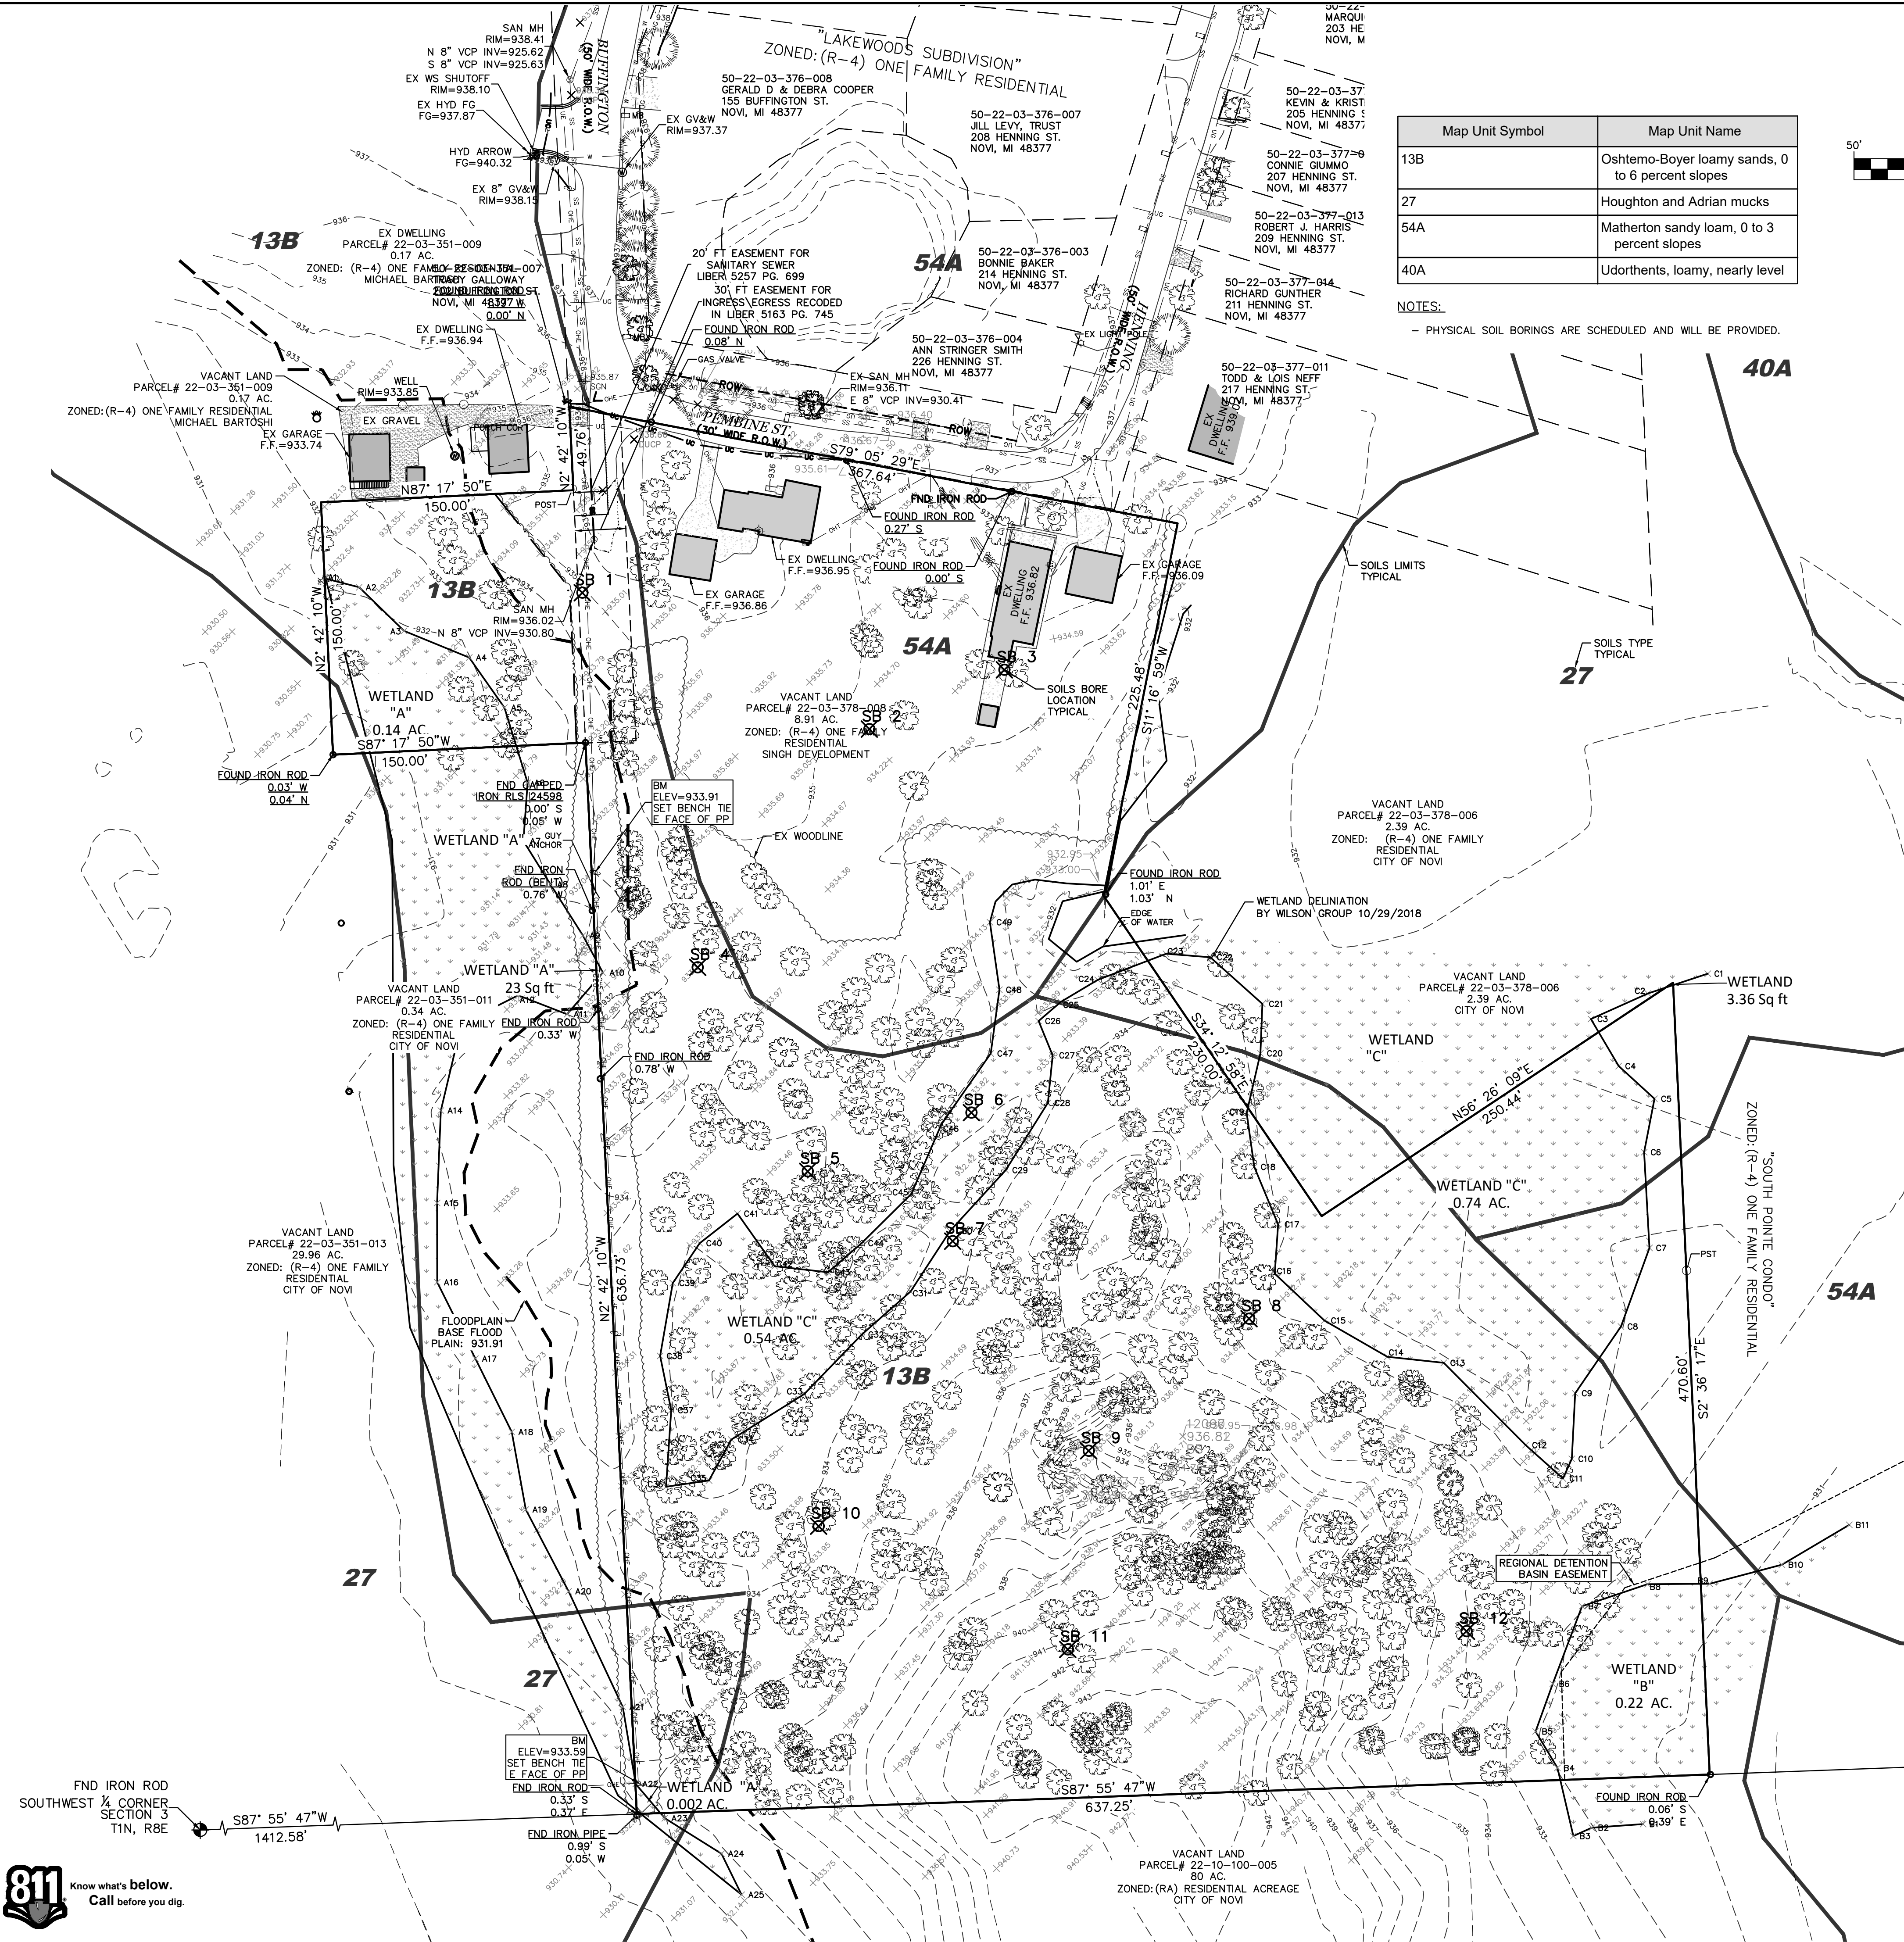NOTES:
- PHYSICAL SOIL BORINGS ARE SCHEDULED AND WILL BE PROVIDED.



LEGEND					
SYMBOL	DESCRIPTION	SYMBOL	DESCRIPTION	SYMBOL	DESCRIPTION
	CLEAN OUT		SIGN		EX STORM
	ELEC. RISER		2 POLE SIGN		EX SANITARY
	FIRE HYDRANT		MAILBOX		EX WM
	ELEC. TRANSFORMER		POST		ELEC OVERHEAD
	GUY ANCHOR		ELECTRICAL RISER		UNDERGROUND ELECTRIC
	STM. MANHOLE		TELEPHONE RISER		GAS
	SAN. MANHOLE		COMMUNICATIONS RISER		FENCE
	VENT		ELECTRICAL METER		SILT FENCE
	WATER STOP BOX		EXISTING FLAG POLE		EX FIBER OH
	GATE VALVE		EXISTING GENERATOR		EX GUARDRAIL
	SPEAKER BOX		EXISTING SIGNAL POLE		EX WETLAND BUFFER
	POWER POLE		EXISTING GAS METER		EX GRAVEL
	SINGLE LIGHT POLE		SET IRON		EX ASPHALT
	DOUBLE LIGHT POLE		FOUND IRON		EX CONCRETE
	ROUND CATCH BASIN		RECORDED DISTANCE		REGULATED TREE
	SQUARE CATCH BASIN		MEASURED DISTANCE		
	SOIL BORE LOCATION				

SET BM
BM #70657
SET BM BENCH TIE EAST FACE
OF UTILITY POLE 18'± N SW PROP CORNER
132'± SW OF 18" RED OAK (TAG 175)
ELEV=933.59

BM #10194
SET BM THE EAST FACE OF UTILITY POLE
267'± SOUTH OF PEMBINE RD 20'± WEST OF
14" RED OAK (TAG 22)

NOVI BM
BM ID: 333
X ON NORTH FLANGE BOLT OF FIRE HYDRANT
LOCATED 50 SOUTH OF VERNERLINE OF SOUTH
LAKE DRIVE AND WEST SIDE ENTRANCE TO
CONDOS #1127-1155 SOUTH LAKE DRIVE.

BM ID: 332
X ON NORTH RIM OF GATEWELL LOCATED 20
FEET NORTH OF VENTERLINE OF SOUTH LAKE
DRIVE AND BETWEEN HOUSES #1331 AND #1321
SOUTH LAKE DRIVE.

NOTES:

- FLOODPLAIN NOTE:
ACCORDING TO THE NATIONAL FLOOD INSURANCE RATE MAP COMMUNITY
PANEL NUMBER 26125C0480F DATED SEPTEMBER 29, 2006 PORTIONS OF
THE SITE ARE IN ZONE "X" (0.2%) ANNUAL CHANCE FLOOD HAZARD. AREAS
OF 1% ANNUAL CHANCE OF FLOOD WITH AVERAGE DEPTH LESS THAN ONE
FOOT OR WITH DRAINAGE AREAS OF LESS THAN ONE SQUARE MILE. THE
REMAINDER OF THE SITE LIES IN ZONE "X" AREAS DETERMINED TO BE
OUTSIDE OF THE 0.2% ANNUAL CHANCE FLOODPLAIN.

- THE LOCATION OF THE EXISTING UTILITIES AS SHOWN WERE OBTAINED FROM
MUNICIPAL AND UTILITY COMPANIES RECORDS. NO GUARANTEE CAN BE MADE
REGARDING THE COMPLETENESS OR EXACTNESS OF THE UTILITIES LOCATION.
IT IS THE CONTRACTORS RESPONSIBILITY TO VERIFY IN THE FIELD THE
LOCATION OF ALL UTILITIES AND ANY POTENTIAL CONFLICT SHALL BE REPORTED
TO THE ENGINEER PRIOR TO CONSTRUCTION.

- THE CONTRACTOR SHALL CONTACT MISS DIG 3 WORKING DAYS PRIOR TO
CONSTRUCTION.

- WETLANDS FLAGGED BY WILSON ROAD GROUP.

- !! CAUTION !!
DANGEROUS AND SENSITIVE UNDERGROUND FACILITIES MAY BE PRESENT
THROUGHOUT THE PROJECT AREA THAT DO NOT APPEAR ON THIS DRAWING.
ALL UNDERGROUND FACILITIES MUST BE LOCATED AND STAKED BY THE
APPROPRIATE AGENCIES PRIOR TO EXCAVATION.

LEGAL DESCRIPTION AS SURVEYED

PART OF THE S.W. 1/4 CORNER OF SECTION 3, T1N, R8E., CITY OF NOVI,
OAKLAND COUNTY, MICHIGAN. BEGINNING AT A POINT S.87°55'47"W. 642.40
FEET, FROM THE SOUTH 1/4 CORNER OF SAID SECTION 3; THENCE S.87°55'47"W.
637.25 FEET; THENCE N.02°42'10"W. 636.73 FEET; THENCE S.87°17' 50"W.
150.00 FEET; THENCE N.02°42'10"W. 150.00 FEET; THENCE N.87°17'50"E. 150.00
FEET; THENCE N.02°42'10"W. 49.76 FEET TO SOUTHWEST CORNER OF
"LAKEWOODS SUBDIVISION"; THENCE S.79°05'29"E. 367.64 FEET; THENCE S.11°
16' 59"W. 225.48 FEET; THENCE S.34°12'58"E. 230.00 FEET; THENCE
N.56°26'09"E. 250.44 FEET; THENCE S.02°36'17"E. 470.60 FEET TO A POINT OF
BEGINNING. CONTAINING 3.44 ACRES. SIDEWELL # 22-03-378-007

I HEREBY CERTIFY TO SINGH DEVELOPMENT THAT THIS SURVEY
HAS BEEN COMPILED FROM A SURVEY ACTUALLY MADE ON THE
GROUND UNDER MY SUPERVISION ON OCT. 2018 AND THAT IT IS
CORRECT AND THAT I HAVE COMPLIED WITH THE REQUIREMENTS
OF ACT 132, P.A. OF 1970 AND THAT THE ERROR OR CLOSURE
OF THE UNADJUSTED FIELD OBSERVATION IS WITHIN THE LIMITS
ESTABLISHED FOR THE PROFESSION

DATE:
SIGNED: WES LEE O. UMLOR
PS NO.: 56369



THE LOCATIONS OF EXISTING UNDERGROUND UTILITIES ARE SHOWN IN AN APPROXIMATE MANNER ONLY AND HAVE NOT BEEN INDEPENDENTLY VERIFIED BY THE OWNER OR ITS REPRESENTATIVE. THE CONTRACTOR SHALL DETERMINE THE EXACT LOCATION OF ALL EXISTING UTILITIES BEFORE COMMENCING WORK, AND AGREE TO BE FULLY RESPONSIBLE FOR ANY AND ALL DAMAGES WHICH MIGHT BE OCCASIONED BY THE CONTRACTOR'S FAILURE TO EXACTLY LOCATE AND PRESERVE ANY AND ALL UNDERGROUND UTILITIES.

811

Know what's below.
Call before you dig.

CONSTRUCTION SITE SAFETY IS THE RESPONSIBILITY OF THE CONTRACTOR. NEITHER THE OWNER NOR THE ENGINEER SHALL BE EXPECTED TO ASSUME ANY RESPONSIBILITY FOR SAFETY OF THE WORK, OF PERSONS ENGAGED IN THE WORK, OR OF ANY NEARBY STRUCTURES, OR OF ANY OTHER PERSONS.

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The UMLOR Group

LAND DEVELOPMENT SERVICES

SECTION 3

TOWN 1 NORTH, RANGE 8 EAST

CITY OF NOVI

OAKLAND COUNTY, MICHIGAN

SCENIC PINES

SINGH DEVELOPMENT, LLC.

7125 ORCHARD LAKE ROAD

BLOOMFIELD HILLS, MICHIGAN 48322

EXISTING CONDITIONS PLAN

DATE: 11-27-2019

REVISIONS

PER CITY 03-24-2020

PER CITY 10-12-2020

PER CITY 01-18-2021

OR BY: SDT

CK BY: SDT/JMY

P.M. SA

SCALE 0 25 50

1" = 50 FEET


JOB NO. 180905

SHEET NO. 3


SHEET 3 OF 38

M:\UMLOR GROUP PROJECT FOLDERS\SCENIC PINES DEVELOPMENT\180905 - SCENIC PINES DESIGN FILES & PLAN SETS\SCENIC PINES CD'S\180905-DEMOLITION PLANNING

LEGEND			
SYMBOL	DESCRIPTION	SYMBOL	DESCRIPTION
	CLEAN OUT		SIGN
	ELEC. RISER		2 POLE SIGN
	FIRE HYDRANT		MAILBOX
	ELEC. TRANSFORMER		POST
	GUY ANCHOR		ELECTRICAL RISER
	STM. MANHOLE		TELEPHONE RISER
	SAN. MANHOLE		COMMUNICATIONS RISER
	VENT		ELECTRICAL METER
	WATER STOP BOX		EXISTING FLAG POLE
	GATE VALVE		EXISTING GENERATOR
	SPEAKER BOX		EXISTING SIGNAL POLE
	POWER POLE		EXISTING GAS METER
	SINGLE LIGHT POLE		SET IRON
	DOUBLE LIGHT POLE		FOUND IRON
	ROUND CATCH BASIN		RECORDED DISTANCE
	SQUARE CATCH BASIN		MEASURED DISTANCE
	SOIL BORE LOCATION		
			EX STORM
			EX SANITARY
			EX WM
			ELEC OVERHEAD
			UNDERGROUND ELECTRIC
			GAS
			FENCE
			SILT FENCE
			EX FIBER OH
			EX GUARDRAIL
			EX WETLAND BUFFER
			EX GRAVEL
			EX ASPHALT
			EX CONCRETE
			REGULATED TREE

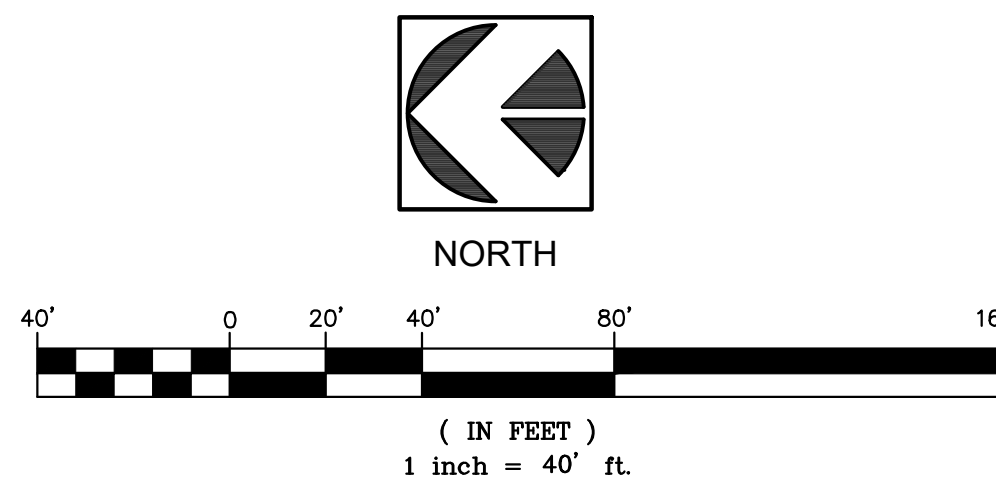

DEMO LEGEND	
SYMBOL	DESCRIPTION
	EX TREE REMOVAL
	TREE CRITICAL ROOT ZONE
	WETLAND BUFFER DISTURBANCE AREA
	WETLAND DISTURBANCE AREA (TEMPORARY)
	REMOVE

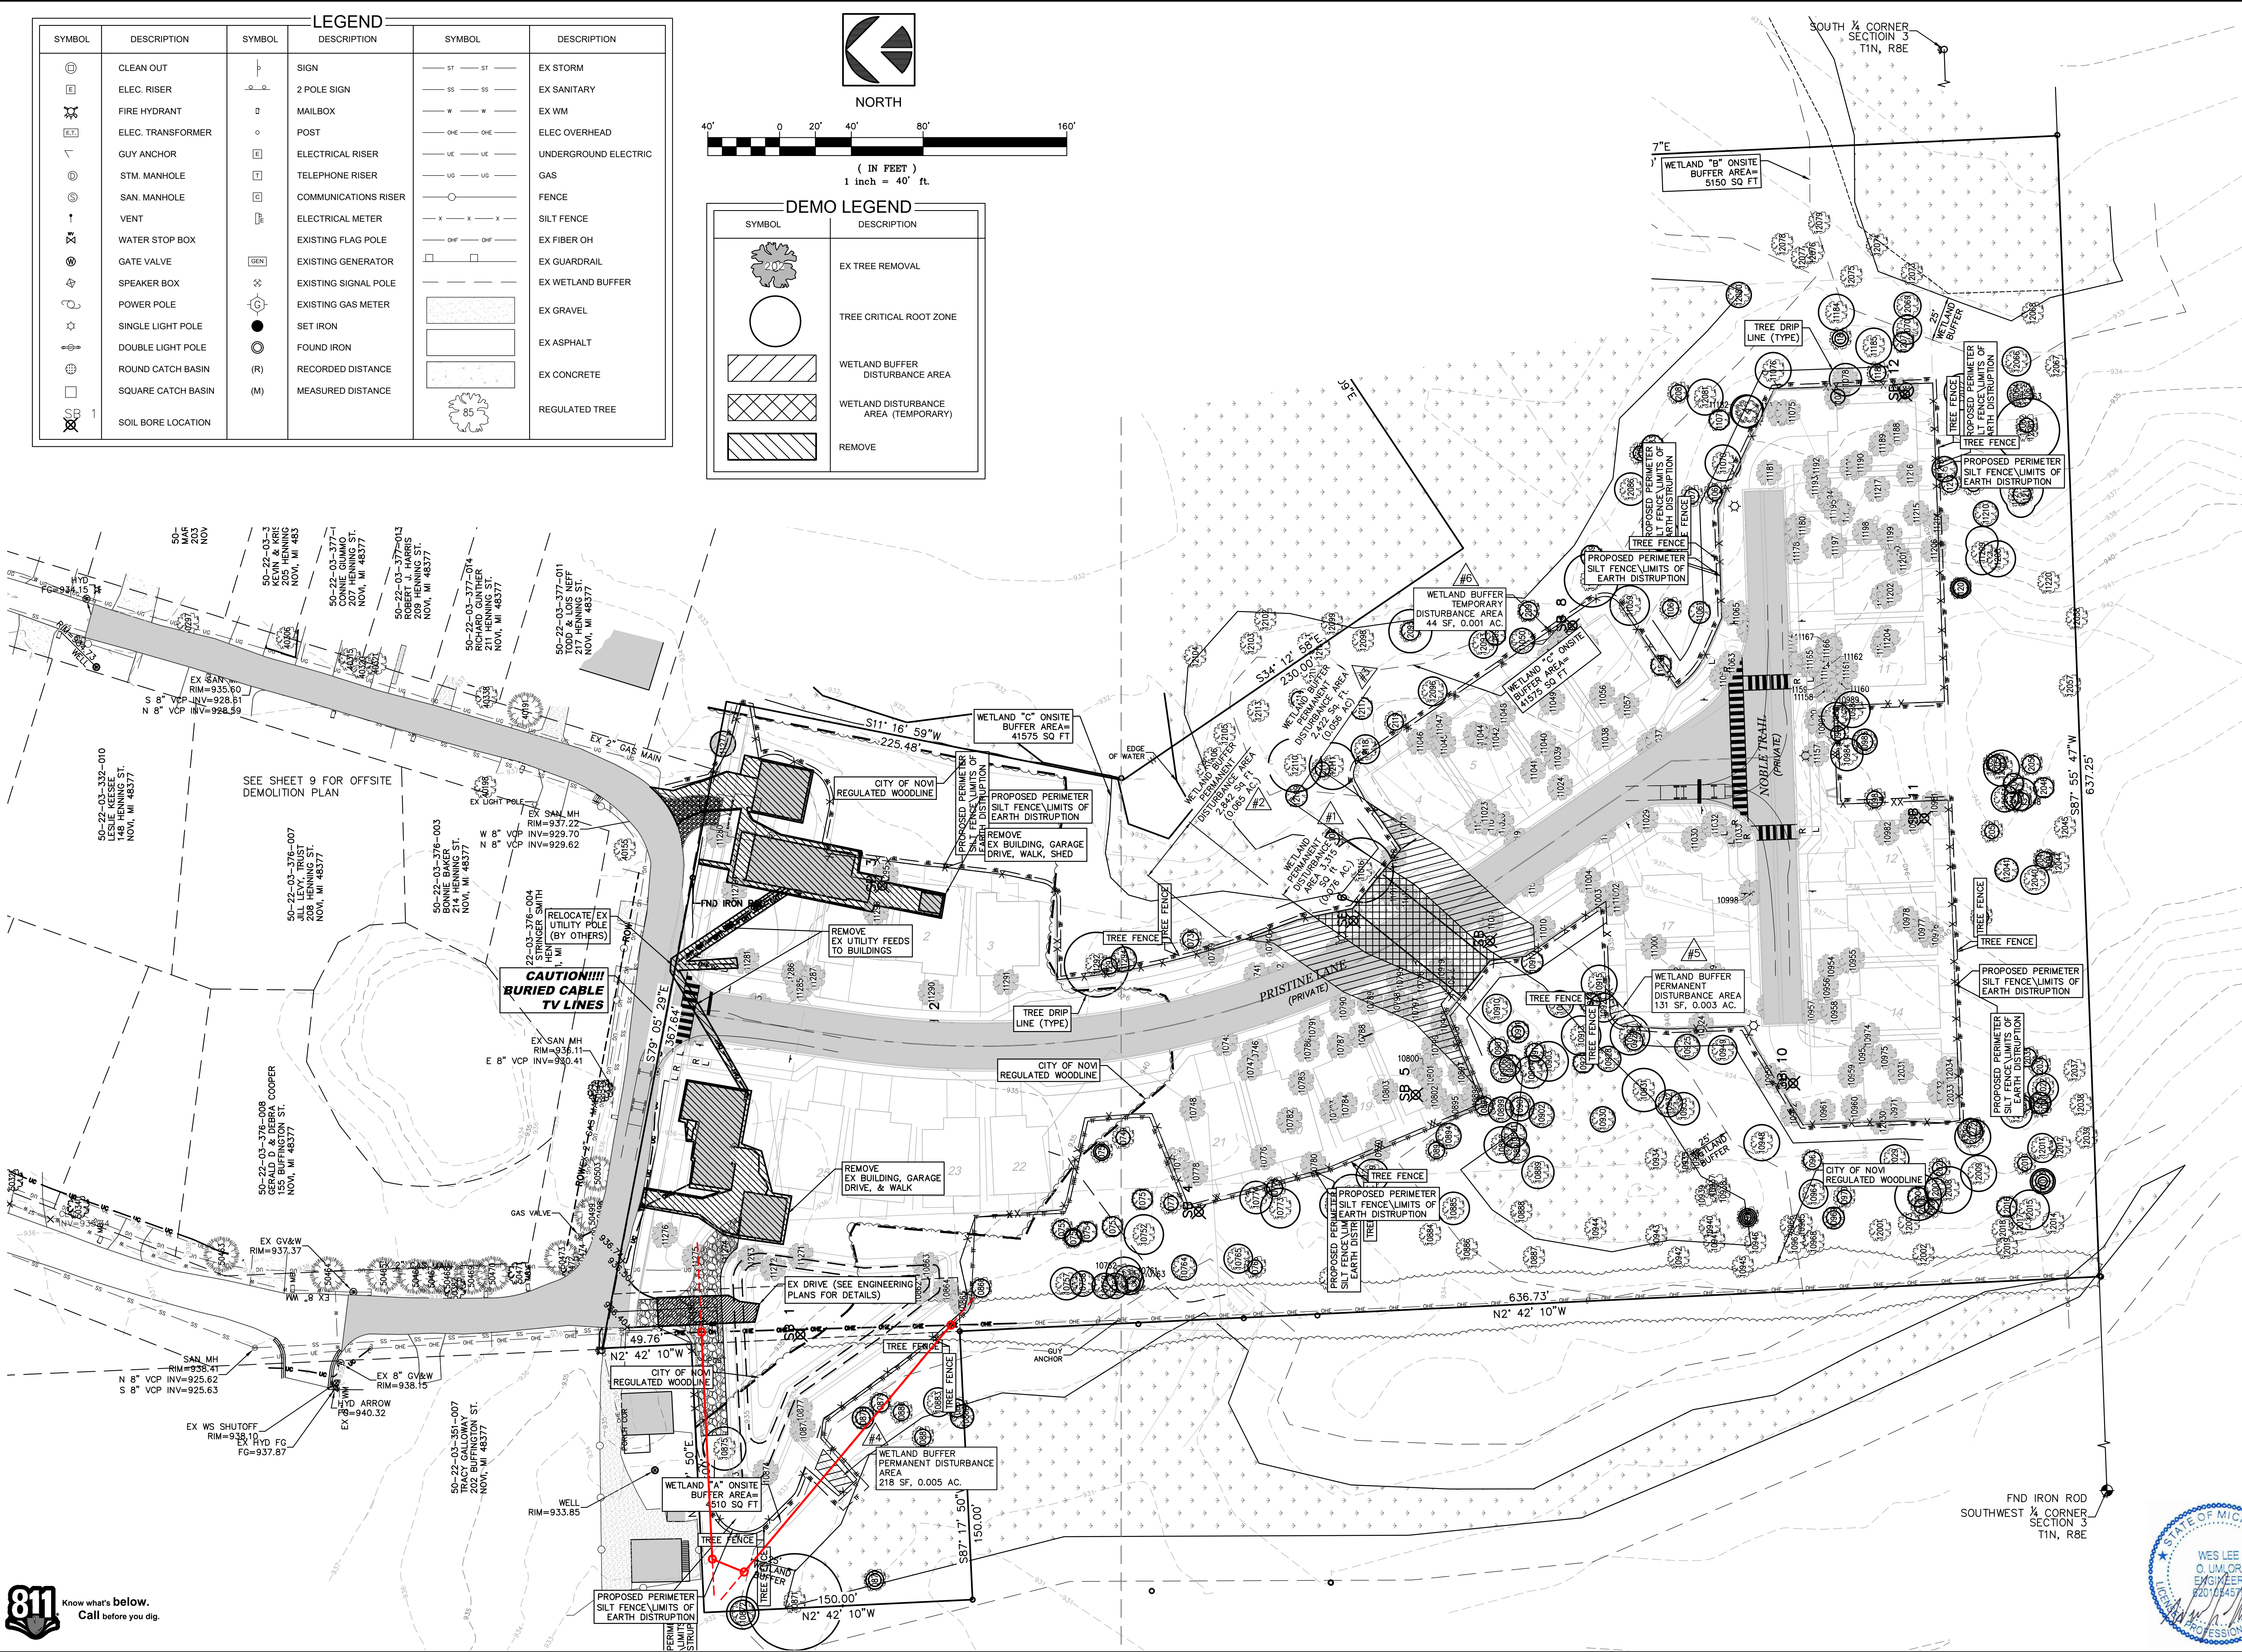

811 Know what's below.
Call before you dig.



THE LOCATIONS OF EXISTING UNDERGROUND UTILITIES ARE SHOWN IN AN APPROXIMATE WAY ONLY AND HAVE NOT BEEN INDEPENDENTLY VERIFIED BY THE OWNER OR ITS REPRESENTATIVE. THE CONTRACTOR SHALL DETERMINE THE EXACT LOCATION OF ALL EXISTING UTILITIES BEFORE COMMENCING WORK, AND AGREE TO BE FULLY RESPONSIBLE FOR ANY AND ALL DAMAGES WHICH MIGHT BE OCCURRED BY THE CONTRACTOR'S FAILURE TO EXACTLY LOCATE AND PRESERVE ANY AND ALL UNDERGROUND UTILITIES.

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The **UMLOR** Group

LAND DEVELOPMENT SERVICES

SECTION 3	TOWN 1 NORTH, RANGE 8 EAST
CITY OF NOVI	OAKLAND COUNTY, MICHIGAN

SCENIC PINES	ONSITE DEMOLITION PLAN
SINGH DEVELOPMENT, LLC. 7125 ORCHARD LAKE ROAD BLOOMFIELD HILLS, MICHIGAN 48322	

DATE: 11-27-2019




REVISIONS

PER CITY 03-24-2020
PER CITY 01-18-2021

DR BY: SDT
CK BY: SDT/MY
SCALE: 0 20 40
1" = 40 FEET
JOB NO. 180905
SHEET NO. 4

SHEET 4 OF 38

M:\UMLOR GROUP PROJECT FOLDERS\SCENIC PINES DEVELOPMENT\180905 - SCENIC PINES DESIGN FILES & PLAN SETS\SCENIC PINES CO'S 180905-DEMOLITION PLANNING

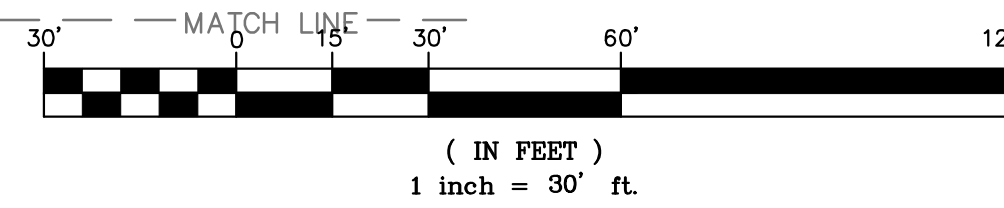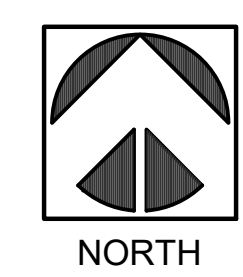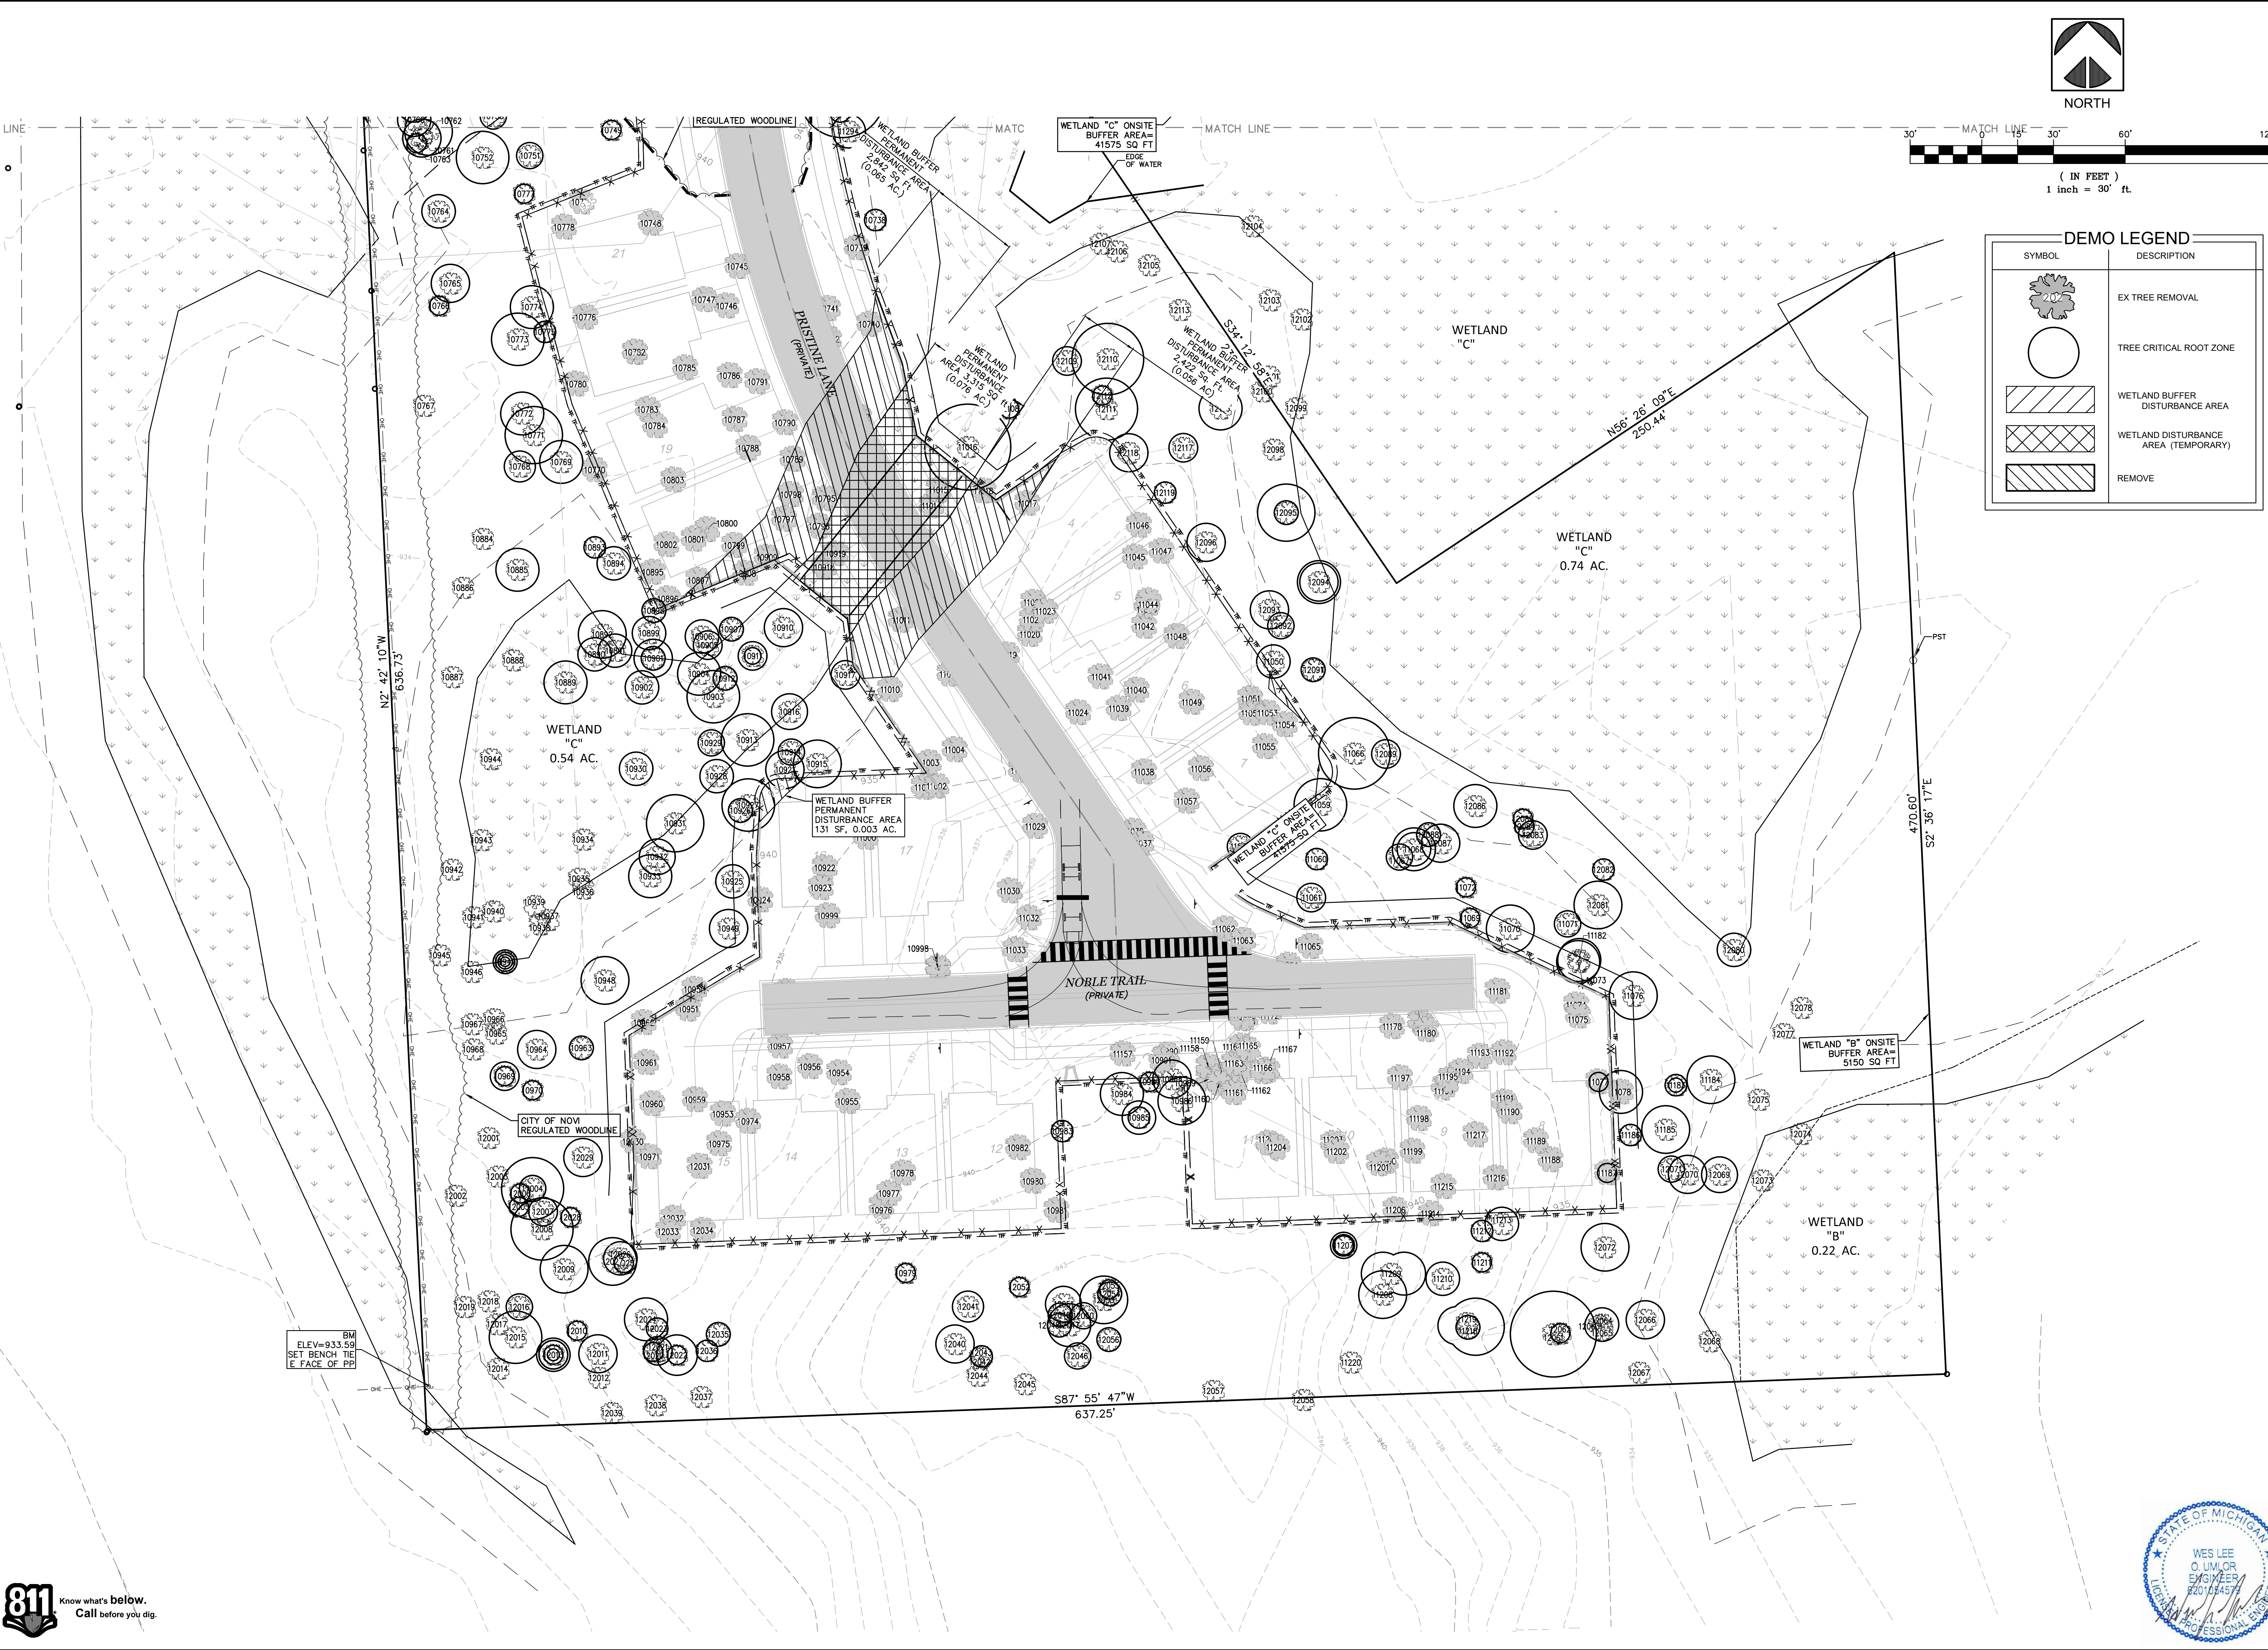

DEMO LEGEND	
SYMBOL	DESCRIPTION
	EX TREE REMOVAL
	TREE CRITICAL ROOT ZONE
	WETLAND BUFFER DISTURBANCE AREA
	WETLAND DISTURBANCE AREA (TEMPORARY)
	REMOVE

THE LOCATIONS OF EXISTING UNDERGROUND UTILITIES ARE SHOWN IN AN APPROXIMATE WAY ONLY AND HAVE NOT BEEN INDEPENDENTLY VERIFIED BY THE OWNER OR ITS REPRESENTATIVE. THE CONTRACTOR SHALL DETERMINE THE EXACT LOCATION OF ALL EXISTING UTILITIES BEFORE COMMENCING WORK, AND AGREE TO BE FULLY RESPONSIBLE FOR ANY AND ALL DAMAGES WHICH MIGHT BE OCCASIONED BY THE CONTRACTOR'S FAILURE TO EXACTLY LOCATE AND PRESERVE ANY AND ALL UNDERGROUND UTILITIES.

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The **UMLOR** Group

LAND DEVELOPMENT SERVICES

SECTION 3	TOWN 1 NORTH, RANGE 8 EAST	CITY OF NOVI	OAKLAND COUNTY, MICHIGAN
SCENIC PINES	SINGH DEVELOPMENT, LLC. 7125 ORCHARD LAKE ROAD BLOOMFIELD HILLS, MICHIGAN 48322		
CLIENT:	DEMOLITION PLAN - SOUTH		

DATE: 11-27-2019

REVISIONS

PER CITY 03-24-2020

PER CITY 01-18-2021

DR BY: SDT

CK BY: SDT/MY

P.M. SA

SCALE 0 15 30

1" = 30 FEET

JOB NO. 180905

SHEET NO. **5**

SHEET 5 OF 38

STATE OF MICHIGAN

WES LEE



O UMLOR

ENGINEER

20100459

PROFESSIONAL ENGINEER

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THE LOCATIONS OF EXISTING UNDERGROUND UTILITIES ARE SHOWN IN AN APPROXIMATE WAY ONLY AND HAVE NOT BEEN INDEPENDENTLY VERIFIED BY THE OWNER OR ITS REPRESENTATIVE. THE CONTRACTOR SHALL DETERMINE THE EXACT LOCATION OF ALL EXISTING UTILITIES BEFORE COMMENCING WORK, AND AGREES TO BE FULLY RESPONSIBLE FOR ANY AND ALL DAMAGES WHICH MIGHT BE OCCASIONED BY THE CONTRACTOR'S FAILURE TO EXACTLY LOCATE AND PRESERVE ANY AND ALL UNDERGROUND UTILITIES.

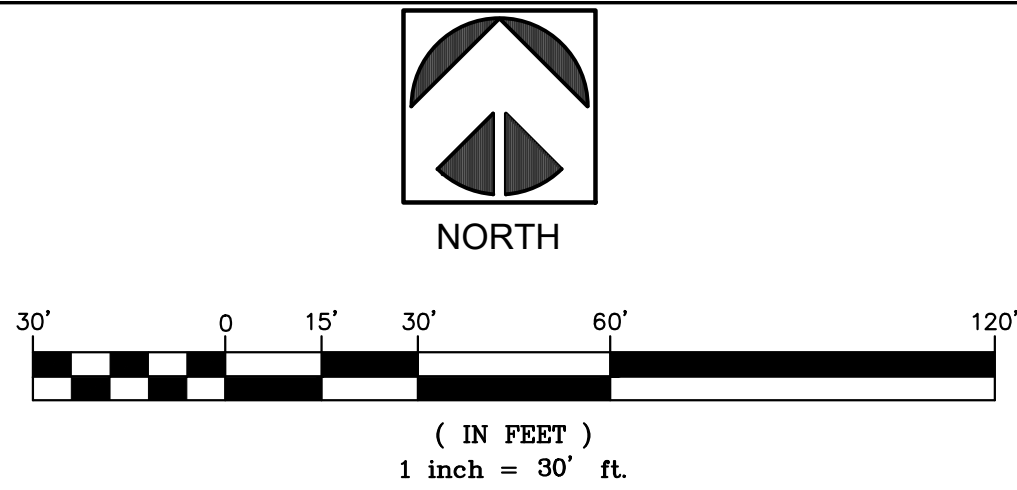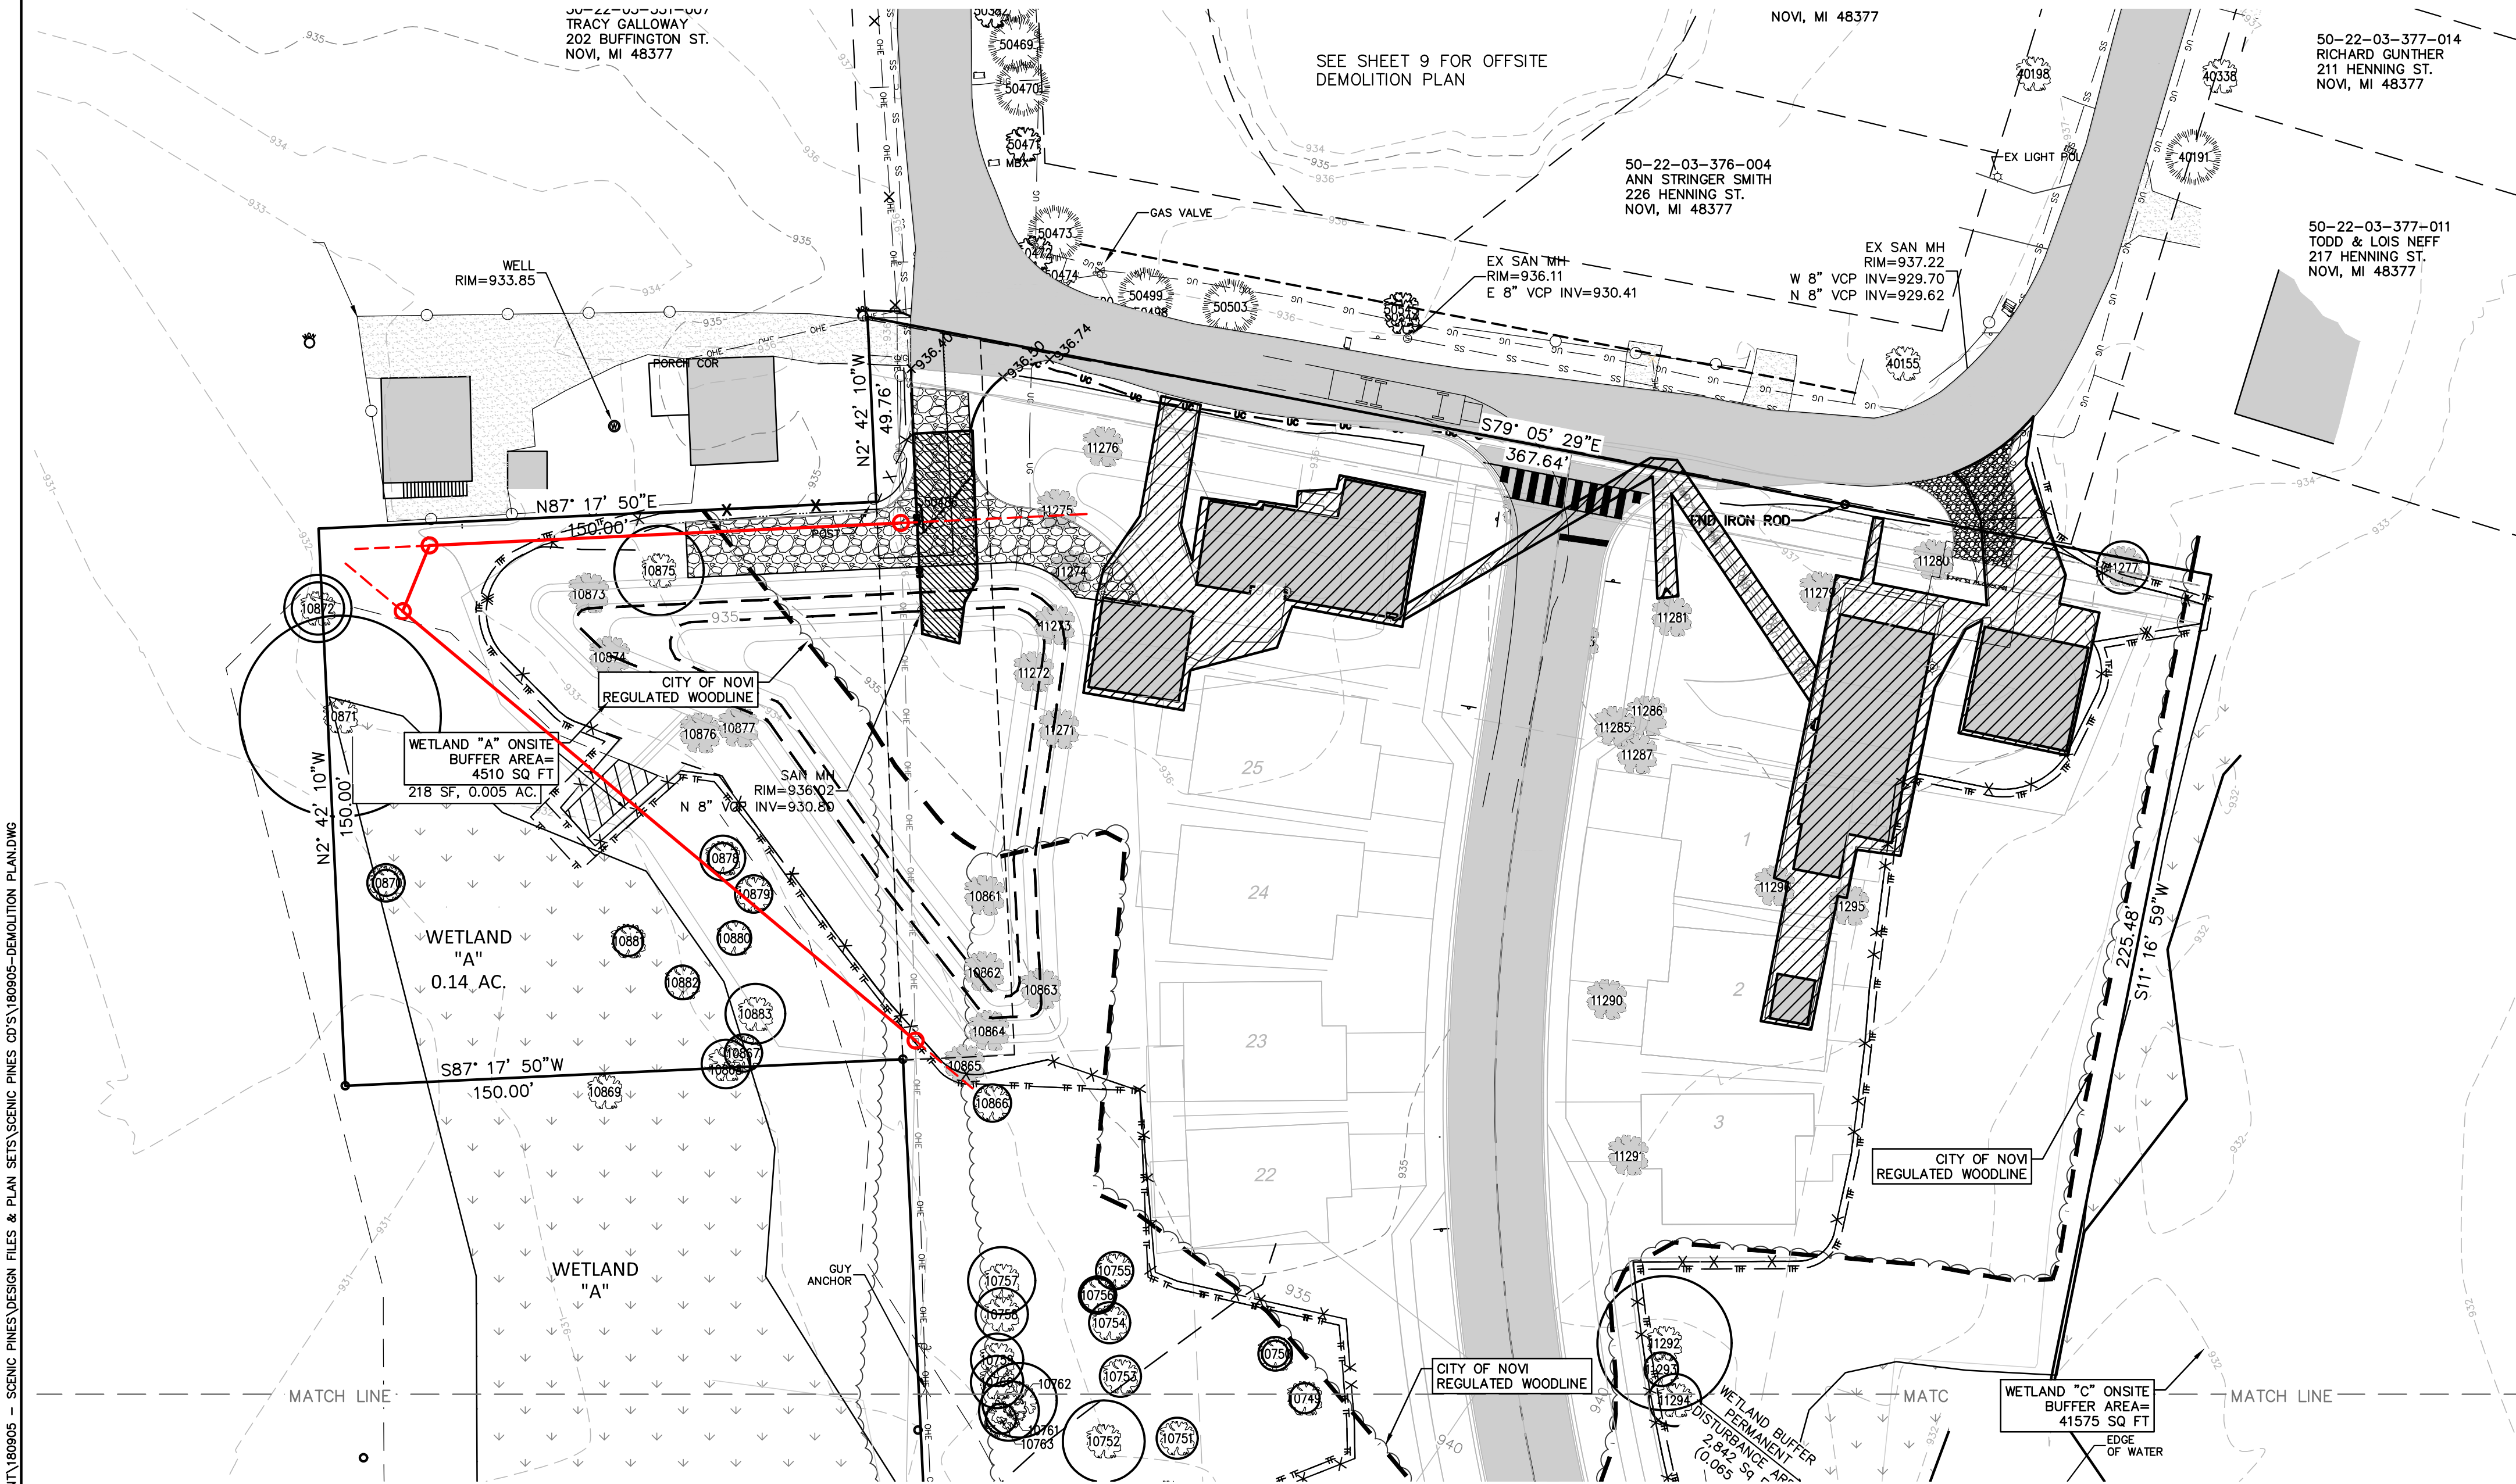

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LEGEND			
SYMBOL	DESCRIPTION	SYMBOL	DESCRIPTION
	CLEAN OUT		SIGN
	ELEC. RISER		2 POLE SIGN
	FIRE HYDRANT		MAILBOX
	ELEC. TRANSFORMER		POST
	GUY ANCHOR		ELECTRICAL RISER
	STM. MANHOLE		TELEPHONE RISER
	SAN. MANHOLE		COMMUNICATIONS RISER
	VENT		ELECTRICAL METER
	WATER STOP BOX		EXISTING FLAG POLE
	GATE VALVE		EXISTING GENERATOR
	SPEAKER BOX		EXISTING SIGNAL POLE
	POWER POLE		EXISTING GAS METER
	SINGLE LIGHT POLE		SET IRON
	DOUBLE LIGHT POLE		FOUND IRON
	ROUND CATCH BASIN		RECORDED DISTANCE
	SQUARE CATCH BASIN		MEASURED DISTANCE
	SOIL BORE LOCATION		EX STORM
			EX SANITARY
			EX WM
			ELEC OVERHEAD
			UNDERGROUND ELECTRIC
			GAS
			FENCE
			SILT FENCE
			EX FIBER OH
			EX GUARDRAIL
			EX WETLAND BUFFER
			EX GRAVEL
			EX ASPHALT
			EX CONCRETE
			REGULATED TREE

DEMO LEGEND	
SYMBOL	DESCRIPTION
	EX TREE REMOVAL
	TREE CRITICAL ROOT ZONE
	WETLAND BUFFER DISTURBANCE AREA
	WETLAND DISTURBANCE AREA (TEMPORARY)
	REMOVE

The UMLOR Group
LAND DEVELOPMENT SERVICES

SECTION 3
TOWN 1 NORTH, RANGE 8 EAST
CITY OF NOVI
OAKLAND COUNTY, MICHIGAN

SCENIC PINES
SINGH DEVELOPMENT, LLC.
7125 ORCHARD LAKE ROAD
BLOOMFIELD HILLS, MICHIGAN 48322

DEMOLITION PLAN - NORTH

DATE: 11-27-2019

REVISIONS

PER CITY 03-24-2020

PER CITY 01-18-2021



DR BY: SDT
CK BY: SDT/MY
P.M. SA
SCALE 0 15 30
1" = 30 FEET
JOB NO. 180905
SHEET NO. 6
SHEET 6 OF 38



Tag	Scientific Name	Common Name	DBH(s)	Multi Adjust	Condition	Status	Replacement Trees	Value
1	Prunus serotina	Black Cherry	(2) 18	8	Good	Save	0	\$ -
2	Quercus rubra	Red Oak	15	15	Good	Save	2	\$ 800
3	Quercus rubra	Red Oak	15	15	Good	remove	2	\$ 800
4	Quercus rubra	Red Oak	17	10	Good	remove	2	\$ 800
5	Quercus rubra	Red Oak	17	10	Good	remove	2	\$ 800
6	Quercus rubra	Red Oak	10	20	Good	remove	1	\$ 400
7	Acer saccharinum	Silver Maple	11	11	Good	remove	1	\$ 400
8	Quercus rubra	Red Oak	10	20	Good	remove	2	\$ 800
9	Quercus rubra	Red Oak	18	18	Good	remove	2	\$ 800
10	Quercus rubra	Red Oak	16	16	Good	remove	2	\$ 800
11	Acer saccharinum	Silver Maple	10	10	Good	remove	1	\$ 400
12	Acer saccharinum	Silver Maple	8	8	Good	Save	0	\$ -
13	Tilia	Basswood	(2) 7, 9	9	Good	Save	0	\$ -
14	Acer rubrum	Red Maple	11	11	Good	Save	0	\$ -
15	Acer rubrum	Red Maple	22	22	Good	Save	0	\$ -
16	Quercus rubra	Red Oak	11	11	Good	Save	0	\$ -
17	Quercus rubra	Red Oak	17	10	Good	Save	0	\$ -
18	Prunus serotina	Black Cherry	10	10	Good	Save	0	\$ -
19	Tilia	Basswood	(2) 8, 10	10	Good	Save	0	\$ -
20	Quercus rubra	Red Oak	18	18	Good	Save	0	\$ -
21	Quercus rubra	Red Oak	14	14	Good	Save	0	\$ -
22	Quercus rubra	Red Oak	17	10	Good	Save	0	\$ -
23	Quercus rubra	Red Oak	(2) 14	28	Good	Save	0	\$ -
24	Quercus rubra	Red Oak	16	16	Good	Save	0	\$ -
25	Quercus rubra	Red Oak	20	20	Good	Save	0	\$ -
26	Quercus rubra	Red Oak	8	8	Good	Save	0	\$ -
27	Acer rubrum	Red Maple	14	14	Good	Save	0	\$ -
28	Carya glabra	Pignut Hickory	16	16	Good	Save	0	\$ -
29	Acer rubrum	Red Maple	8	8	Good	Save	0	\$ -
30	Acer rubrum	Red Maple	16	16	Good	Save	0	\$ -
31	Quercus rubra	Red Oak	13	13	Good	Save	0	\$ -
32	Quercus rubra	Red Oak	18	18	Good	Save	0	\$ -
33	Carya glabra	Pignut Hickory	11	11	Good	Save	0	\$ 400
34	Quercus rubra	Red Oak	24	24	Good	Save	0	\$ -
35	Quercus rubra	Red Oak	18	18	Good	Save	0	\$ -
36	Quercus rubra	Red Oak	22	22	Good	Save	0	\$ -
37	Quercus rubra	Red Oak	18	18	Good	Save	0	\$ -
38	Prunus serotina	Black Cherry	9	9	Good	Save	0	\$ -
39	Quercus rubra	Red Oak	(3) 14, 15, 18	47	Good	Save	6	\$ 2,400
40	Acer rubrum	Red Maple	8	8	Good	Save	0	\$ -
41	Quercus rubra	Red Oak	22	22	Good	remove	3	\$ 1,200
42	Carya glabra	Pignut Hickory	14	14	Good	remove	1	\$ 400
43	Quercus rubra	Red Oak	21	21	Good	remove	3	\$ 1,200
44	Tilia	Basswood	8	8	Good	remove	0	\$ -
45	Quercus rubra	Red Oak	20	20	Good	remove	2	\$ 800
46	Carya glabra	Pignut Hickory	15	15	Good	remove	2	\$ 800
47	Quercus rubra	Red Oak	15	15	Good	remove	2	\$ 800
48	Carya glabra	Pignut Hickory	15	15	Good	remove	2	\$ 800
49	Quercus rubra	Red Oak	16	16	Good	remove	2	\$ 800
50	Tilia	Basswood	11	11	Good	remove	1	\$ 400
51	Quercus rubra	Red Oak	15	15	Good	remove	2	\$ 800
52	Quercus rubra	Red Oak	24	24	Good	remove	3	\$ 1,200
53	Carya glabra	Pignut Hickory	12	12	Good	remove	1	\$ 400
54	Quercus rubra	Red Oak	14	14	Good	remove	2	\$ 800
55	Quercus rubra	Red Oak	8	8	Good	remove	1	\$ 400
56	Tilia	Basswood	9	9	Good	remove	1	\$ 400
57	Tilia	Basswood	12	12	Good	remove	2	\$ 800
58	Quercus rubra	Red Oak	18	18	Good	remove	2	\$ 800
59	Acer rubrum	Red Maple	9	9	Good	remove	1	\$ 400
60	Quercus rubra	Red Oak	20	20	Good	remove	2	\$ 800
61	Quercus rubra	Red Oak	15	15	Good	remove	2	\$ 800
62	Acer rubrum	Red Maple	(2) 10	20	Good	remove	2	\$ 800
63	Quercus rubra	Red Oak	(3) 10, 15, 18	48	Good	remove	6	\$ 2,400
64	Quercus rubra	Red Oak	20	20	Good	remove	2	\$ 800
65	Quercus rubra	Red Oak	20	20	Good	remove	2	\$ 800
66	Tilia	Basswood	14	14	Good	remove	2	\$ 800
67	Tilia	Basswood	10	10	Good	remove	1	\$ 400
68	Tilia	Basswood	9	9	Fair	remove	1	\$ 400
69	Tilia	Basswood	9	9	Fair	remove	1	\$ 400
70	Tilia	Basswood	11	11	Good	remove	1	\$ 400
71	Tilia	Basswood	10	10	Good	remove	0	\$ -
72	Ulmus	Elm	(2) 4, 10	10	Good	remove	2	\$ 800
73	Quercus alba	White Oak	13	13	Good	Save	0	\$ -
74	Acer rubrum	Red Maple	14	14	Good	Save	0	\$ -
75	Acer rubrum	Red Maple	(6) 7, 10	10	Good	Save	0	\$ -
76	Salix	Willow	54	54	Poor	Save	0	\$ -
77	Acer rubrum	Red Maple	(2) 14, 18	32	Good	Save	0	\$ -
78	Carya glabra	Pignut Hickory	14	14	Good	remove	1	\$ 400
79	Tilia	Basswood	22	22	Good	remove	3	\$ 1,200
80	Quercus rubra	Red Oak	24	24	Good	remove	3	\$ 1,200
81	Tilia	Basswood	20	20	Good	remove	1	\$ 400
82	Tilia	Basswood	(5) 8, 12	20	Fair	remove	2	\$ 800
83	Tilia	Basswood	10	10	Good	remove	0	\$ -
84	Tilia	Basswood	20	20	Good	remove	0	\$ -
85	Tilia	Basswood	9	9	Good	remove	0	\$ -
86	Tilia	Basswood	8	8	Good	remove	0	\$ -
87	Tilia	Basswood	9	9	Good	remove	0	\$ -
88	Tilia	Basswood	(2) 16	32	Good	remove	0	\$ -
89	Quercus rubra	Red Oak	18	18	Good	remove	0	\$ -
90	Quercus rubra	Red Oak	(2) 20	40	Good	remove	0	\$ -
91	Quercus rubra	Red Oak	(3) 12, 20	40	Good	remove	0	\$ -
92	Acer rubrum	Red Maple	20	20	Good	remove	0	\$ -
93	Acer rubrum	Red Maple	20	20	Good	remove	0	\$ -
94	Acer rubrum	Red Maple	16	16	Good	remove	0	\$ -
95	Acer rubrum	Red Maple	14	14	Good	remove	0	\$ -
96	Acer rubrum	Red Maple	14	14	Good	remove	0	\$ -
97	Acer rubrum	Red Maple	20	20	Good	remove	0	\$ -
98	Quercus rubra	Red Oak	9	9	Good	remove	0	\$ -
99	Quercus rubra	Red Oak	14	14	Good	remove	0	\$ -
100	Tilia	Basswood	10	10	Fair	remove	1	\$ 400

Tag	Scientific Name	Common Name	DBH(s)	Multi Adjust	Condition	Status	Replacement Trees	Value
401	Tilia	Basswood	9	9	Good	Save	0	\$ -
402	Quercus rubra	Red Oak	16	16	Good	Save	0	\$ -
403	Quercus rubra	Red Oak	14	14	Good	Save	0	\$ -
404	Quercus rubra	Red Oak	16	16	Good	Save	0	\$ -
405	Quercus rubra	Red Oak	16	16	Good	Save	0	\$ -
406	Tilia	Basswood	13	13	Good	Save	0	\$ -
407	Sassafras albidum	Sassafras	9	9	Good	Save	0	\$ -
408	Sassafras albidum	Sassafras	9	9	Good	Save	0	\$ -
409	Sassafras albidum	Sassafras	9	9	Good	Save	0	\$ -
410	Sassafras albidum	Sassafras	10	10	Good	Save	0	\$ -
411	Acer rubrum	Red Maple	11	11	Good	Save	0	\$ -
412	Quercus rubra	Red Oak	18	18	Good	Save	0	\$ -
413	Sassafras albidum	Sassafras	10	10	Good	Save	0	\$ -
414	Sassafras albidum	Sassafras	10	10	Good	Save	0	\$ -
415	Sassafras albidum	Sassafras	11	11	Good	Save	0	\$ -
416	Quercus rubra	Red Oak	15	15	Good	Save	0	\$ -
417	Tilia	Basswood	8	8	Good	Save	0	\$ -
418	Quercus rubra	Red Oak	20	20	Good	Save	0	\$ -
419	Tilia	Basswood	10	10	Good	Save	0	\$ -
420	Tilia	Basswood	8	8	Good	Save	0	\$ -
421	Tilia	Basswood	10	10	Good	Save	0	\$ -
422	Quercus rubra	Red Oak	13	13	Good	Save	0	\$ -
423	Acer saccharum	Sugar Maple	40	40	Good	Save	0	\$ -
424	Quercus rubra	Red Oak	36	36	Good	Save	0	\$ -
425	Quercus rubra	Red Oak	8	8	Good	Save	0	\$ -
426	Tilia	Basswood	14	14	Good	Save	0	\$ -
427	Tilia	Basswood	12	12	Good	Save	0	\$ -
428	Tilia	Basswood	9	9	Good	Save	0	\$ -
429	Ulmus	Elm	16	16	Good	Save	0	\$ -
430	Malus	Apple	0	0	Good	Save	0	\$ -
431	Carya glabra	Pignut Hickory	6	6	Good	Save	0	\$ -
432	Tilia	Basswood	15	15	Good	Save	0	\$ -
433	Acer saccharum	Sugar Maple	0	0	Good	Save	0	\$ -
434	Acer saccharum	Sugar Maple	11	11	Good	Save	0	\$ -
435	Tilia	Basswood	20	20	Good	Save	0	\$ -
436	Acer rubrum	Red Maple	(3) 12, 16, 18	44	Good	Save	0	\$ -
437	Acer rubrum	Red Maple	16	16	Good	Save	0	\$ -
438	Acer saccharum	Sugar Maple	12	12	Good	Save	0	\$ -
439	Tilia	Basswood	16	16	Good	Save	0	\$ -
440	Acer saccharum	Sugar Maple	(3) 4, 12, 12	28	Good	Save	0	\$ -
441	Tilia	Basswood	12	12	Good	Save	0	\$ -
442	Tilia	Basswood	10	10	Good	Save	0	\$ -
443	Acer rubrum	Red Maple	14	14	Good	Save	0	\$ -
444	Tilia	Basswood	0	0	Good	Save	0	\$ -
445	Quercus rubra	Red Oak	9	9	Good	Save	0	\$ -
446	Tilia	Basswood	12	12	Good	Save	0	\$ -
447	Tilia	Basswood	0	0	Good	Save	0	\$ -
448	Quercus rubra	Red Oak	8	8	Good	Save	0	\$ -
449	Quercus rubra	Red Oak	18	18	Good	Save	0	\$ -
450	Populus deltoides	Cottonwood	10	10	Good	Save	0	\$ -
451	Populus deltoides	Cottonwood	10	10	Good	Save	0	\$ -
452	Acer rubrum	Red Maple	12	12	Good	Save	0	\$ -
453	Tilia	Basswood	0	0	Good	Save	0	\$ -
454	Quercus rubra	Red Oak	(2) 10	20	Good	Save	0	\$ -

Tag	Scientific Name	Common Name	DBH(s)	Multi Adjust	Condition	Status	Replacement Trees	Value	Tag
101	Quercus rubra	Red Oak	16	16	Good	remove	2	\$ 800	201
102	Quercus rubra	Red Oak	18	18	Good	remove	2	\$ 800	202
103	Quercus rubra	Red Oak	10	10	Poor	Save	0	\$ -	203
104	Quercus rubra	Red Oak	14	14	Good	Save	0	\$ -	204
105	Quercus rubra	Red Oak	(2) 10, 16	26	Good	Save	0	\$ -	205
106	Quercus rubra	White Oak	14	14	Good	Save	0	\$ -	206
107	Acer rubrum	Red Maple	22	22	Good	Save	0	\$ -	207
108	Quercus rubra	Red Oak	18	18	Good	Save	0	\$ -	208
109	Quercus rubra	Quercus rubra	12	12	Good	Save	0	\$ -	209
110	Quercus rubra	Red Oak	14	14	Good	Save	0	\$ -	210
111	Quercus alba	White Oak	10	10	Good	Save	0	\$ -	211
112	Quercus rubra	Red Oak	16	16	Good	Save	0	\$ -	212
113	Quercus rubra	Red Oak	20	20	Good	Save	0	\$ -	213
114	Acer rubrum	Red Maple	16	16	Good	Save	0	\$ -	214
115	Acer rubrum	Red Maple	(3) 7, 12, 24	24	Good	Save	0	\$ -	215
116	Quercus rubra	Red Oak	10	10	Good	Save	0	\$ -	216
117	Tilia	Red Maple	22	22	Good	Save	0	\$ -	217
118	Tilia	Basswood	11	11	Good	Save	0	\$ -	218
119	Tilia	Basswood	20	20	Good	Save	0	\$ -	219
120	Quercus alba	White Oak	15	15	Good	Save	0	\$ -	220
121	Tilia	Basswood	12	12	Good	Save	0	\$ -	221
122	Quercus rubra	Red Oak	11	11	Good	remove	1	\$ 400	222
123	Quercus alba	White Oak	20	20	Good	remove	2	\$ 800	223
124	Tilia	Basswood	(2) 8, 16	22	Good	remove	3	\$ 1,200	224
125	Quercus rubra	Red Oak	16	16	Good	Save	0	\$ -	225
126	Carya glabra	Pignut Hickory	17	17	Good	remove	2	\$ 800	226
127	Quercus rubra	Red Oak	10	10	Good	remove	1	\$ 400	227
128	Quercus rubra	Quercus rubra	10	10	Good	remove	0	\$ -	228
129	Quercus rubra	Red Oak	14	14	Good	Save	0	\$ -	229
130	Quercus alba	White Oak	10	10	Good	Save	0	\$ -	230
131	Quercus rubra	Red Oak	22	22	Good	Save	0	\$ -	231
132	Quercus alba	White Oak	14	14	Good	Save	0	\$ -	232
133	Quercus rubra	White Oak	11	11	Good	Save	0	\$ -	233
134	Quercus alba	White Oak	24	24	Good	Save	0	\$ -	234
135	Acer rubrum	Red Maple	24	24	Good	Save	0	\$ -	235
136	Tilia	Basswood	15	15	Good	Save	0	\$ -	236
137	Quercus alba	White Oak	18	18	Good	Save	0	\$ -	237
138	Acer rubrum	Red Maple	18	18	Good	Save	0	\$ -	238
139	Acer rubrum	Red Maple	(2) 12, 18	30	Good	Save	0	\$ -	239
140	Acer rubrum	Red Maple	16	16	Good	Save	0	\$ -	240
141	Acer rubrum	Red Maple	18	18	Good	Save	0	\$ -	241
142	Acer rubrum	Red Maple	14	14	Good	Save	0	\$ -	242
143	Acer rubrum	Red Maple	20	20	Good	Save	0	\$ -	243
144	Acer rubrum	Red Maple	14	14	Good	Save	0	\$ -	244
145	Populus deltoides	Cottonwood	14	14	Good	Save	0	\$ -	245
146	Populus deltoides	Cottonwood	11	11	Good	Save	0	\$ -	246
147	Acer rubrum	Red Maple	18	18	Good	Save	0	\$ -	247
148	Acer rubrum	Red Maple	30	30	Good	Save	0	\$ -	248
149	Acer rubrum	Red Maple	14	14	Good	Save	0	\$ -	249
150	Ulmus	Elm	12	12	Good	Save	0	\$ -	250
151	Acer rubrum	Red Maple	(4) 8, 10, 18	20	Good	Save	0	\$ -	251
152	Quercus rubra	Red Oak	20	20	Good	Save	0	\$ -	252
153	Quercus rubra	Red Oak	16	16	Good	Save	0	\$ -	253
154	Carya glabra	Hickory	20	20	Good	remove	2	\$ 800	254
155	Quercus rubra	Red Oak	20	20	Good	remove	2	\$ 800	255
156	Quercus rubra	Red Oak	(3) 16	48	Good	remove	6	\$ 2,400	256
157	Quercus rubra	Red Oak	8	8	Good	remove	2	\$ 800	257
158	Quercus rubra	Red Oak	14	14	Good	remove	2	\$ 800	258
159	Quercus rubra	Red Oak	16	16	Good	remove	2	\$ 800	259
160	Prunus serotina	Black Cherry	12	12	Good	remove	3	\$ 1,200	260
161	Quercus rubra	Red Oak	22	22	Good	remove	2	\$ 800	261
162	Quercus rubra	Red Oak	18	18	Good	remove	2	\$ 800	262
163	Tilia	Basswood	9	9	Good	remove	1	\$ 400	263
164	Quercus rubra	Red Oak	20	20	Good	remove	1	\$ 400	264
165	Carya ovata	Shagbark Hickory	16	16	Good	remove	2	\$ 800	265
166	Acer rubrum	Red Maple	20	20	Good	remove	2	\$ 800	266
167	Basswood	Basswood	(2) 10	20	Good	remove	2	\$ 800	267
168	Tilia	Basswood	16	16	Good	Save	0	\$ -	268
169	Acer rubrum	Red Maple	16	16	Good	Save	0	\$ -	269
170	Acer rubrum	Red Maple	22	22	Good	Save	0	\$ -	270
171	Quercus rubra	Red Oak	14	14	Good	Save	0	\$ -	271
172	Tilia	Basswood	(2) 8, 10	10	Good	Save	0	\$ -	272
173	Carya glabra	Pignut Hickory	20	20	Good	Save	0	\$ -	273
174	Carya glabra	Pignut Hickory	8	8	Good	Save	0	\$ -	274
175	Quercus rubra	Red Oak	18	18	Good	Save	0	\$ -	275
176	Tilia	Basswood	8	8	Good	remove	1	\$ 400	276
177	Tilia	Basswood	(2) 11	22	Good	remove	1	\$ 400	277
178	Tilia	Basswood	(6) 4-16	46	Good	remove	6	\$ 2,400	278
180	Tilia	Basswood	(3) 5-8	20	Good	remove	6	\$ 2,400	279
181	Tilia	Basswood	8	8	Good	remove	2	\$ 800	280
182	Tilia	Basswood	15	15	Good	remove	2	\$ 800	282
183	Tilia	Basswood	10	10	Good	remove	2	\$ 800	283
184	Tilia	Basswood	14	14	Good	remove	2	\$ 800	284
185	Tilia	Basswood	9	9	Good	Save	0	\$ -	285
186	Quercus rubra	Red Oak	18	18	Good	Save	0	\$ -	286
187	Tilia	Basswood	(2) 9, 14	23	Good	Save	0	\$ -	287
188	Quercus rubra	Red Oak	20	20	Good	Save	0	\$ -	288
189	Sassafras albidum	Sassafras	8	8	Good	Save	0	\$ -	289
190	Tilia	Basswood	16	16	Good	Save	0	\$ -	290
191	Sassafras albidum	Sassafras	9	9	Good	remove	1	\$ 400	291
192	Sassafras albidum	Sassafras	8	8	Good	remove	1	\$ 400	292
193	Sassafras albidum	Sassafras	8	8	Good	remove	1	\$ 400	293
194	Populus deltoides	Cottonwood	22	22	Good	remove	2	\$ 800	294
195	Tilia	(2) 9	18	18	Good	remove	2	\$ 800	295
196	Populus deltoides	Cottonwood	16	16	Good	remove	2	\$ 800	296
197	Populus deltoides	Cottonwood	18	18	Good	remove	2	\$ 800	297
198	Quercus rubra	Red Oak	(1) 14, 16, 20, 22	72	Good	remove	9	\$ 3,600	298
199	Acer rubrum	Red Maple	16	16	Good	remove	5	\$ 2,000	299
200	Quercus rubra	Red Oak	8	8	Good	remove	1	\$ 400	300

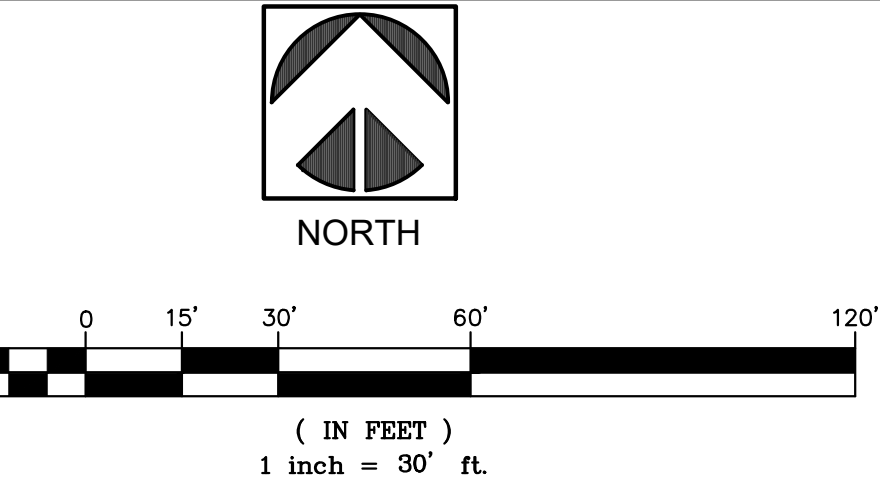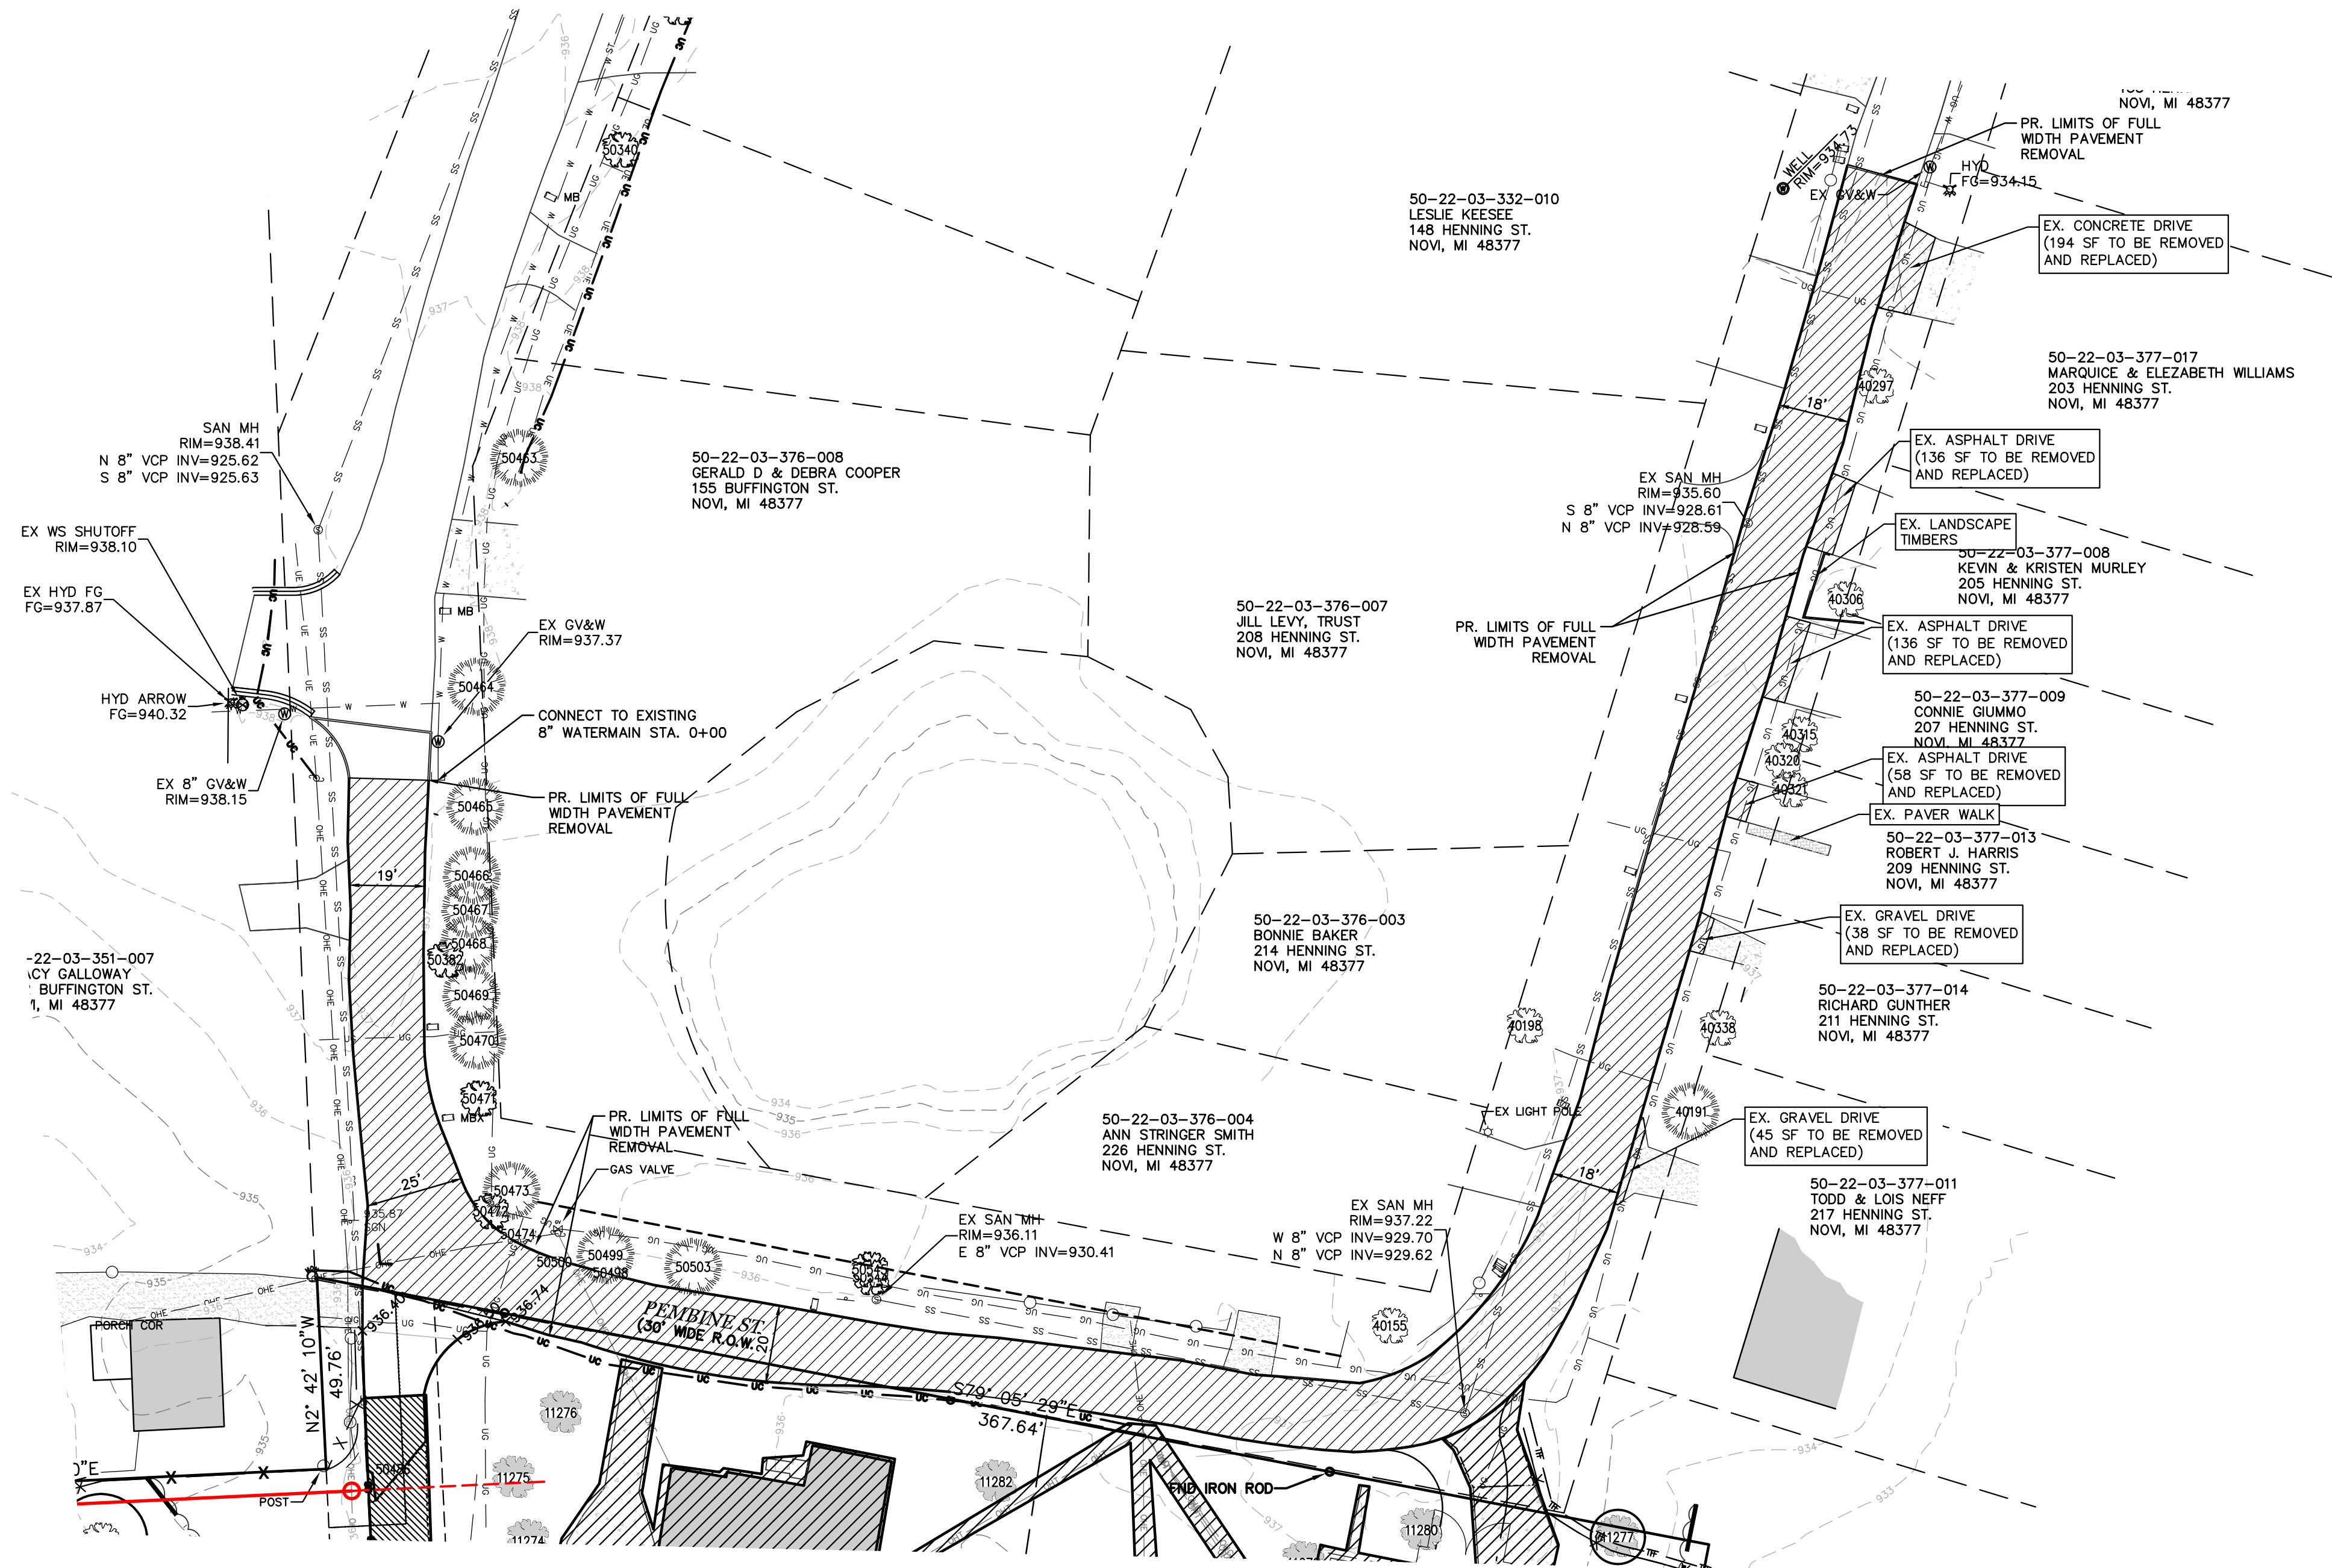

DEMO LEGEND	
SYMBOL	DESCRIPTION
	EX TREE REMOVAL
	TREE CRITICAL ROOT ZONE
	WETLAND BUFFER DISTURBANCE AREA
	WETLAND DISTURBANCE AREA (TEMPORARY)
	REMOVE

REMOVAL QUANTITIES FOR OFFSITE WATERMAIN

CHIP AND SEAL PAVEMENT	13656 SF
ASPHALT DRIVE	330 SF
GRAVEL DRIVE	83 SF
CONCRETE DRIVE	194 SF

NOTE:
CONTRACTOR SHALL ADJUST MAIN AS NEEDED TO SAVE EXISTING TREES ALONG BUFFINGTON,PEMBINE/HENNING ST.
CONTRACTOR SHALL REPAIR/REPLACE ANY PAVING, LANDSCAPING, GRADING, MAILBOXES, ETC. TO THERE ORIGINAL CONDITION OR BETTER.

LEGEND					
SYMBOL	DESCRIPTION	SYMBOL	DESCRIPTION	SYMBOL	DESCRIPTION
	CLEAN OUT		SIGN		EX STORM
	ELEC. RISER		2 POLE SIGN		EX SANITARY
	FIRE HYDRANT		MAILBOX		EX WM
	ELEC. TRANSFORMER		POST		ELEC OVERHEAD
	GUY ANCHOR		ELECTRICAL RISER		UNDERGROUND ELECTRIC
	STM. MANHOLE		TELEPHONE RISER		GAS
	SAN. MANHOLE		COMMUNICATIONS RISER		FENCE
	VENT		ELECTRICAL METER		SILT FENCE
	WATER STOP BOX		EXISTING FLAG POLE		EX FIBER OH
	GATE VALVE		EXISTING GENERATOR		EX GUARDRAIL
	SPEAKER BOX		EXISTING SIGNAL POLE		EX WETLAND BUFFER
	POWER POLE		EXISTING GAS METER		EX GRAVEL
	SINGLE LIGHT POLE		SET IRON		EX ASPHALT
	DOUBLE LIGHT POLE		FOUND IRON		EX CONCRETE
	ROUND CATCH BASIN		RECORDED DISTANCE		REGULATED TREE
	SQUARE CATCH BASIN		MEASURED DISTANCE		
	SOIL BORE LOCATION				



THE LOCATIONS OF EXISTING UNDERGROUND UTILITIES ARE SHOWN IN AN APPROXIMATE WAY ONLY AND HAVE NOT BEEN INDEPENDENTLY VERIFIED BY THE OWNER OR ITS REPRESENTATIVE. THE CONTRACTOR SHALL DETERMINE THE EXACT LOCATION OF ALL EXISTING UTILITIES BEFORE COMMENCING WORK, AND AGREES TO BE FULLY RESPONSIBLE FOR ANY AND ALL DAMAGES WHICH MIGHT BE OCCASIONED BY THE CONTRACTOR'S FAILURE TO EXACTLY LOCATE AND PRESERVE ANY AND ALL UNDERGROUND UTILITIES.

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The UMLOR Group

LAND DEVELOPMENT SERVICES

SECTION 3

TOWN 1 NORTH, RANGE 8 EAST

CITY OF NOVI

OAKLAND COUNTY, MICHIGAN

SCENIC PINES

CLIENT: SINGH DEVELOPMENT, LLC.
7125 ORCHARD LAKE ROAD
BLOOMFIELD HILLS, MICHIGAN 48322

OFFSITE DEMOLITION PLAN

DATE: 11-27-2019

REVISIONS

PER CITY 03-24-2020

PER CITY 01-18-2021

DR BY: SDT

CK BY: SDT/MY

P.M. SA



SCALE 0 15 30

1" = 30 FEET

JOB NO. 180905

SHEET NO. 9

SHEET 9 OF 38

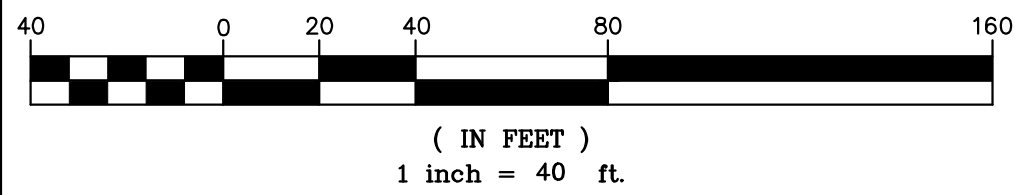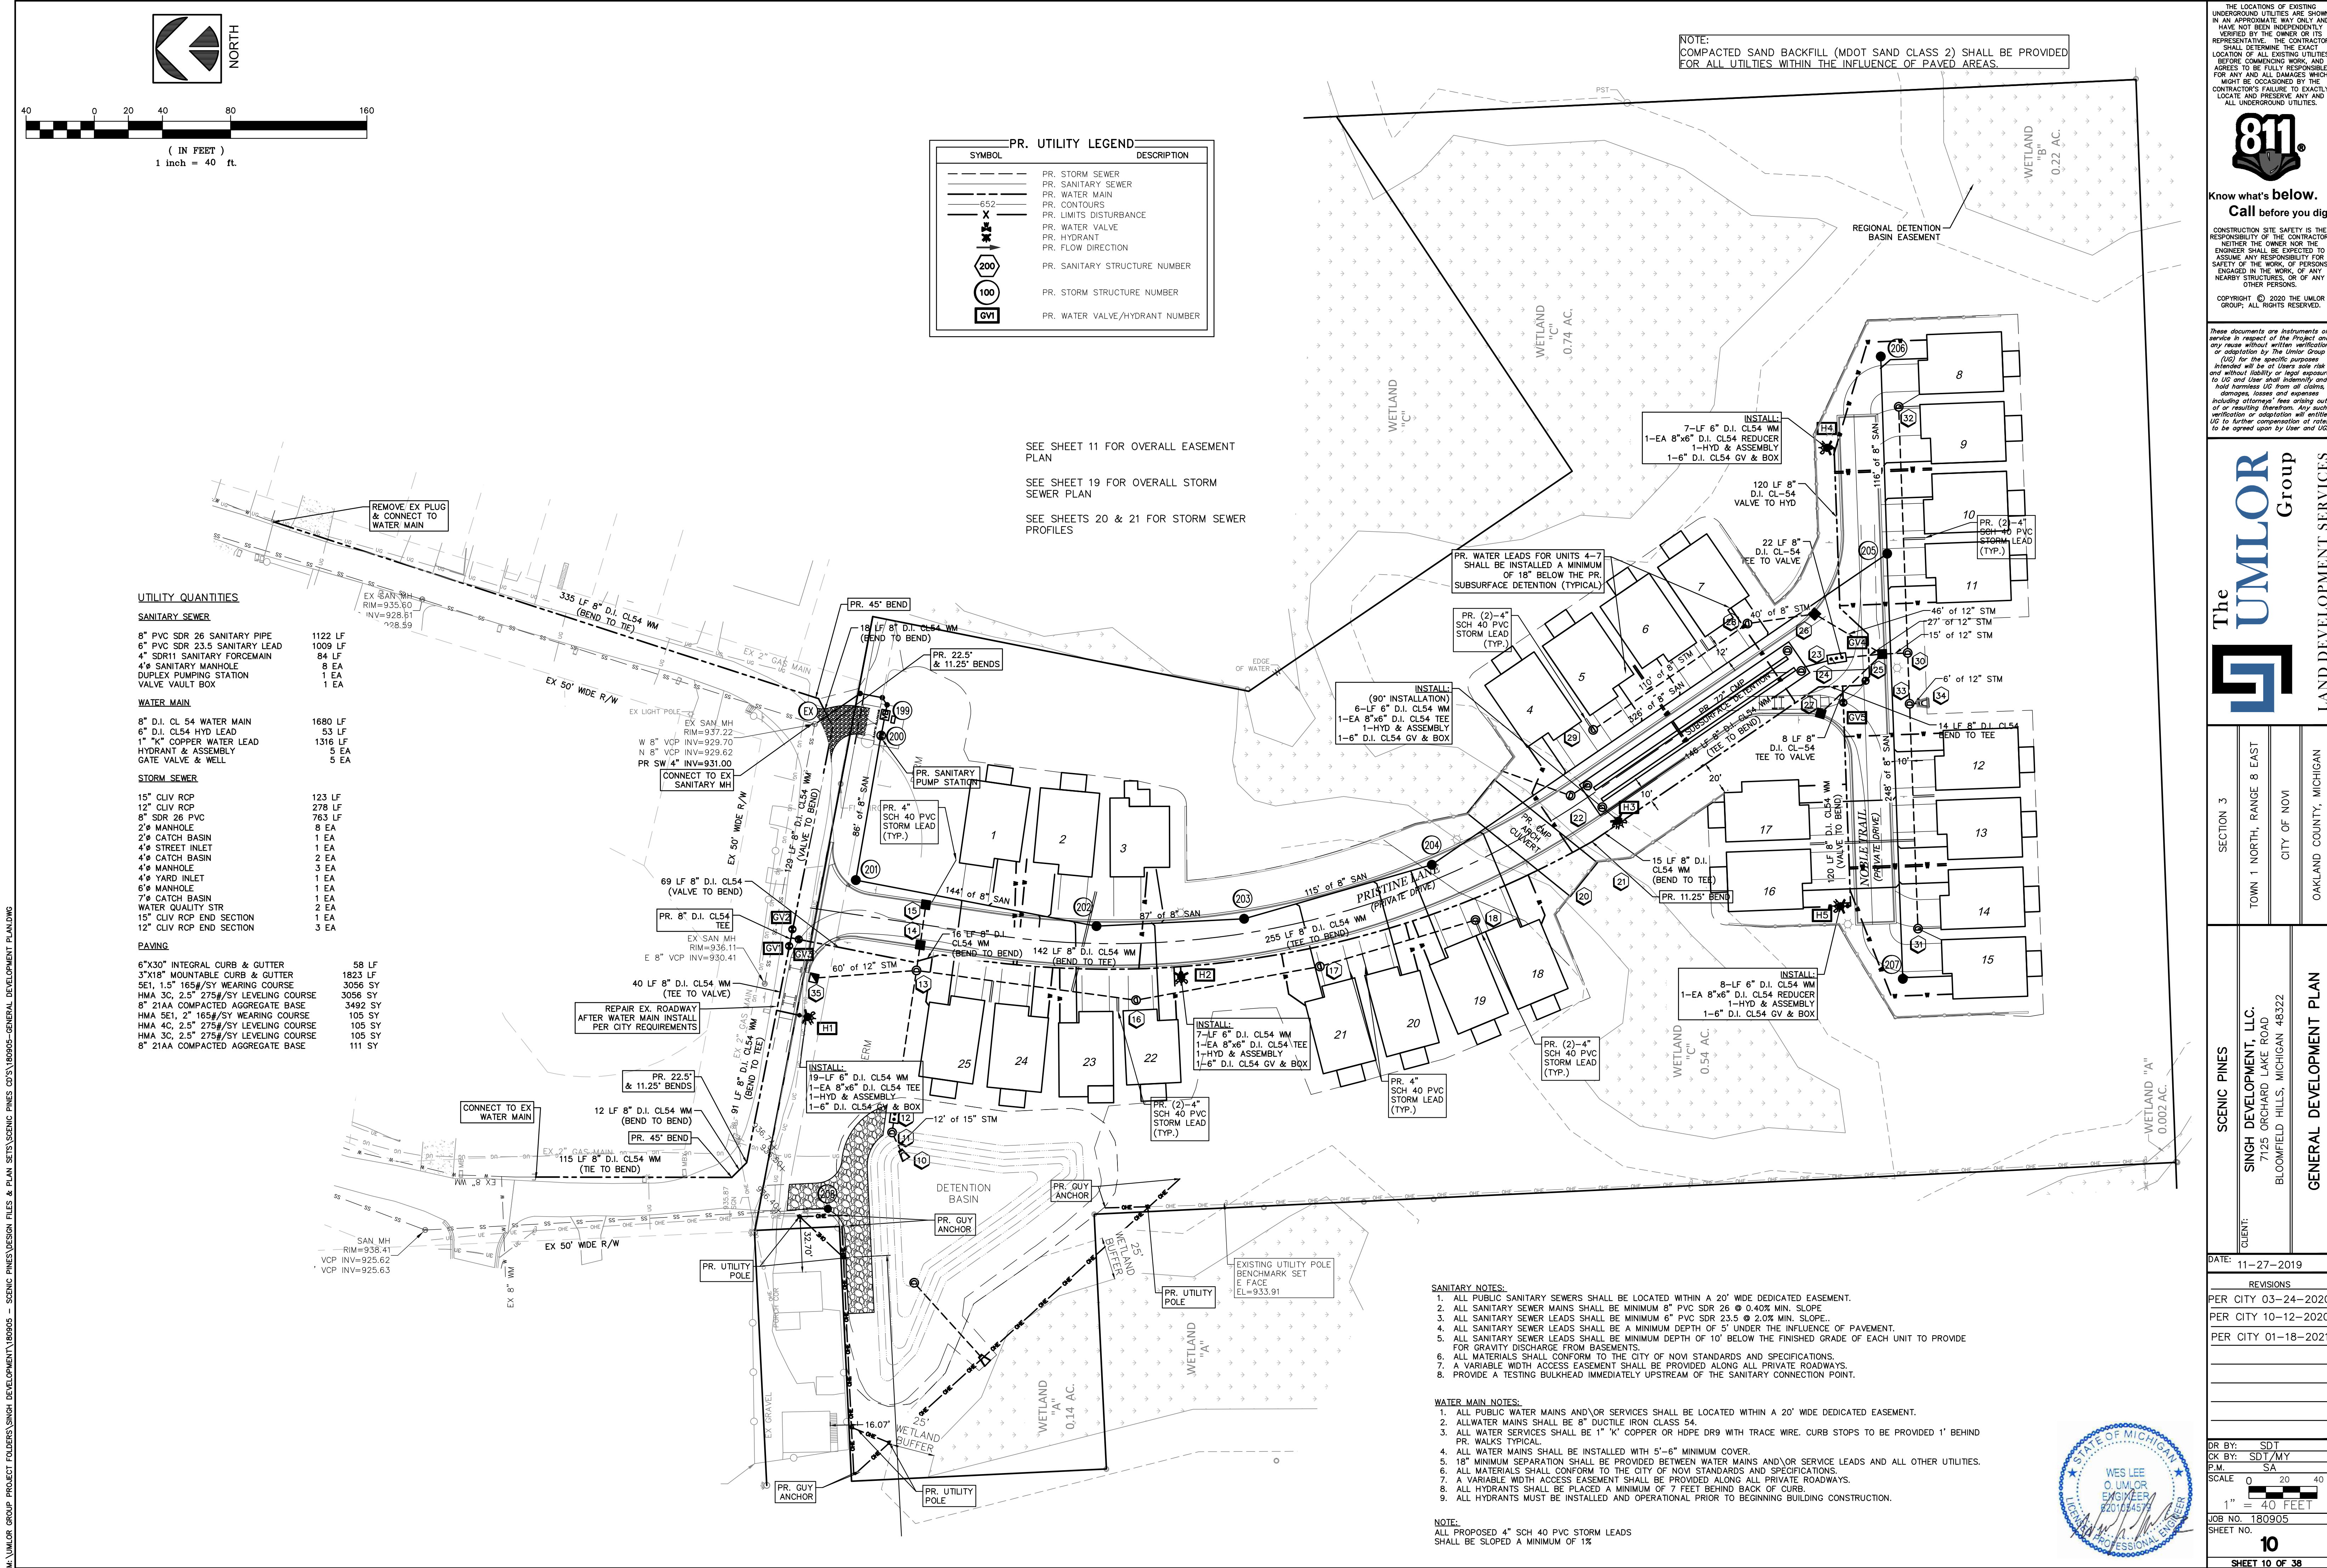

PR. UTILITY LEGEND	
SYMBOL	DESCRIPTION
---	PR. STORM SEWER
---	PR. SANITARY SEWER
---	PR. WATER MAIN
---	PR. CONTOURS
---	PR. LIMITS DISTURBANCE
---	PR. WATER VALVE
---	PR. HYDRANT
---	PR. FLOW DIRECTION
200	PR. SANITARY STRUCTURE NUMBER
100	PR. STORM STRUCTURE NUMBER
GV1	PR. WATER VALVE/HYDRANT NUMBER

SEE SHEET 11 FOR OVERALL EASEMENT PLAN
SEE SHEET 19 FOR OVERALL STORM SEWER PLAN
SEE SHEETS 20 & 21 FOR STORM SEWER PROFILES

UTILITY QUANTITIES

SANITARY SEWER

8" PVC SDR 26 SANITARY PIPE	1122 LF
6" PVC SDR 23.5 SANITARY LEAD	1009 LF
4" SDR11 SANITARY FORCEMAIN	84 LF
4" SANITARY MANHOLE	8 EA
DUPLEX PUMPING STATION	1 EA
VALVE VAULT BOX	1 EA

WATER MAIN

8" D.I. CL 54 WATER MAIN	1680 LF
6" D.I. CL54 HYD LEAD	53 LF
1" "K" COPPER WATER LEAD	1316 LF
HYDRANT & ASSEMBLY	5 EA
GATE VALVE & WELL	5 EA

STORM SEWER

15" CLV RCP	123 LF
12" CLV RCP	278 LF
8" SDR 26 PVC	763 LF
2" MANHOLE	8 EA
2" CATCH BASIN	1 EA
4" STREET INLET	1 EA
4" CATCH BASIN	2 EA
4" MANHOLE	3 EA
4" YARD INLET	1 EA
6" MANHOLE	1 EA
7" CATCH BASIN	2 EA
WATER QUALITY STR	1 EA
15" CLV RCP END SECTION	1 EA
12" CLV RCP END SECTION	3 EA

PAVING

6"x30" INTEGRAL CURB & GUTTER	58 LF
3"x10" MOUNTABLE CURB & GUTTER	1823 LF
SE1, 1.5" 165#/SY WEARING COURSE	3056 SY
HMA 3C, 2.5" 275#/SY LEVELING COURSE	3056 SY
8" 21AA COMPACTED AGGREGATE BASE	3492 SY
HMA SE1, 2" 165#/SY WEARING COURSE	105 SY
HMA 4C, 2.5" 275#/SY LEVELING COURSE	105 SY
HMA 3C, 2.5" 275#/SY LEVELING COURSE	105 SY
8" 21AA COMPACTED AGGREGATE BASE	111 SY

NOTE:
COMPACTED SAND BACKFILL (MDOT SAND CLASS 2) SHALL BE PROVIDED FOR ALL UTILITIES WITHIN THE INFLUENCE OF PAVED AREAS.

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SCENIC PINES

SINGH DEVELOPMENT, LLC.

7125 ORCHARD LAKE ROAD

BLOOMFIELD HILLS, MICHIGAN 48322

GENERAL DEVELOPMENT PLAN

DATE: 11-27-2019

REVISIONS

PER CITY 03-24-2020

PER CITY 10-12-2020

PER CITY 01-18-2021

OR BY: SDT

CK BY: SDT/MY

P.M. SA

SCALE 0 20 40

1" = 40 FEET

JOB NO. 180905

SHEET NO. 10

SHEET 10 OF 38



Know what's below.
Call before you dig.

TRACY GALLOWAY
202 BUFFINGTON ST.
NOVI, MI 48377

NOVI, MI 48377

50-22-03-377-014
RICHARD GUNTHER
211 HENNING ST.
NOVI, MI 48377

50-22-03-377-011
TODD & LOIS NEFF
217 HENNING ST.
NOVI, MI 48377

MAINTENANCE REQUIREMENTS


- STREET SCRAPING (DAILY)
- STREET SWEEPING (WEEKLY MINIMUM)
- STRUCTURAL SEDIMENT CONTROLS (SILT FENCE, INLET FILTERS, SEDIMENT TRAPS) INSPECT AND MAINTAIN ON A WEEKLY BASIS UNTIL SITE IS STABILIZED. RECORD SITE CONDITIONS AND NECESSARY REPAIRS IN A LOGBOOK ONCE A WEEK AND WITHIN 24 HOURS AFTER A STORM EVENT IF REQUIRED BY THE NPDES PERMIT (5 ACRES OR GREATER IN SIZE).

CONSTRUCTION NOTES

ANY EXISTING TELEPHONE LINES TO BE RELOCATED MUST BE REPLACED WITH UNDERGROUND LINES.

VIOLATIONS/CITATIONS

- ROUTINE INSPECTIONS WILL BE PERFORMED ON YOUR PROJECT BY THE CITY OF NOVI OR ITS AGENT ONCE A WEEK.
- UPON COMPLETION OF INSPECTION, THE SITE IS FOUND NOT IN COMPLIANCE WITH THE CITY OF NOVI'S SOIL EROSION AND SEDIMENTATION CONTROL ORDINANCE, THEN THE PERMIT HOLDER/SIGNER WILL BE ISSUED, BY HAND, MAIL OR FAX, A "NOTICE OF EROSION CONTROL DEFICIENCY" LETTER, THAT WILL INCLUDE ALL CURRENT AND PERTINENT NON-COMPLIANCE ITEMS, THE SITE AND/OR DEVELOPMENT WILL HAVE PRE-DETERMINED AMOUNT OF TIME, FROM THE DATE OF THE "NOTICE" TO RECTIFY THESE ITEMS.
- IF ALL OF THE ITEMS HAVE NOT BEEN ADDRESSED AFTER THE ELAPSED TIME SPECIFIED, THE PERMIT HOLDER/SIGNER WILL RECEIVE A "NON-COMPLIANCE" LETTER, WHICH WILL INCLUDE A "NOTICE TO SHOW CAUSE."
- UPON RECEIPT OF THE "NON-COMPLIANCE" LETTER AND "NOTICE TO SHOW CAUSE," THE PERMIT HOLDER/SIGNER WILL ATTEND A SHOW CAUSE HEARING AS WELL AS PAY A RE-INSPECTION FEE IN THE AMOUNT OF \$250.00 TO THE CITY OF NOVI FOR ADDITIONAL INSPECTIONS, HEARINGS AND REPORT FOLLOW-UP. THE BEFORE MENTIONED ACTIVITIES MUST TAKE PLACE WITHIN 24 HOURS UPON RECEIPT OF THE LETTER. AFTER THE HEARING, THE PROJECT/DEVELOPMENT MAY BE ISSUED A "STOP WORK" ORDER.
- IF A CITATION IS ISSUED TO THE PERMIT HOLDER/SIGNER AFTER THE SHOW CAUSE HEARING, AND ADDITIONAL \$400.00 WILL BE PAID TO THE CITY OF NOVI, FOR FOLLOW-UP INSPECTIONS, MEETINGS AND OTHER EXPENSES INCURRED.SILT FENCE

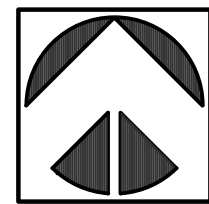

NORTH



(IN FEET)
1 inch = 40' ft.

NOTES:

IF DEWATERING IS ENCOUNTERED DURING CONSTRUCTION A DEWATERING PLAN MUST BE SUBMITTED TO THE ENGINEERING DIVISION FOR REVIEW AND APPROVAL.

IT IS THE DEVELOPER'S RESPONSIBILITY TO GRADE AND STABILIZE DISTURBANCES DUE TO THE INSTALLATION OF PUBLIC UTILITIES.

CATCH BASIN INLET FILTERS SHALL BE INSTALLED ON EXISTING ROADWAYS ALONG CONSTRUCTION ROUTE FOR A REASONABLE DISTANCE FROM SITE.

STREET SWEEPING AND DUST CONTROL ARE THE RESPONSIBILITY OF THE CONTRACTOR AND SHALL BE DONE AS NEEDED OR DIRECTED BY THE ENGINEER AND/OR CITY STAFF.

VEGETATION SHALL BE ESTABLISHED WITHIN 5 DAYS OF FINAL GRADE, OR WHENEVER DISTURBED AREAS WILL REMAIN UNCHANGED FOR 30 DAYS OR GREATER. 3-4" OF TOPSOIL WILL BE USED WHERE VEGETATION IS REQUIRED.

DIVERSION BERMS OR TERRACING SHALL BE IMPLEMENTED WHERE NECESSARY OR DIRECTED BY THE ENGINEER AND/OR COUNTY STAFF.

CONTRACTOR SHALL OBTAIN SOIL EROSION PERMIT PRIOR TO ANY CONSTRUCTION.

ALL GRADING, EROSION, AND SEDIMENT CONTROL AND RELATED WORK UNDERTAKEN ON THIS SITE SHALL BE IN ACCORDANCE WITH LOCAL JURISDICTION.

CONTRACTOR SHALL MAINTAIN ALL SOIL EROSION CONTROL MEASURES. THE SOIL EROSION CONTROLS WILL BE MAINTAINED WEEKLY AND AFTER EVERY STORM EVENT BY ¼M SILT FENCE. SURROUNDING PAVED AREAS SHALL BE POWER BROOMED AS NECESSARY TO REMOVE MUD TRACKING FROM THE SITE.

THE CONTRACTOR SHALL BE RESPONSIBLE FOR MATCHING EXISTING FACILITIES TO AVOID ANY ABRUPT OR APPARENT CHANGES IN GRADES OR CROSS SLOPES, LOW SPOTS, OR HAZARDOUS CONDITIONS.

GRADING AT THE BOUNDARIES SHALL BE DONE SO AS NOT TO OBSTRUCT THE RUNOFF OF STORM WATER FROM ADJACENT PROPERTIES.

SOD AND HYDROSEEDING SHALL BE DONE IN ACCORDANCE WITH THE LANDSCAPING PLAN. ALL OTHER DISTURBED AREAS SHALL BE TOPSOILED, HYDROSEEDED, FERTILIZED AND MULCHED.

THE CONTRACTOR IS REQUIRED TO HAVE A COPY OF THE CERTIFIED PLAN AT THE CONSTRUCTION SITE.

ALL SOIL EROSION CONTROL PRACTICES TO BE INSTALLED PRIOR TO ANY MAJOR SOIL DISTURBANCE, OR IN THEIR PROPER SEQUENCE AND MAINTAINED FOR ONE YEAR AFTER COMPLETION OF THE APPROVED PLAN OR UNTIL SUCH MEASURES ARE PERMANENTLY STABILIZED AS DETERMINED BY THE TOWNSHIP ENGINEER.

PERMANENT VEGETATION TO BE SEEDDED ON ALL EXPOSED AREAS WITHIN TEN (10) DAYS AFTER FINAL GRADING. MULCH TO BE USED AS NECESSARY FOR PROTECTION UNTIL SEEDING IS ESTABLISHED.

IMMEDIATELY FOLLOWING INITIAL DISTURBANCE OR ROUGH GRADING, ALL CRITICAL AREAS SUBJECT TO EROSION (I.E. STEEP SLOPES) WILL RECEIVE APPROPRIATE VEGETATIVE COVER AS STATED IN THE CONSTRUCTION SEQUENCE.

DURING CONSTRUCTION, ANY ADDITIONAL CONTROL MEASURES AS DEEMED NECESSARY TO PREVENT EROSION OR CONTROL SEDIMENT BEYOND THOSE MEASURES SHOWN ON THE APPROVED PLANS SHALL BE INSTALLED OR EMPLOYED AT THE DIRECTION OF THE ENGINEER.

SLOPES STEEPER THAN 1V:6H SHALL BE STABILIZED WITH EROSION CONTROL BLANKET.

INSTALLATION OF SILT FENCE OR TREE PROTECTION FENCE SHALL NOT OCCUR PRIOR TO THE INITIAL CITY PRE-CONSTRUCTION MEETING. WHEN NATURAL FEATURES EXIST ON THE SITE, INSPECTION OF STAKING MAY BE REQUIRED PRIOR TO INSTALLATION OF THE FENCING.

SEQUENCE OF CONSTRUCTION FOR SOIL EROSION CONTROL

- ATTEND AN PRE-CONSTRUCTION MEETING AT CITY OF NOVI OFFICE ALONG WITH THE APPROPRIATE CITY OF NOVI STAFF.
- INSTALL SILTATION FENCE, OUTLET FILTERS, AND CONSTRUCTION ACCESS ROAD AS SHOWN ON THE SOIL EROSIONCONTROL PLAN.
- STRIP AND STOCKPILE TOPSOIL.
- CONSTRUCT DETENTION BASIN, UNDERGROUND DETENTION & CMP ARCH PIPE CULVERT AND INSTALL STORM SEWER PIPE, STRUCTURES AND SOIL STABILIZATION WITHIN SEDIMENT BASIN. (PERMANENT)
- MASS GRADE AS REQUIRED.
- INSTALL SANITARY SEWERS AND WATER MAINS.
- COMPLETE STORM SEWER INSTALLATION; IMMEDIATELY INSTALL STONE FILTERS ON ALL CATCH BASINS AND INLETS. (TEMPORARY)
- INSTALL ALL PUBLIC UTILITIES COMPLETE (GAS, ELECTRIC, TELEPHONE, AND CABLE TV).
- INSTALL ALL PAVEMENT.
- INSTALL SILTATION FENCE ALONG ROADSIDES WHERE YARDS SLOPE TOWARD ROADS. (TEMPORARY)
- REPAIR AND/OR REPLACE ALL LOW POINT CATCH BASIN FILTERS AS NEEDED.(TEMPORARY)
- FINISH GRADE, REDISTRIBUTE TOP SOIL, AND ESTABLISH VEGETATION ON ALL DISTURBED GROUND AREAS. COMPLETE LANDSCAPING. PRIOR TO INDIVIDUAL LOT DEVELOPMENT, ALL AREAS BETWEEN SIDEWALKS AND ROADS NEED TO BE PERMANENTLY STABILIZED.
- CLEAN PAVEMENT AND STORM SEWERS OF ALL SEDIMENT.
- REMOVE TEMPORARY SOIL EROSION CONTROL MEASURES AFTER PERMANENT VEGETATION HAS BEEN ESTABLISHED.
- IT IS THE RESPONSIBILITY OF THE DEVELOPER TO INSURE THAT ALL SOIL EROSION CONTROL MEASURES ARE INSTALLED AND MAINTAINED.
- CITY OF NOVI OR ITS AGENT SHALL INSPECT ALL SOIL EROSION CONTROL MEASURES. UPON THEIR DIRECTION, ADDITIONAL MEASURES SHALL BE CONSTRUCTED OR MAINTENANCE WORK SHALL BE PERFORMED TO ASSURE PROPER EROSION AND SEDIMENTATION CONTROL.REMOVAL OF CONTROL MEASURES MAY ONLY TAKE PLACE ONE ENTIRE SITE IS FULLY STABILIZED.
- DUST MUST BE CONTROLLED AT ALL TIMES.
- ALL MUD TRACKED ON PUBLIC ROADS AND INTERIOR ROADS SHALL BE REMOVED DAILY.

DISTURBED AREA ±3.93 ACRES
±53.3% UNDISTURBED

NOTES:

- PROVIDE FILTER ON STANDPIPE OUTLET STRUCTURE UNTIL SITE IS STABILIZED, THEN REMOVE.
- THE STORM WATER BASIN WILL BE STABILIZED PRIOR TO DIRECTING FLOW TO BASIN.
- A RING OF SILT FENCE WILL BE INSTALLED SURROUNDING ANY STOCKPILE MATERIAL.

SIDEWALK NOTE:

SIDEWALK WITHIN RIGHT-OF-WAY SHALL MATCH EXISTING GRADE AT BOTH ENDS OF PROJECT AREA.

NOTE "A":

TEMPORARY SILT FENCE TO BE INSTALLED FOR CONSTRUCTION OF RETAINING WALLS & SHALL BE REMOVED AFTER COMPLETION OF RETAINING WALL CONSTRUCTION. PERMANENT SILT FENCE SHALL BE PLACED AS SHOWN. NO ADDITIONAL TREE REMOVAL SHALL TAKE PLACE FOR INSTALLATION OF TEMPORARY SILT FENCE AND NO GRADING SHALL BE DONE BETWEEN THE TEMPORARY SILT FENCE & SILT FENCE AS ORIGINALLY PROPOSED.

Map Unit Symbol	Map Unit Name
13B	Oshtemo-Boyer loamy sands, 0 to 6 percent slopes
27	Houghton and Adrian mucks
54A	Matherton sandy loam, 0 to 3 percent slopes
40A	Udorthents, loamy, nearly level

6	SEEDING WITH MULCH AND/OR MATING	FACILITATES ESTABLISHMENT OF VEGETATIVE COVER EFFECTIVE FOR DRAINAGEWAYS WITH LOW VELOCITY EASILY PLACED IN SMALL QUANTITIES BY INEXPERIENCED PERSONNEL SHOULD INCLUDE PREPARED TOPSOIL BED
7	HYDRO-SEEDING	EFFECTIVE ON LARGE AREAS MULCH TAKING AGENT USED TO PROVIDE IMMEDIATE PROTECTION UNTIL GRASS IS ROOTED SHOULD INCLUDE PREPARED TOPSOIL BED
15	PAVING	PROTECTS AREAS WHICH CANNOT OTHERWISE BE PROTECTED, BUT INCREASES RUNOFF VOLUME AND VELOCITY IRREGULAR SURFACE WILL HELP SLOPE VELOCITY
16	CURB AND GUTTER	KEEPS HIGH VELOCITY RUNOFF ON PAVED AREAS FROM LEAVING THE PAVED SURFACE COLLECTS AND CONDUCTS RUNOFF TO ENCLOSED DRAINAGE SYSTEM OR PREPARED DRAINAGEWAY
36	CATCH BASIN, DRAIN INLET	COLLECTS HIGH VELOCITY CONCENTRATED RUNOFF MAY USE FILTER CLOTH OVER INLET
54	FILTER FENCING	USES GEOTEXTILE FABRIC AND POSTS OR POLES EASY TO CONSTRUCT AND LOCATE AS NECESSARY

LOCATION MAP
1"=4000'



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The UMLOR Group
LAND DEVELOPMENT SERVICES



SECTION 3
TOWN 1 NORTH, RANGE 8 EAST
CITY OF NOVI
OAKLAND COUNTY, MICHIGAN

SCENIC PINES
CLIENT: SINGH DEVELOPMENT, LLC.
7125 ORCHARD LAKE ROAD
BLOOMFIELD HILLS, MICHIGAN 48322
SITE EROSION CONTROL PLAN

DATE: 11-27-2019
REVISIONS
PER CITY 03-24-2020
PER CITY 10-12-2020
PER CITY 01-18-2021




DR BY: SDT
CK BY: SDT/JMY
P.M. SA
SCALE 0 20 40
1" = 40 FEET
JOB NO. 180905
SHEET NO. 12
SHEET 12 OF 38

M:\UMLOR GROUP PROJECT FOLDERS\SCENIC PINES DEVELOPMENT\180905 - SCENIC PINES\DESIGN FILES & PLAN SETS\SCENIC PINES CD\180905-SITE EROSION CONTROL PLAN.DWG

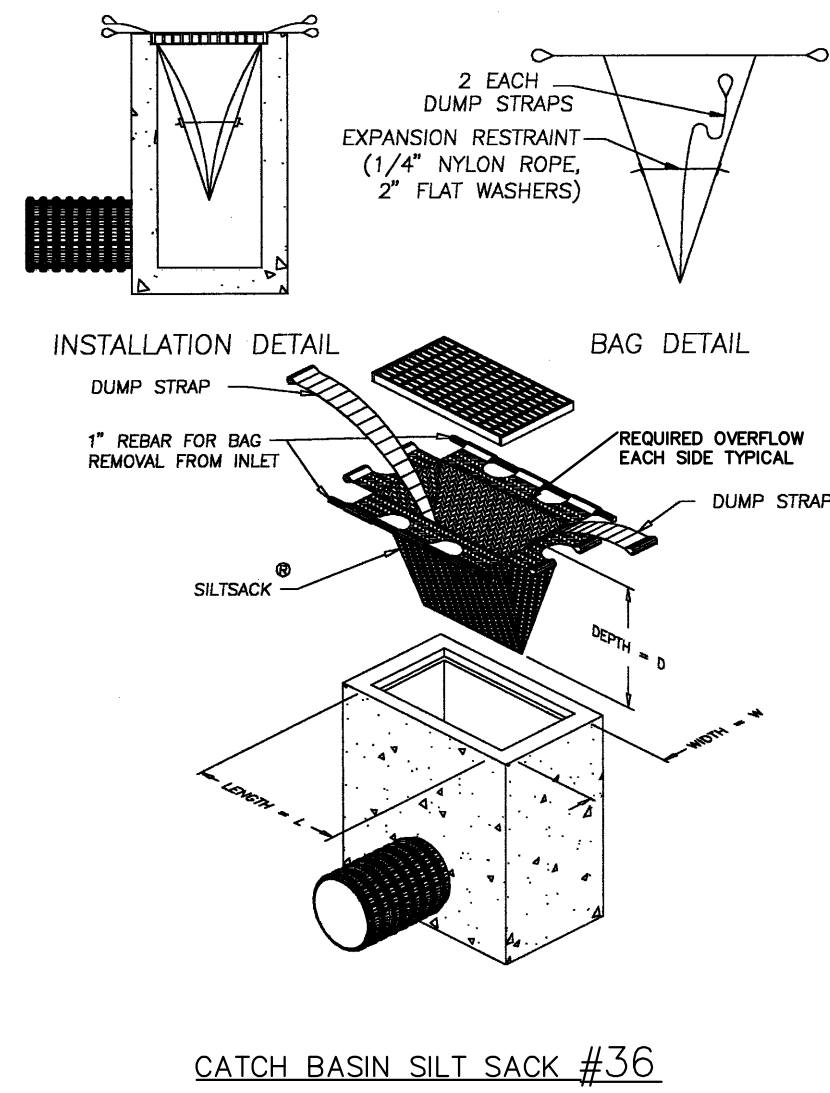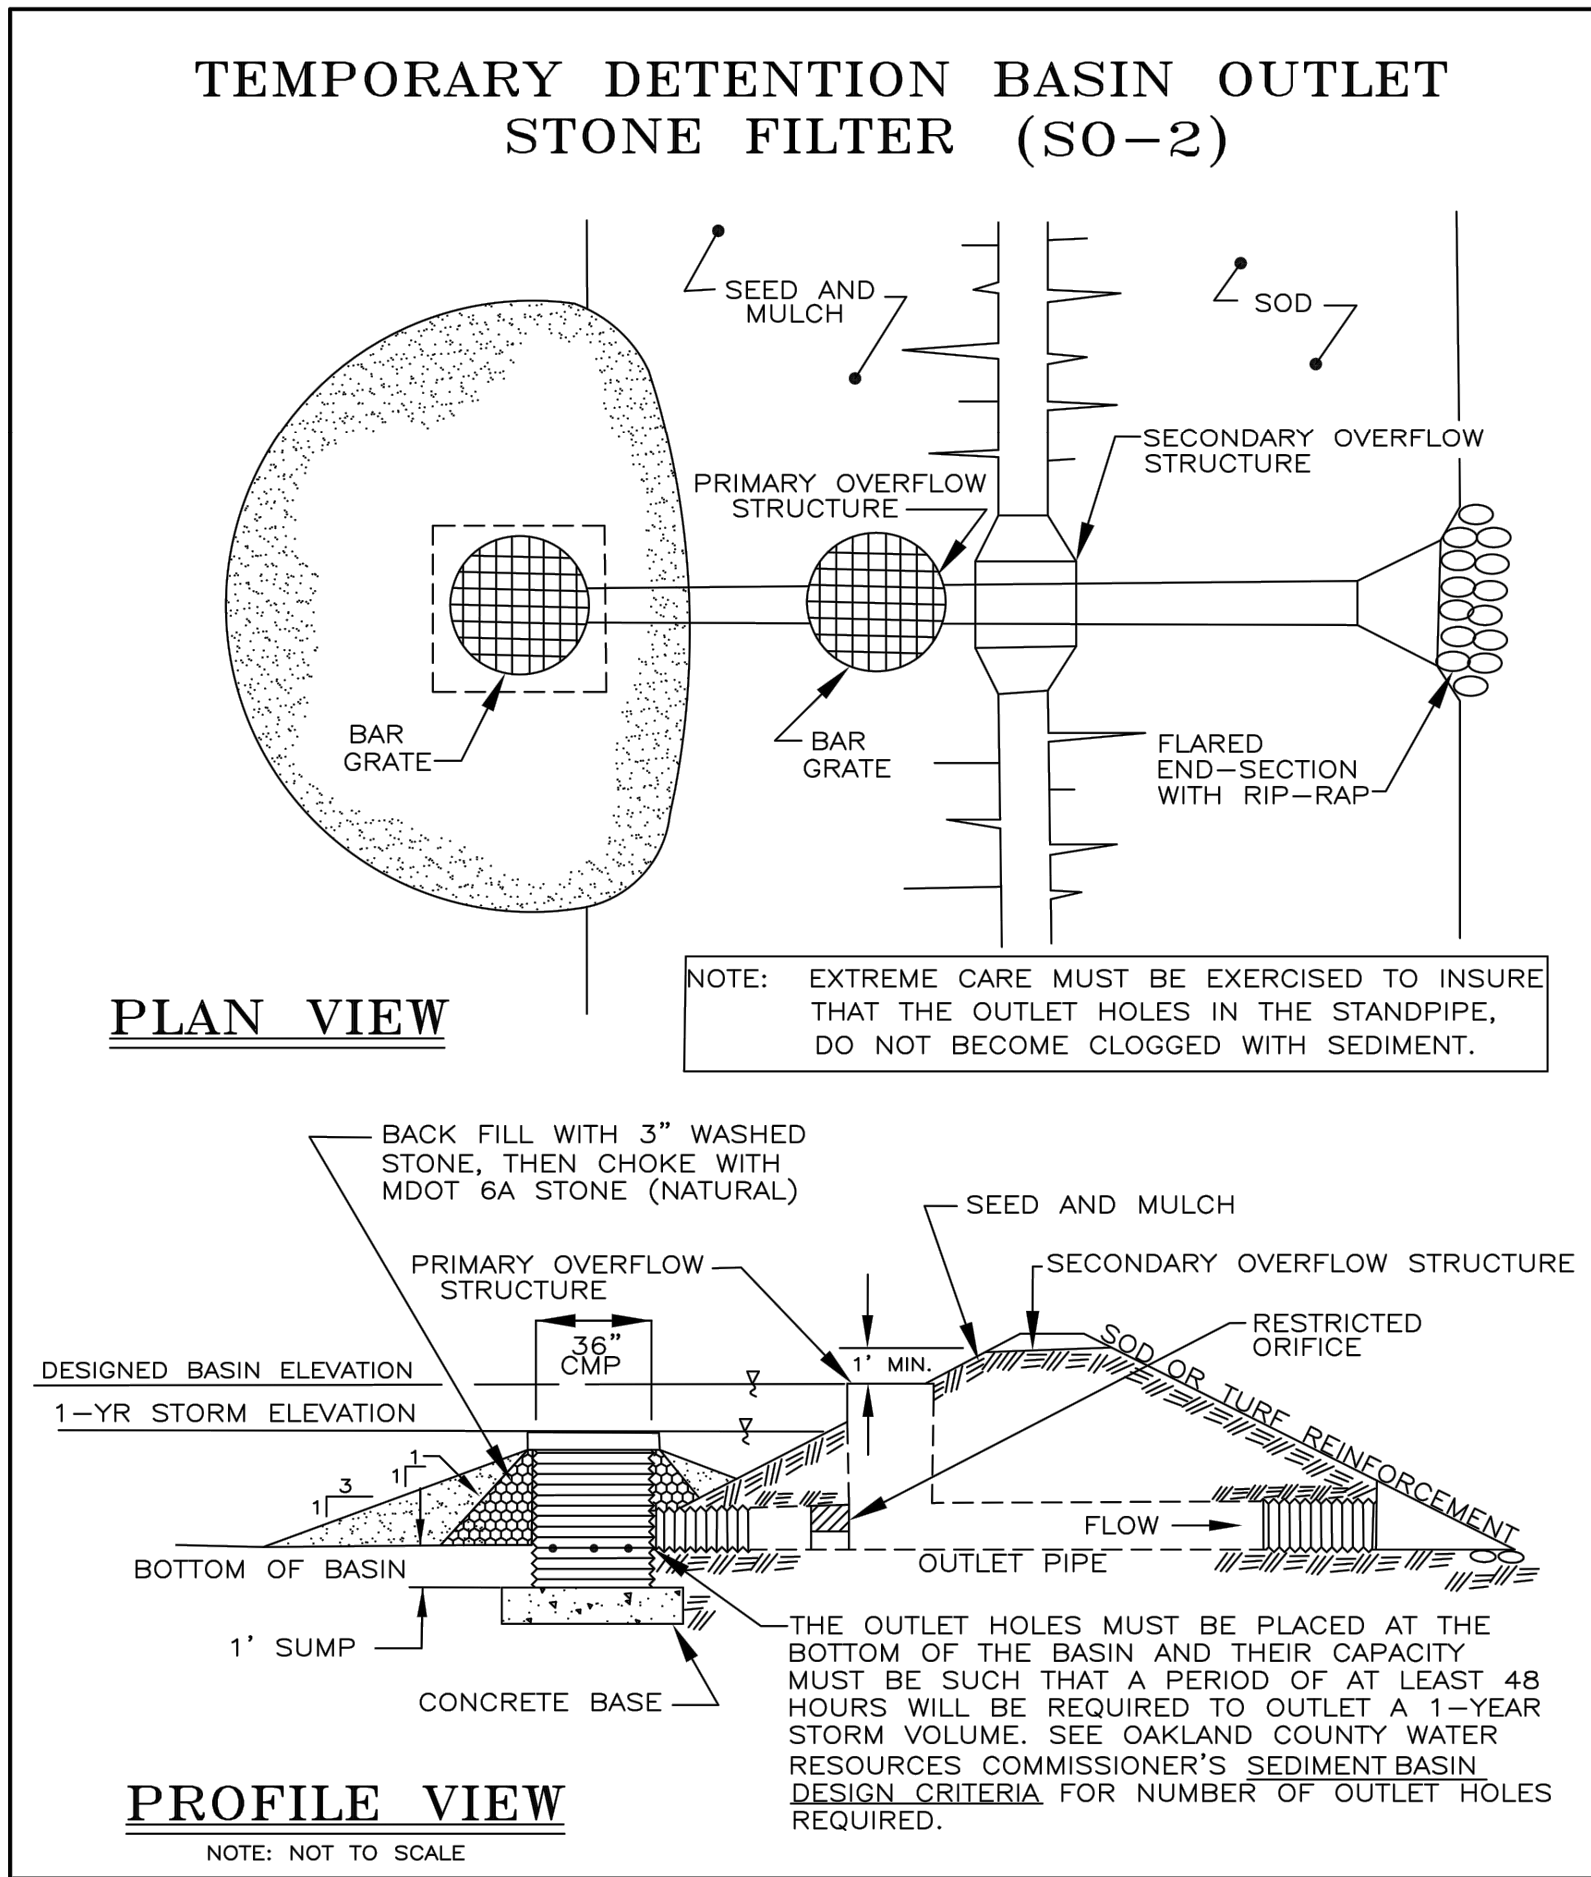


HI-FLOW SILT SACK
(For areas of moderate to heavy precipitation and run-off)



PROPERTIES	TEST METHOD	UNITS
GRAB TENSILE STRENGTH	ASTM D-4632	265 LBS
GRAB TENSILE ELONGATION	ASTM D-4632	20%
PUNCTURE	ASTM D-4833	135 LBS
MULLEN BURST	ASTM D-3786	420 PSI
TRAPEZOID TEAR	ASTM D-4533	45 LBS
UV RESISTANCE	ASTM D-4355	50%
APPARENT OPENING SIZE	ASTM D-4751	20 US SIEVE
FLOW RATE	ASTM D-4491	200 GAL/MIN/SQ FT
PERMITTIVITY	ASTM D-4491	1.5 SEC -1

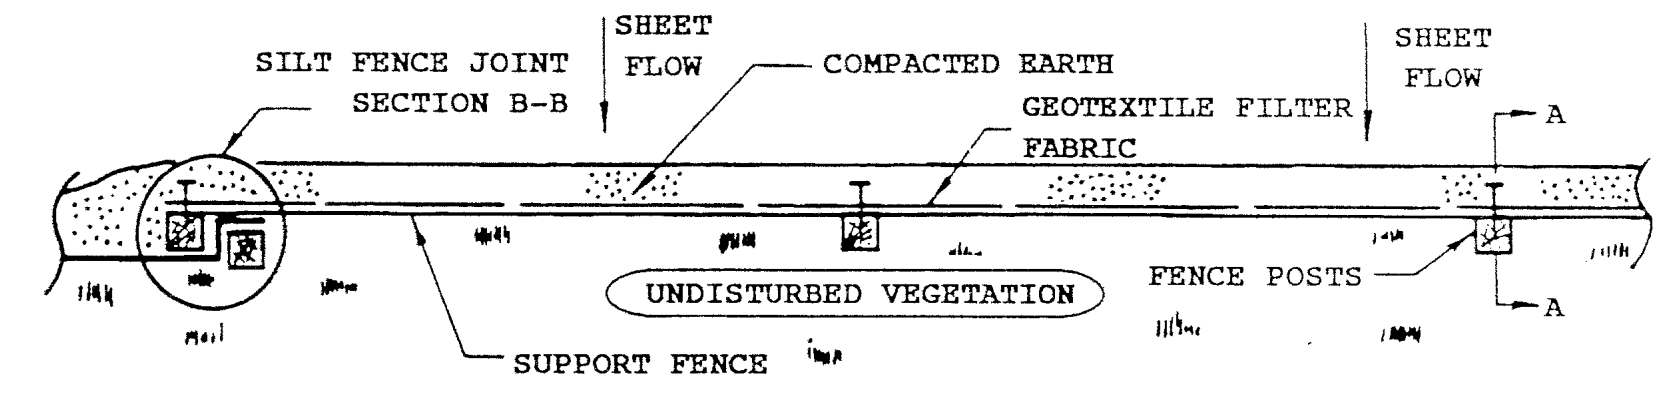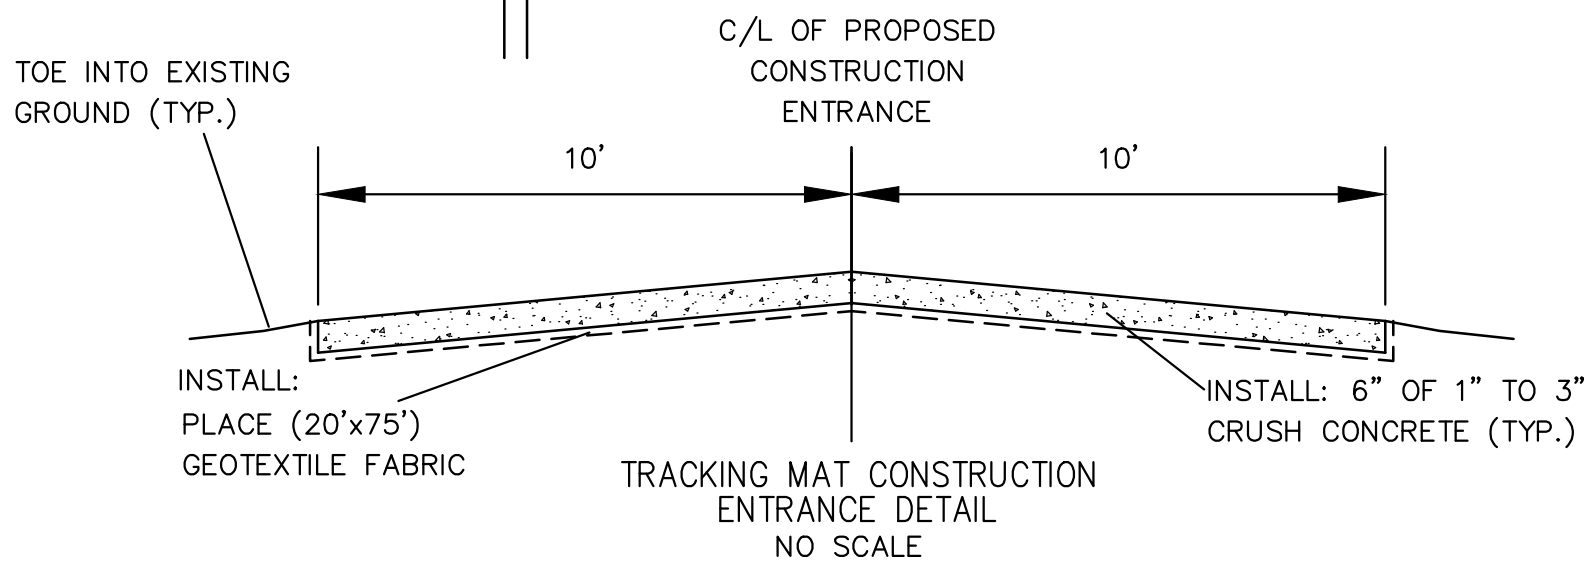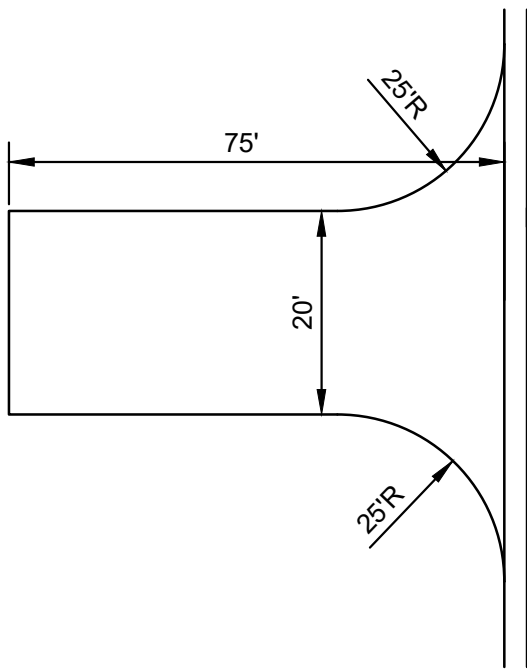

PLAN VIEW

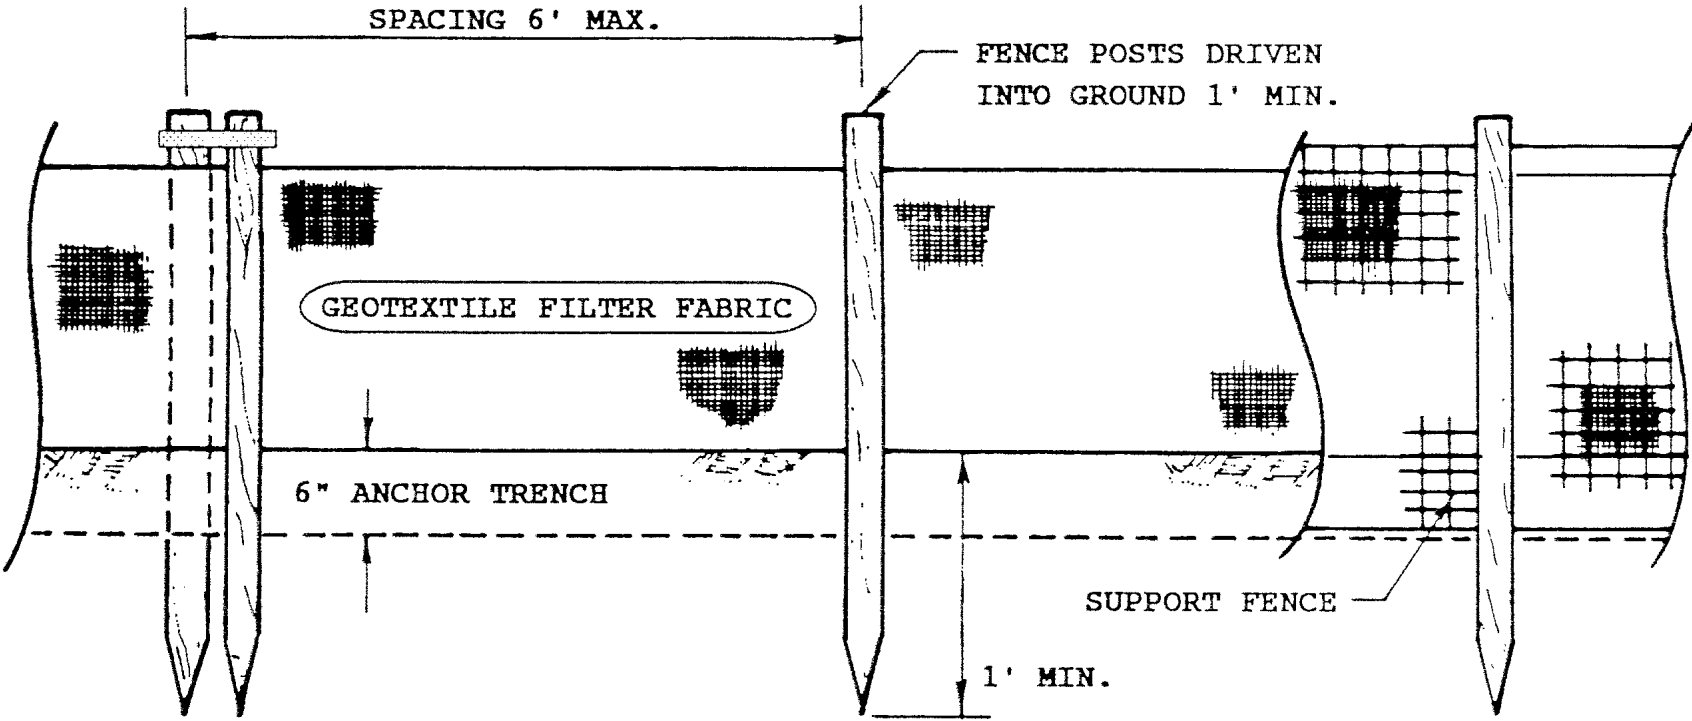

FRONT VIEW

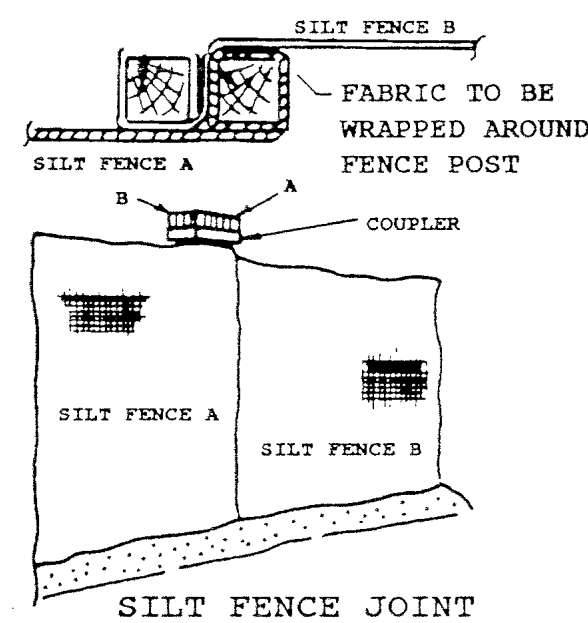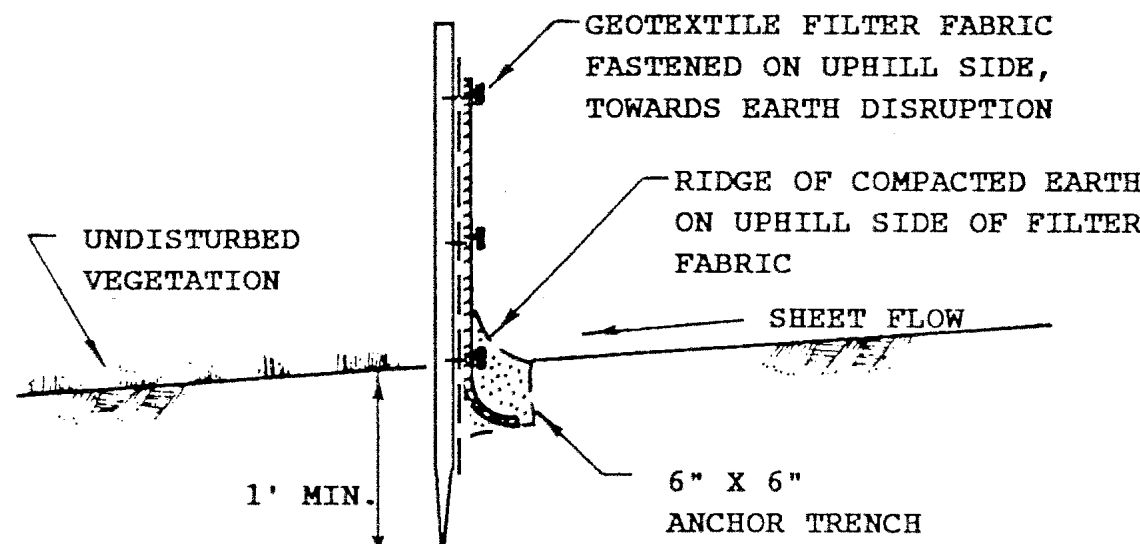

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The UMLOR Group

LAND DEVELOPMENT SERVICES

SECTION 3	TOWN 1 NORTH, RANGE 8 EAST	CITY OF NOVI	OAKLAND COUNTY, MICHIGAN
SCENIC PINES	SINGH DEVELOPMENT, LLC. 7125 ORCHARD LAKE ROAD BLOOMFIELD HILLS, MICHIGAN 48322		
CLIENT:			
EROSION CONTROL DETAILS			

DATE: 11-27-2019

REVISIONS

PER CITY 03-24-2020

PER CITY 10-12-2020


PER CITY 01-18-2021

OR BY: SDT
CK BY: SDT/MY
P.M. SA
SCALE 0
NO SCALE
JOB NO. 180905
SHEET NO. 13
SHEET 13 OF 38

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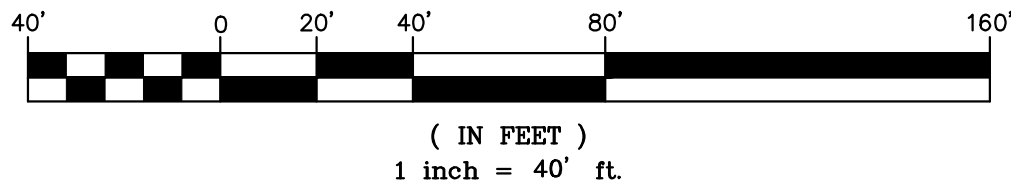
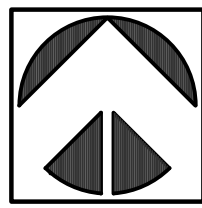


LEGEND	
SYMBOL	DESCRIPTION
× 656.5	EX. SPOT ELEVATION
—	EX. CONTOUR
—	EX. DITCH
—	EX. GRAVEL
—	EX. WATER MAIN
—	EX. WATER VALVE
—	EX. HYDRANT
—	EX. WATER MANHOLE
—	EX. WATER METER
—	EX. STORM SEWER
—	EX. STORM INLET/CATCH BASIN
—	EX. ROUND STORM CATCH BASIN
—	EX. STORM MANHOLE
—	EX. STORM END SECTION
—	EX. SANITARY SEWER
—	EX. SANITARY MANHOLE
—	EX. CLEAN OUT
—	EX. SANITARY VENT
—	EX. UNDERGROUND GAS
—	EX. GAS VALVE
—	EX. GAS METER
—	EX. UNDERGROUND TELEPHONE
—	EX. TELEPHONE MANHOLE
—	EX. TELEPHONE RISER
—	EX. TELEPHONE HANDHOLE
—	EX. UNDERGROUND ELECTRIC
—	EX. ELECTRIC MANHOLE
—	EX. ELECTRIC RISER
—	EX. ELECTRIC HANDHOLE
—	EX. ELECTRIC TRANSFORMER
—	EX. GENERATOR
—	EX. WATER MARKER
—	EX. GAS MARKER
—	EX. OVERHEAD CABLE
—	EX. OVERHEAD FIBER
—	EX. OVERHEAD ELECTRIC
—	EX. UNDERGROUND CABLE
—	EX. COMMUNICATION RISER
—	EX. COMMUNICATION HANDHOLE
—	EX. UTILITY POLE
—	EX. GUY ANCHOR
—	EX. LIGHT POLE
—	EX. GROUND LIGHT
—	EX. SINGLE POLE SIGN
—	EX. MAILBOX
—	EX. UNKNOWN MANHOLE
—	EX. SECTION LINE
—	EX. PARCELS
—	EX. EASEMENT
—	EX. CENTERLINE
—	EX. WETLAND LIMITS
—	EX. CURB/PAVEMENT
—	EX. FENCE
—	SECTION CORNER
—	POST
—	BOLLARD
—	RECORDED BEARING
—	MEASURED BEARING
—	EX. TREE
—	EX. MEDIA MARKER
—	EX. COMM. MARKER
—	EX. TELE. MARKER
—	EX. FIBER MARKER

PR. UTILITY LEGEND	
SYMBOL	DESCRIPTION
—	PR. STORM SEWER
—	PR. CONTOURS
—	PR. LIMITS DISTURBANCE
×	PR. WATER VALVE
—	PR. HYDRANT
—	PR. FLOW DIRECTION
R*	A.D.A RAMP
L*	LANDING
TC	TOP OF CURB
GU	GUTTER

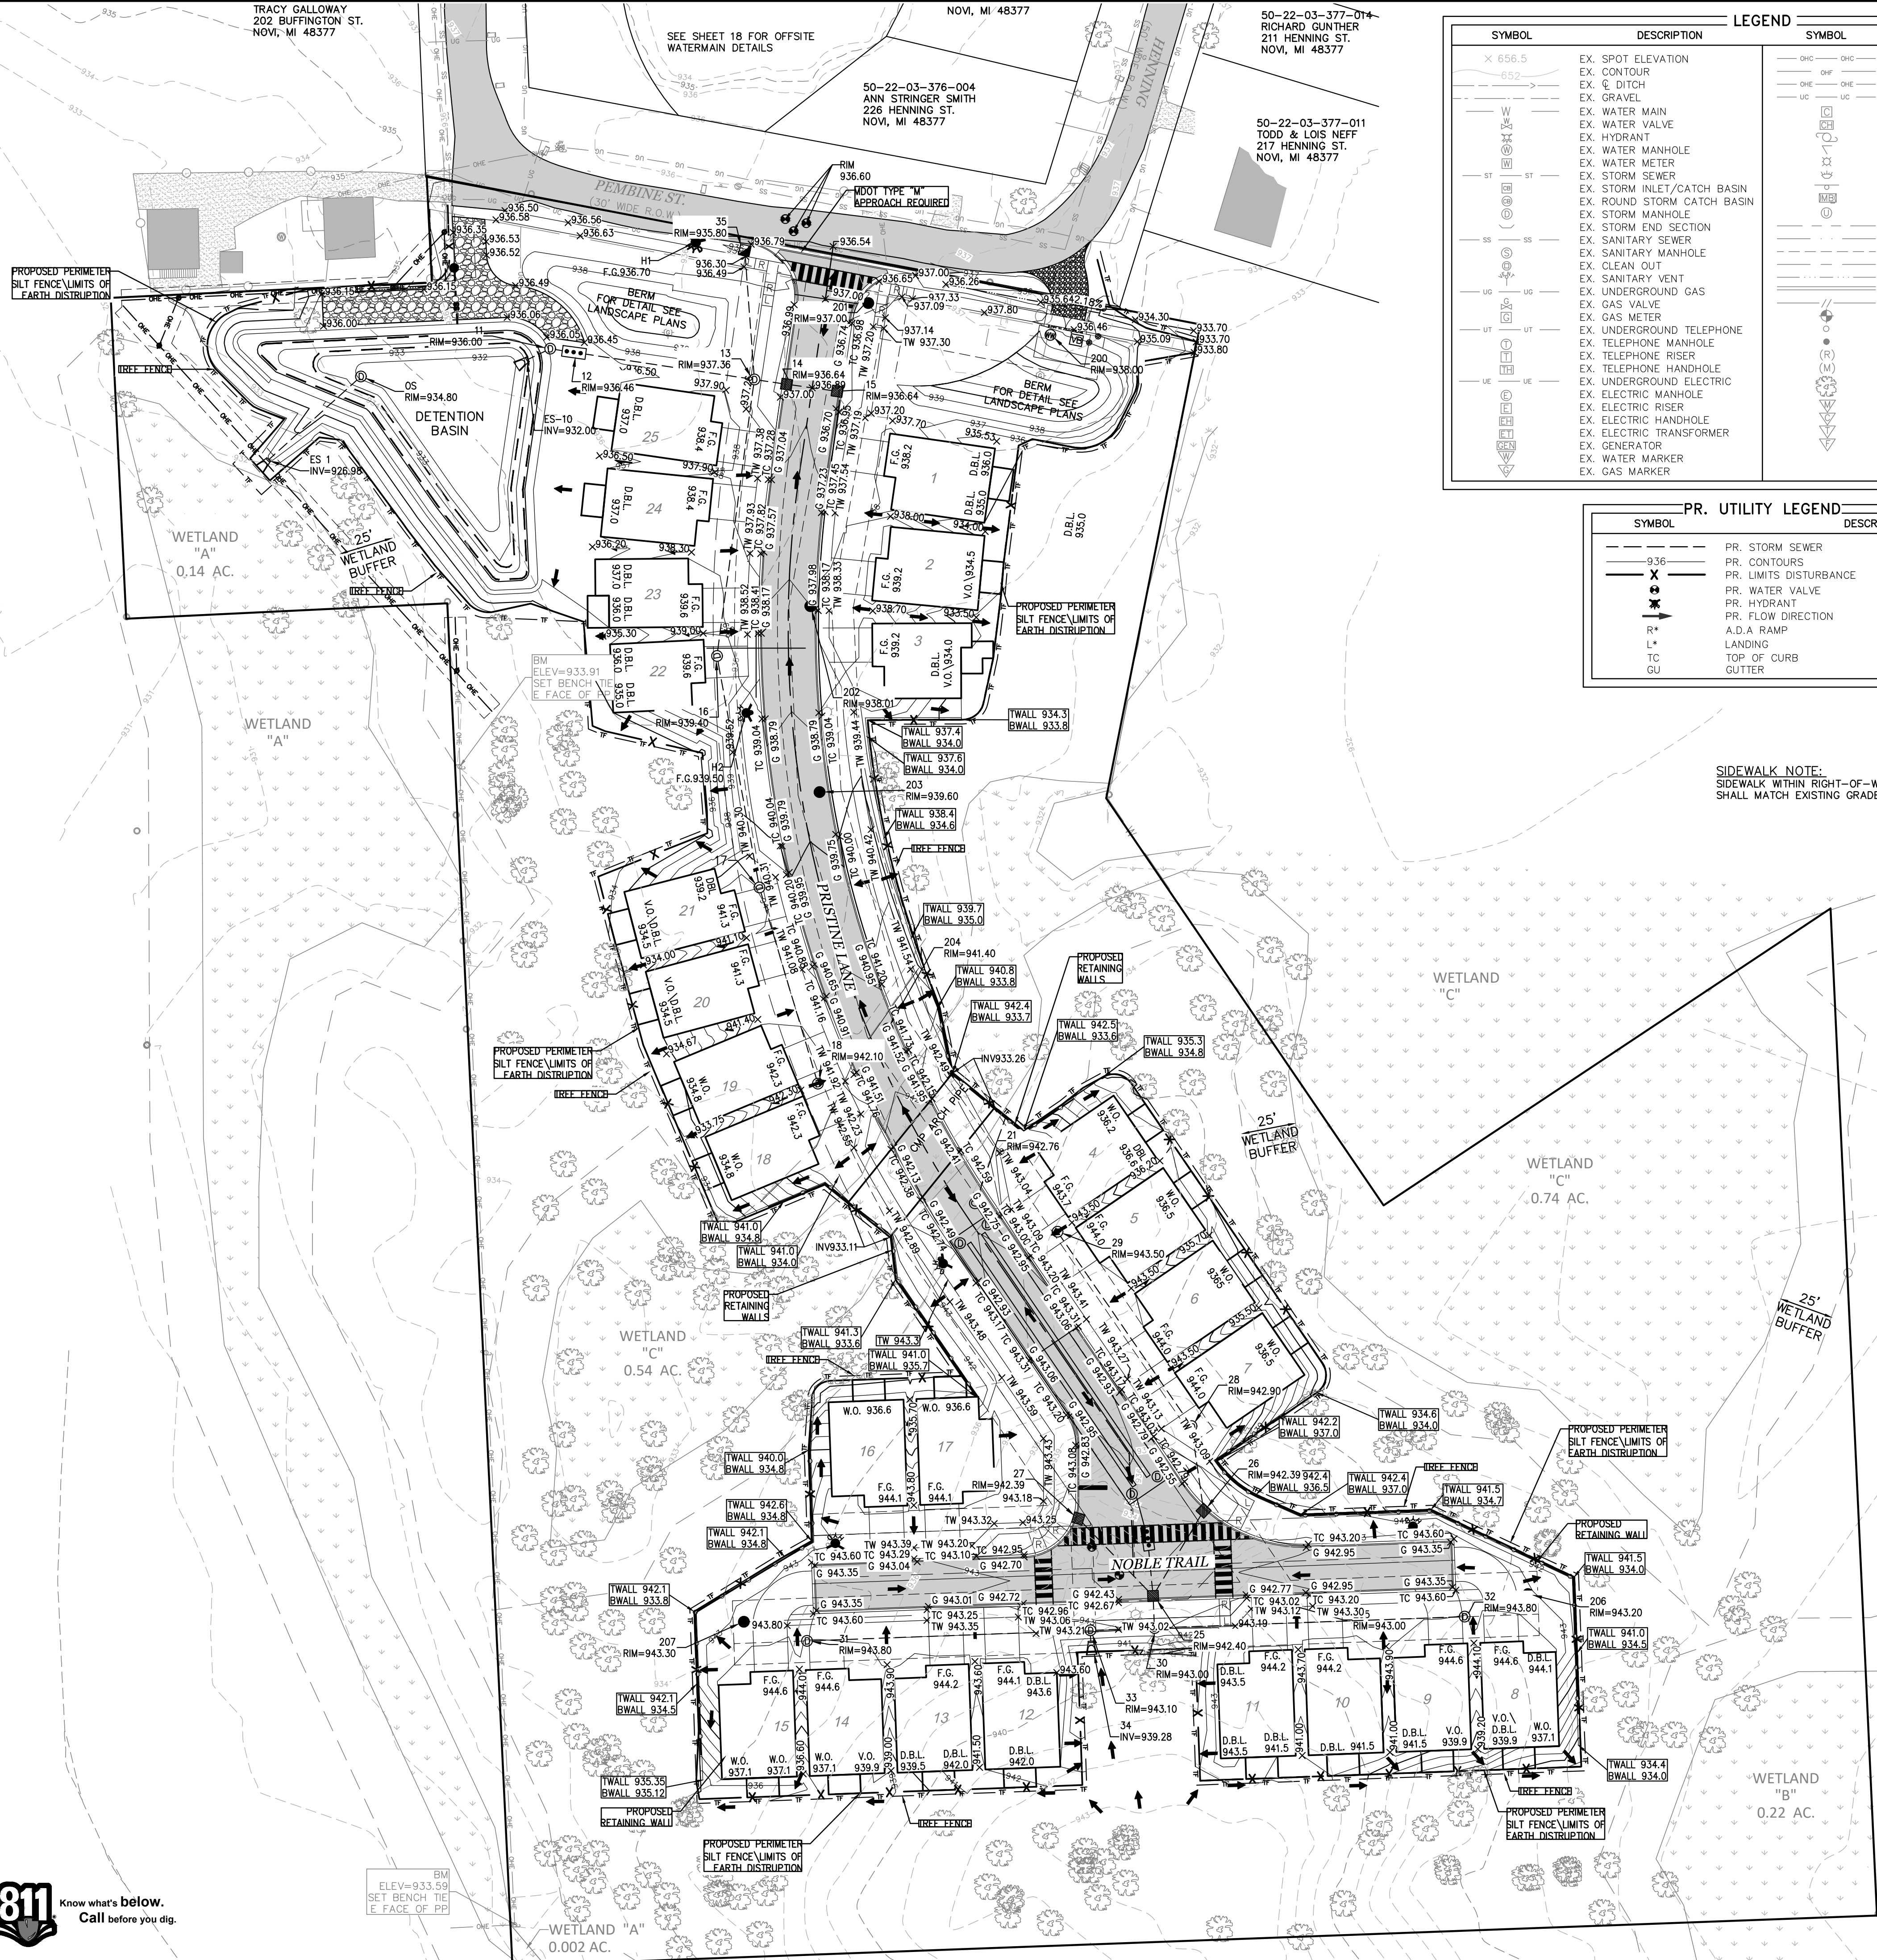SIDEWALK NOTE:
SIDEWALK WITHIN RIGHT-OF-WAY OF PEMBINE, HENNING, BUFFINGTON ST SHALL MATCH EXISTING GRADE AT BOTH ENDS OF PROJECT AREA.

- GRADING NOTES:
1. PRISTINE LANE GRADING SHALL MATCH ELEVATIONS AT PEMBINE ST.
 2. WETLAND BUFFERS IMPACTED BY CONSTRUCTION SHALL BE RESTORED WITH THE WETLAND EDGE SEED MIX SPECIFIED ON LANDSCAPE SHEET L-2 OR APPROPRIATE ALTERNATE.
 3. TEMPORARY STOCKPILING OF MATERIAL IS NOT ANTICIPATED, IF NEEDED, STOCKPILES WILL BE PLACED AT PERMANENT BERM LOCATIONS AND TEMPORARY SILT FENCE SHALL BE INSTALLED SURROUNDING ANY STOCKPILE AREA.
 4. ALL SLOPES STEEPER THAN 1V:6H SHALL BE STABILIZED WITH EROSION BLANKET.
 5. ALL CULVERT END SECTIONS MUST BE PROVIDED WITH GROUTED RIPRAP IN ACCORDANCE WITH CITY SPECIFICATIONS.
 6. INSTALLATION OF SILT FENCING AND TREE FENCING SHALL NOT OCCUR PRIOR TO THE INITIAL CITY PRE-CONSTRUCTION MEETING.
 7. RETAINING WALLS SHALL BE PER DETAILS PROVIDED BY WALL ENGINEER.
 8. IT IS THE DEVELOPER'S RESPONSIBILITY TO GRADE AND STABILIZE DISTURBANCES DUE TO THE INSTALLATION OF PUBLIC UTILITIES
 9. ALL WORK WITHIN THE RIGHT-OF-WAY OF BUFFINGTON/PEMBINE/HENNING STREETS SHALL MEET OR EXCEED CITY OF NOVI SPECIFICATIONS.
 10. WHERE THE WATERMAIN IS LOCATED IN THE CENTER OF THE ROAD (ALONG PEMBINE STREET) OR REQUIRES WORK IN BOTH SIDES OF THE ROAD, THE CONTRACTOR SHALL REPLACE THE PAVEMENT FROM EDGE TO EDGE, ALONG BUFFINGTON AND HENNING STREETS WHERE THE TRENCH ONLY AFFECTS ONE SIDE OF THE ROAD CONTRACTOR SHALL REPLACE FROM CENTERLINE TO EDGE OF EXISTING PAVEMENT.



THE LOCATIONS OF EXISTING UNDERGROUND UTILITIES ARE SHOWN IN AN APPROXIMATE MANNER AND HAVE NOT BEEN INDEPENDENTLY VERIFIED BY THE OWNER OR ITS REPRESENTATIVE. THE CONTRACTOR SHALL DETERMINE THE EXACT LOCATION OF ALL EXISTING UTILITIES BEFORE COMMENCING WORK, AND AGREES TO BE FULLY RESPONSIBLE FOR ANY AND ALL DAMAGES WHICH MIGHT BE OCCASIONED BY THE CONTRACTOR'S FAILURE TO EXACTLY LOCATE AND PRESERVE ANY AND ALL UNDERGROUND UTILITIES.

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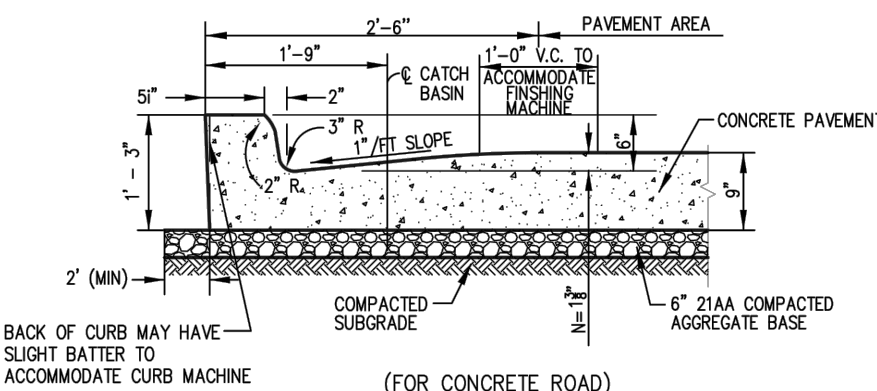
LAND DEVELOPMENT SERVICES

SECTION 3	TOWN 1 NORTH, RANGE 8 EAST	CITY OF NOVI	OAKLAND COUNTY, MICHIGAN
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SCENIC PINES	SINGH DEVELOPMENT, LLC. 7125 ORCHARD LAKE ROAD BLOOMFIELD HILLS, MICHIGAN 48322	SITE GRADING PLAN
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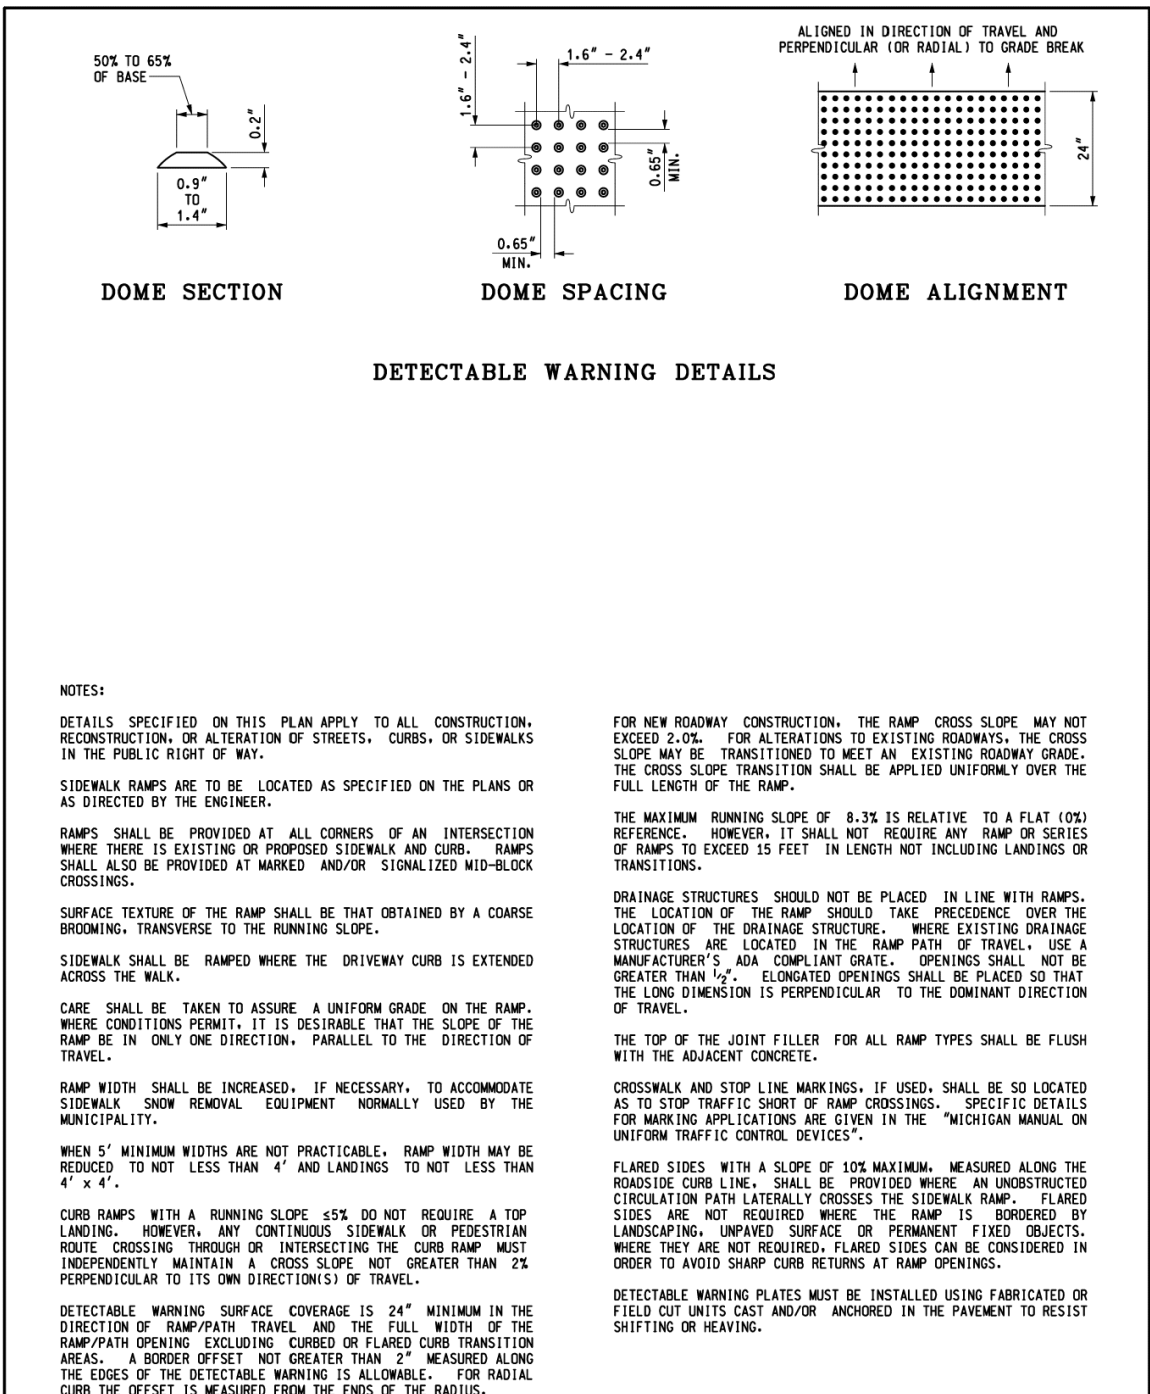
DATE:	11-27-2019
REVISIONS	
PER CITY	03-24-2020
PER CITY	10-12-2020
PER CITY	01-18-2021
OR BY:	SDT
CK BY:	SDT/MY
P.M.	SA
SCALE	0 20 40
1" =	40 FEET
JOB NO.	180905
SHEET NO.	14
SHEET 14 OF 38	





(FOR CONCRETE ROAD)
6" INTEGRAL CURB & GUTTER
M.D.O.T. TYPE 'C'
DETAIL - 3D

SCALE: 1"=20'



SCALE: 1"=20'

SIDEWALK RAMP TYPE F
(FLARED SIDES, TWO RAMPS SHOWN)

MICHIGAN DEPARTMENT OF TRANSPORTATION BUREAU OF DEVELOPMENT STANDARD PLAN FOR SIDEWALK RAMP AND DETECTABLE WARNING DETAILS			
F.E.R.D. APPROVAL	12-11-2017 PLAN DATE	R-28-J	SHEET 7 OF 7

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The UMLOR Group
LAND DEVELOPMENT SERVICES

SECTION 3

TOWN 1 NORTH, RANGE 8 EAST

CITY OF NOVI

OAKLAND COUNTY, MICHIGAN

SCENIC PINES

SINGH DEVELOPMENT, LLC.
7125 ORCHARD LAKE ROAD
BLOOMFIELD HILLS, MICHIGAN 48322

**ENTRANCE AND INTERSECTION
GRADING AND DETAILS**

DATE:	11-27-2019
REVISIONS	
PER CITY	03-24-2020
PER CITY	10-12-2020
PER CITY	01-18-2021

DRAWN BY: SDT
 CHECKED BY: SDT/MY
 SCALE: SA
 0 10 20
 1" = 20 FEET
 JOB NO. 180905
 SHEET NO.

15

SHEET 15 OF 38

\\UMLOR\GROUP PROJECT FOLDERS\SINGH DEVELOPMENT\180905 - SCENIC PINES\SCENIC PINES CD'S\180905-SITE GRADING PLAN.DWG


UTILITY QUANTITIES

SANITARY SEWER

8" PVC SDR 26 SANITARY PIPE	1122 LF
6" PVC SDR 23.5 SANITARY LEAD	1009 LF
4" SDR11 SANITARY FORCEMAIN	84 LF
4" SANITARY MANHOLE	8 EA
DUPLEX PUMPING STATION	1 EA
VALVE VAULT BOX	1 EA

WATER MAIN

8" D.I. CL 54 WATER MAIN	1680 LF
6" D.I. CL54 HYD LEAD	53 LF
1" K" COPPER WATER LEAD	1316 LF
HYDRANT & ASSEMBLY	5 EA
GATE VALVE & WELL	5 EA

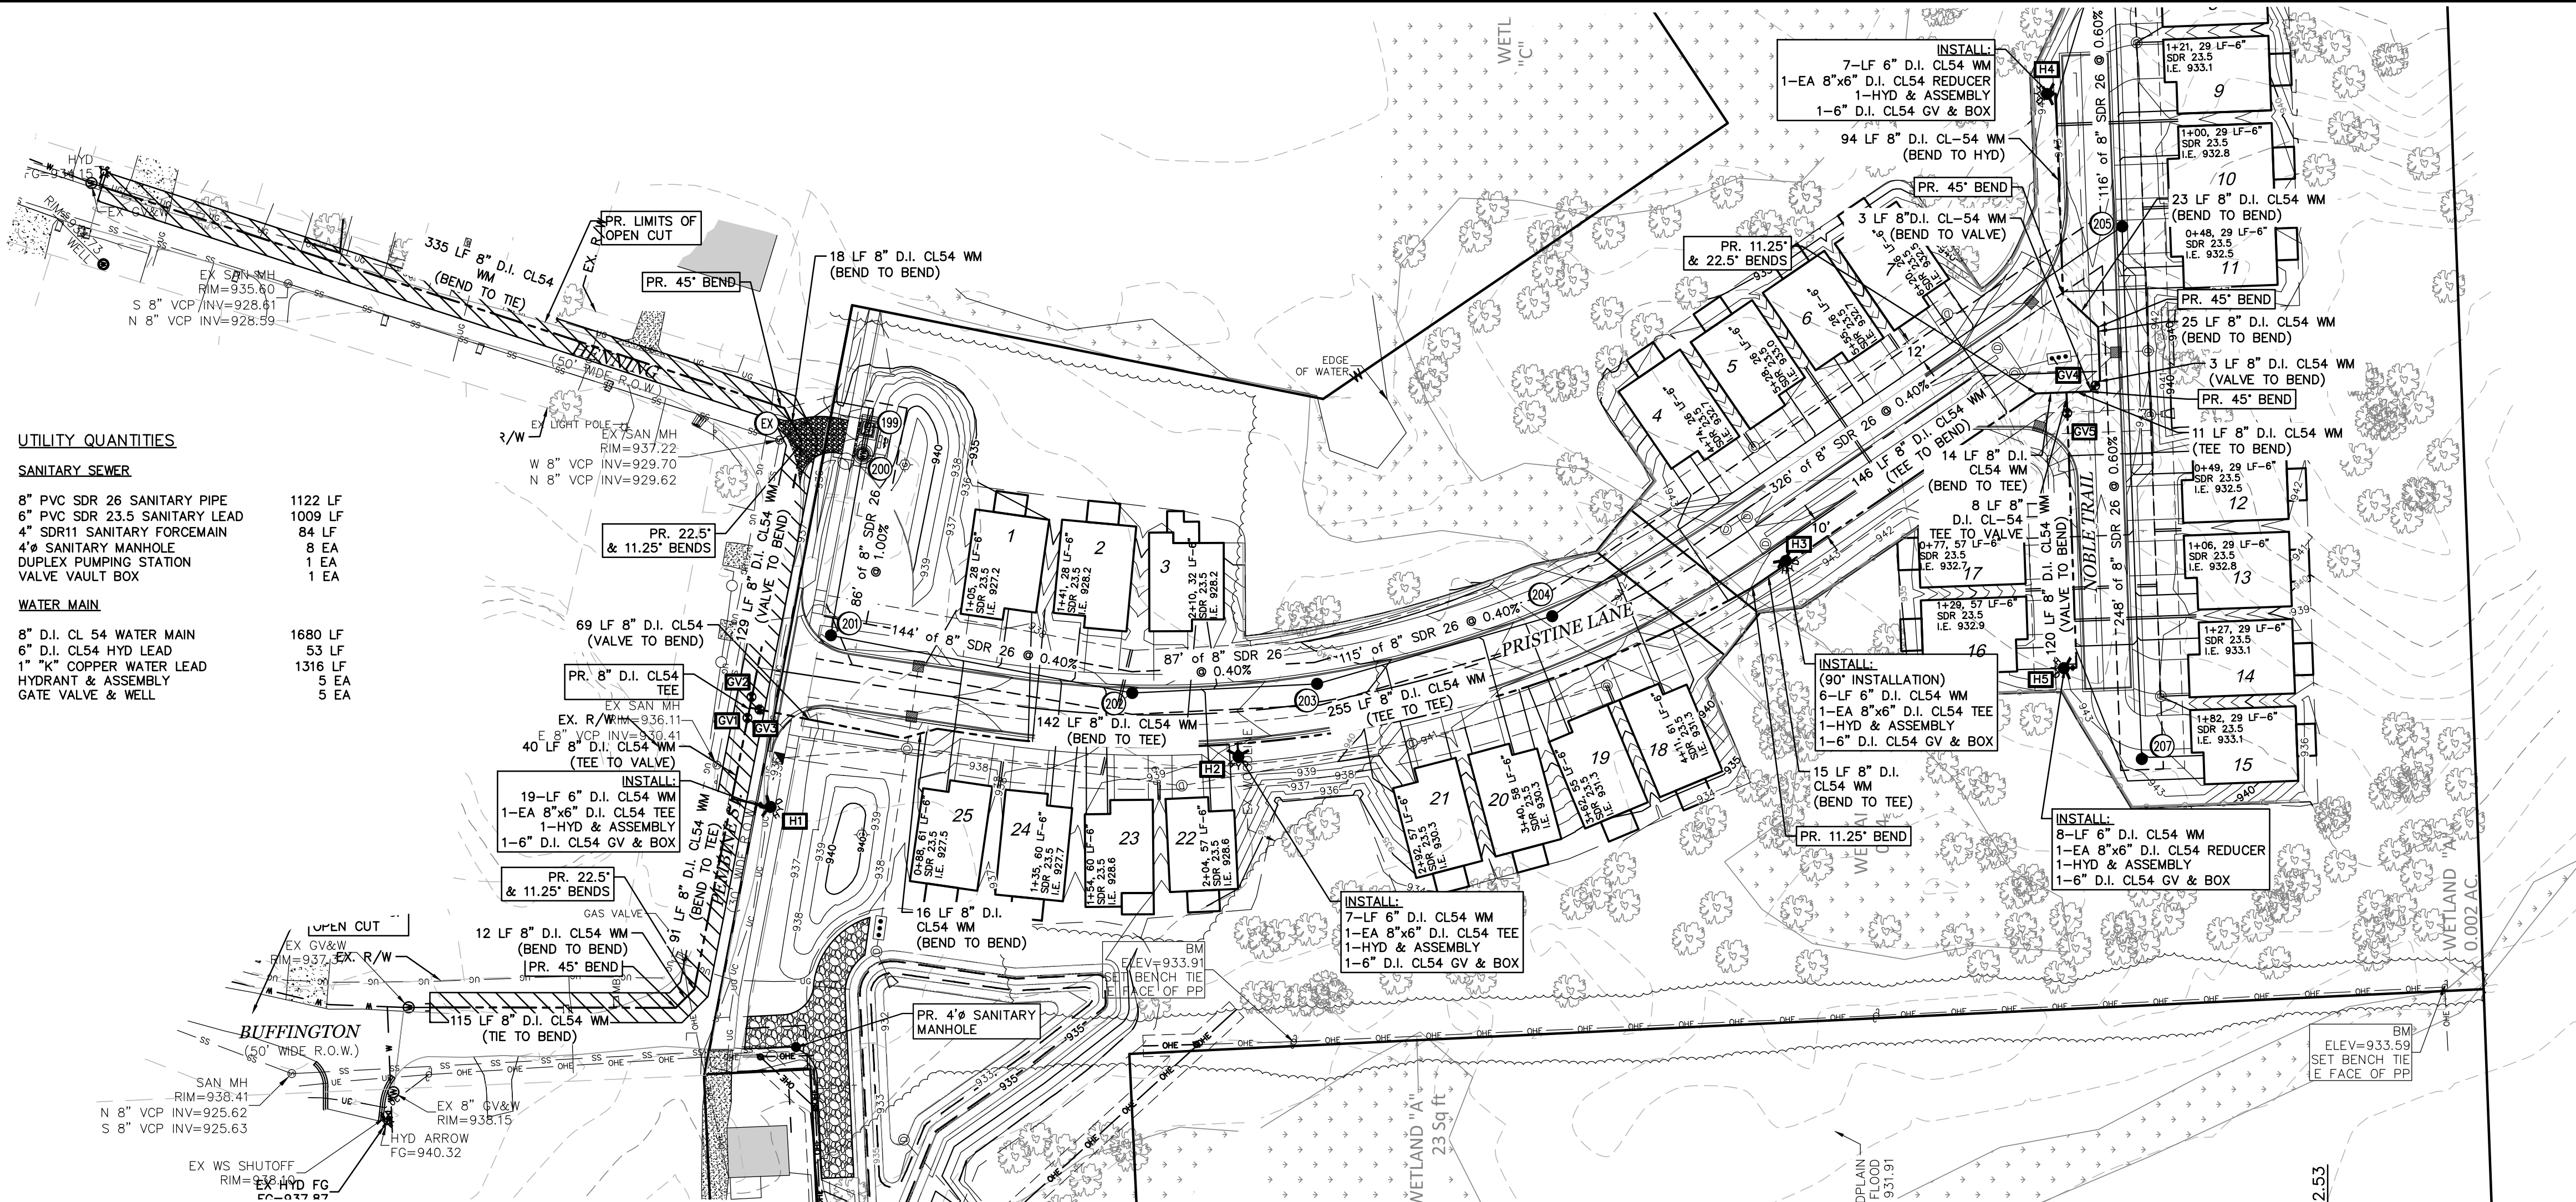

NOTE:
COMPACTED SAND BACKFILL (MDOT SAND CLASS 2) SHALL BE PROVIDED FOR ALL UTILITIES WITHIN THE INFLUENCE OF PAVED AREAS.

SEE SHEET 11 FOR OVERALL EASEMENT PLAN

SEE SHEET 17 FOR SANITARY & WATER PROFILES FOR NOBLE TRAIL

SEE SHEET 18 FOR WATER PROFILES FOR BUFFINGTON, PEMBINE ST & HENNING

SEE SHEET 19 FOR OVERALL STORM SEWER PLAN

SEE SHEETS 20 & 21 FOR STORM SEWER PROFILES

SANITARY BASIS OF DESIGN

Connection to existing 8" PVC sanitary sewer along Henning St.

NUMBER OF UNITS

= 25 UNITS TOTAL

POPULATION

= 2.38 PEOPLE/UNIT X 25
= 59.5 PEOPLE

AVERAGE FLOW

= 59.5 PEOPLE X 100 GAL/CAP/DAY
= 5950 GAL/DAY
= 0.00893 CFS

PEAK FACTOR

= $18 + (\text{SQRT}(P/1000)) / (4 + \text{SQRT}(P/1000))$
= 4

PEAK FLOW

= PEAK FACTOR x AVERAGE FLOW
= 0.036 cfs

(CAPACITY OF A 8" PIPE @ 0.40% IS 0.76 CFS)
THEREFORE PIPE CAPACITY IS SUFFICIENT

SANITARY NOTES:

1. ALL PUBLIC SANITARY SEWERS SHALL BE LOCATED WITHIN A 20' WIDE DEDICATED EASEMENT.
2. ALL SANITARY SEWER MAINS SHALL BE MINIMUM 8" PVC SDR 26 @ 0.40% MIN. SLOPE.
3. ALL SANITARY SEWER LEADS SHALL BE MINIMUM 4" PVC SDR 23.5 @ 2.0% MIN. SLOPE.
4. ALL SANITARY SEWER LEADS SHALL BE A MINIMUM DEPTH OF 5' UNDER THE INFLUENCE OF PAVEMENT.
5. ALL SANITARY SEWER LEADS SHALL BE MINIMUM DEPTH OF 10' BELOW THE FINISHED GRADE OF EACH UNIT TO PROVIDE FOR GRAVITY DISCHARGE FROM BASEMENTS.
6. ALL MATERIALS SHALL CONFORM TO THE CITY OF NOVI STANDARDS AND SPECIFICATIONS.
7. A 27' WIDE ACCESS EASEMENT SHALL BE PROVIDED ALONG ALL PR. ROADWAYS.
8. PROVIDE A TESTING BULKHEAD IMMEDIATELY UPSTREAM OF THE SANITARY CONNECTION POINT.

WATER MAIN NOTES:

1. ALL PUBLIC WATER MAINS AND/OR SERVICES SHALL BE LOCATED WITHIN A 20' WIDE DEDICATED EASEMENT.
2. ALL WATER MAINS SHALL BE 8" DUCTILE IRON CLASS 54.
3. ALL WATER SERVICES SHALL BE 1" K" COPPER OR HDPE DR9 WITH TRACE WIRE. CURB STOPS TO BE PROVIDED 1' BEHIND PR. WALKS TYPICAL.
4. ALL WATER MAINS SHALL BE INSTALLED WITH 5'-6" MINIMUM COVER.
5. 18" MINIMUM SEPARATION SHALL BE PROVIDED BETWEEN WATER MAINS AND/OR SERVICE LEADS AND ALL OTHER UTILITIES.
6. ALL MATERIALS SHALL CONFORM TO THE CITY OF NOVI STANDARDS AND SPECIFICATIONS.
7. A 27' WIDE ACCESS EASEMENT SHALL BE PROVIDED ALONG ALL PR. ROADWAYS.
8. ALL HYDRANTS SHALL BE PLACED A MINIMUM OF 7 FEET BEHIND BACK OF CURB.
9. ALL HYDRANTS MUST BE INSTALLED AND OPERATIONAL PRIOR TO BEGINNING BUILDING CONSTRUCTION.


NOTE:

ALL PROPOSED 4" SCH 40 PVC STORM LEADS SHALL BE SLOPED A MINIMUM OF 1%

PR. UTILITY LEGEND	
SYMBOL	DESCRIPTION
	PR. STORM SEWER
	PR. SANITARY SEWER
	PR. WATER MAIN
	PR. CONTOURS
	PR. LIMITS DISTURBANCE
	PR. WATER VALVE
	PR. HYDRANT
	PR. FLOW DIRECTION
	PR. SANITARY STRUCTURE NUMBER
	PR. STORM STRUCTURE NUMBER
	PR. WATER VALVE/HYDRANT NUMBER



PRISTINE LANE
1"=50' HORIZ.
1"=5' VERT.

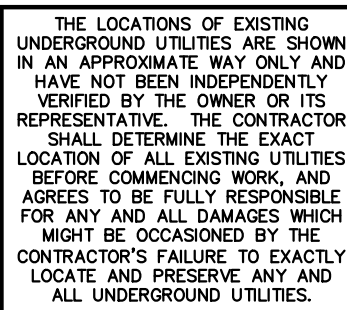

(IN FEET)
1 inch = 50 ft.

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The UMLOR Group
LAND DEVELOPMENT SERVICES

SECTION 3
TOWN 1 NORTH, RANGE 8 EAST
CITY OF NOVI
OAKLAND COUNTY, MICHIGAN

SCENIC PINES
SINGH DEVELOPMENT, LLC.
7125 ORCHARD LAKE ROAD
BLOOMFIELD HILLS, MICHIGAN 48322
CLIENT:
PRISTINE LANE - ROAD, SANITARY, & WATERMAIN PLAN & PROFILE

DATE: 11-27-2019

REVISIONS

PER CITY 03-24-2020

PER CITY 10-12-2020

PER CITY 01-18-2021

PER CITY 10-06-2021

DR BY: SDT
CK BY: SDT/MY
P.M. SA
SCALE 0 25 50
1" = 50 FEET
JOB NO. 180905
SHEET NO. 16
SHEET 16 OF 38

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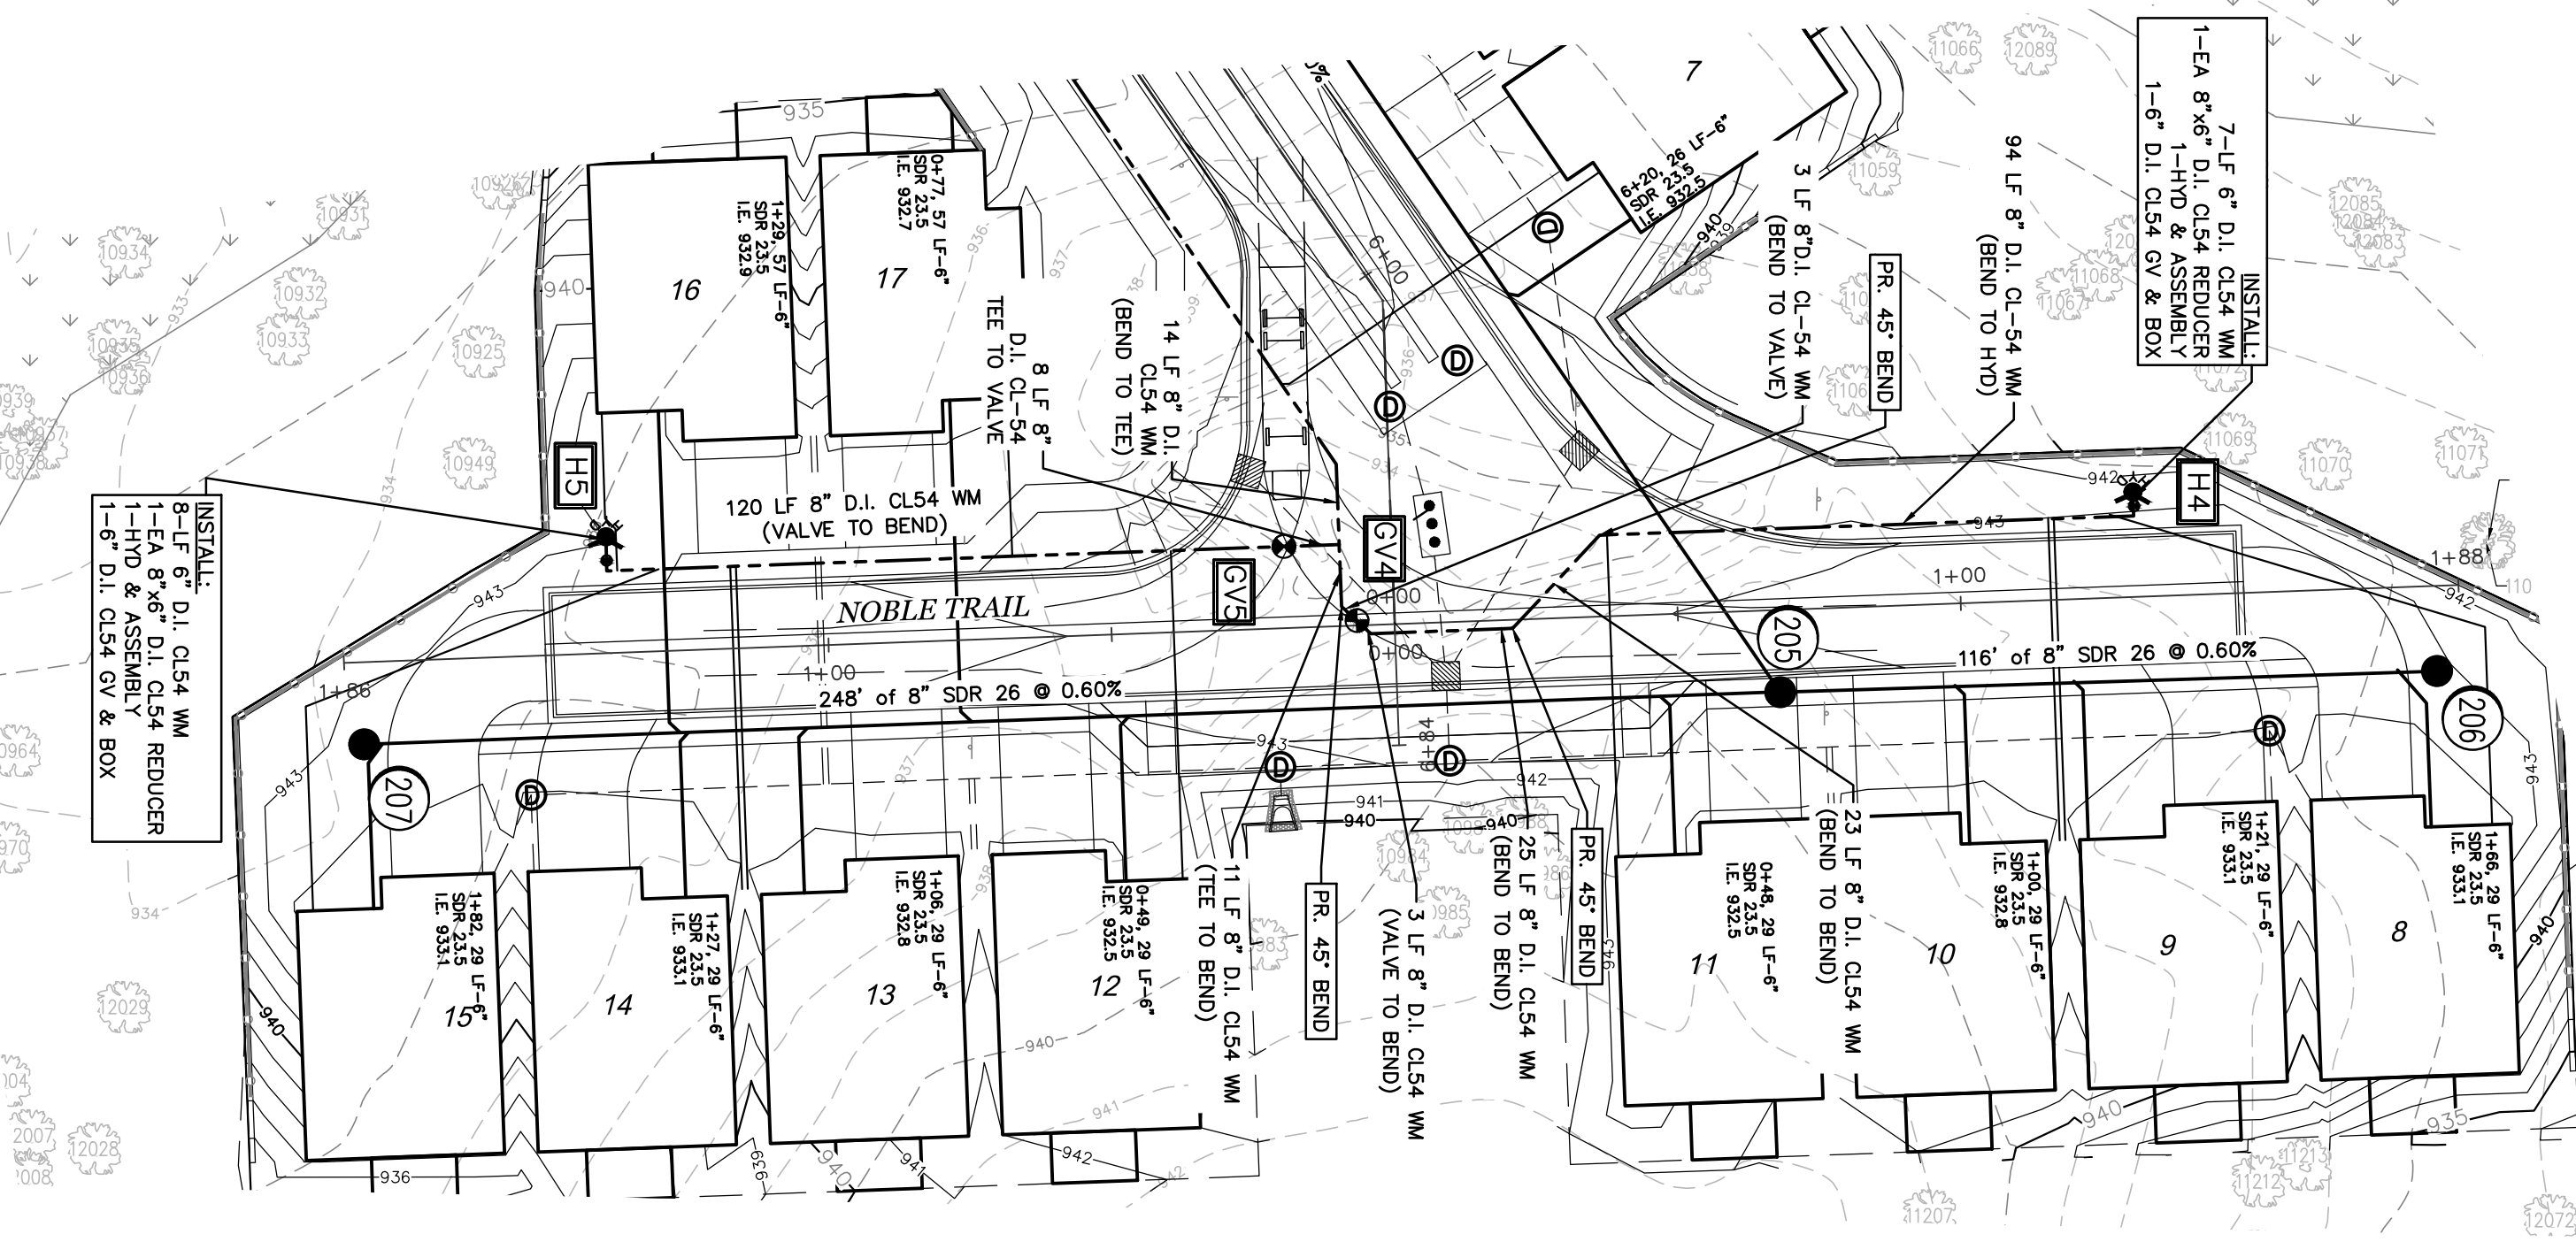
UTILITY QUANTITIES

SANITARY SEWER

8" PVC SDR 26 SANITARY PIPE	1122 LF
6" PVC SDR 23.5 SANITARY LEAD	1009 LF
4" SDR11 SANITARY FORCEMAIN	84 LF
4" SANITARY MANHOLE	8 EA
DUPLEX PUMPING STATION	1 EA
VALVE VAULT BOX	1 EA

WATER MAIN

8" D.I. CL 54 WATER MAIN	1680 LF
6" D.I. CL54 HYD LEAD	93 LF
1" "K" COPPER WATER LEAD	1316 LF
HYDRANT & ASSEMBLY	5 EA
GATE VALVE & WELL	5 EA



NOTE:
COMPACTED SAND BACKFILL (MDOT SAND CLASS 2) SHALL BE PROVIDED FOR ALL UTILITIES WITHIN THE INFLUENCE OF PAVED AREAS.

SANITARY NOTES:

1. ALL PUBLIC SANITARY SEWERS SHALL BE LOCATED WITHIN A 20' WIDE DEDICATED EASEMENT.
2. ALL SANITARY SEWER MAINS SHALL BE MINIMUM 8" PVC SDR 26 @ 0.40% MIN. SLOPE.
3. ALL SANITARY SEWER LEADS SHALL BE MINIMUM 6" PVC SDR 23.5 @ 2.0% MIN. SLOPE.
4. ALL SANITARY SEWER LEADS SHALL BE A MINIMUM DEPTH OF 5' UNDER THE INFLUENCE OF PAVEMENT.
5. ALL SANITARY SEWER LEADS SHALL BE MINIMUM DEPTH OF 10' BELOW THE FINISHED GRADE OF EACH UNIT TO PROVIDE FOR GRAVITY DISCHARGE FROM BASEMENTS.
6. ALL MATERIALS SHALL CONFORM TO THE CITY OF NOVI STANDARDS AND SPECIFICATIONS.
7. A 28' WIDE ACCESS EASEMENT SHALL BE PROVIDED ALONG ALL PR. ROADWAYS.
8. PROVIDE A TESTING BULKHEAD IMMEDIATELY UPSTREAM OF THE SANITARY CONNECTION POINT.

WATER MAIN NOTES:

1. ALL PUBLIC WATER MAINS AND/OR SERVICES OUTSIDE OF EXISTING RIGHT OF WAY SHALL BE LOCATED WITHIN A 20' WIDE DEDICATED EASEMENT.
2. ALL WATER MAINS SHALL BE 8" DUCTILE IRON CLASS 54.
3. ALL WATER SERVICES SHALL BE 1" "K" COPPER OR HDPE DR9 WITH TRACE WIRE. CURB STOPS TO BE PROVIDED 1' BEHIND PR. WALKS TYPICAL.
4. ALL WATER MAINS SHALL BE INSTALLED WITH 5'-6" MINIMUM COVER.
5. 18" MINIMUM SEPARATION SHALL BE PROVIDED BETWEEN WATER MAINS AND/OR SERVICE LEADS AND ALL OTHER UTILITIES.
6. ALL MATERIALS SHALL CONFORM TO THE CITY OF NOVI STANDARDS AND SPECIFICATIONS.
7. A 28' WIDE ACCESS EASEMENT SHALL BE PROVIDED ALONG ALL PR. ROADWAYS.
8. ALL HYDRANTS SHALL BE PLACED A MINIMUM OF 7 FEET BEHIND BACK OF CURB.
9. ALL HYDRANTS MUST BE INSTALLED AND OPERATIONAL PRIOR TO BEGINNING BUILDING CONSTRUCTION.

NOTE:
ALL PROPOSED 4" SCH 40 PVC STORM LEADS SHALL BE SLOPED A MINIMUM OF 1%


SEE SHEET 11 FOR OVERALL EASEMENT PLAN

SEE SHEET 16 FOR SANITARY & WATER PROFILES FOR PRISTINE LANE

SEE SHEET 18 FOR WATER PROFILES FOR BUFFINGTON, PEMBINE ST & HENNING


SEE SHEET 19 FOR OVERALL STORM SEWER PLAN

SEE SHEETS 20 & 21 FOR STORM SEWER PROFILES

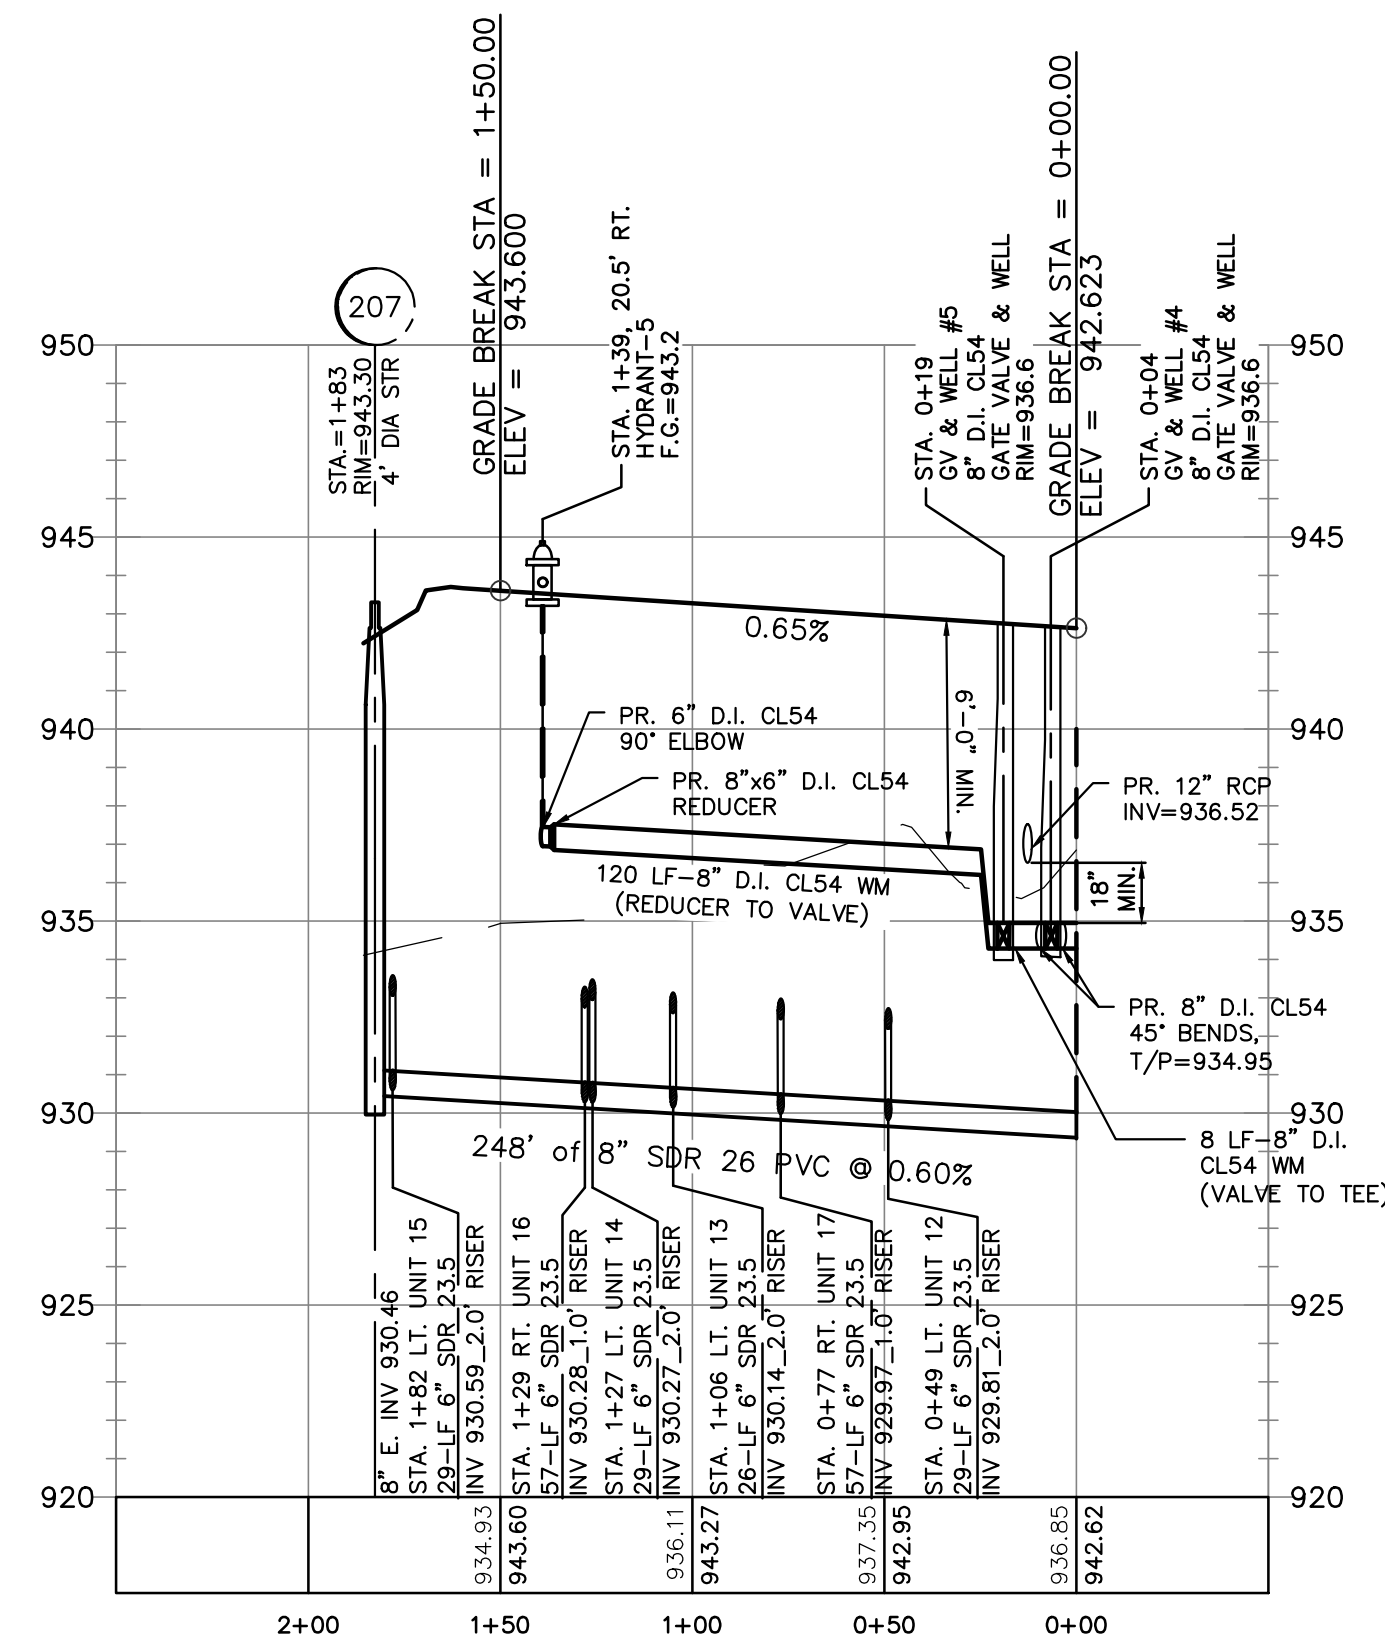

NOBLES TRAIL LEFT

1"=50' HORIZ.
1"=5' VERT.

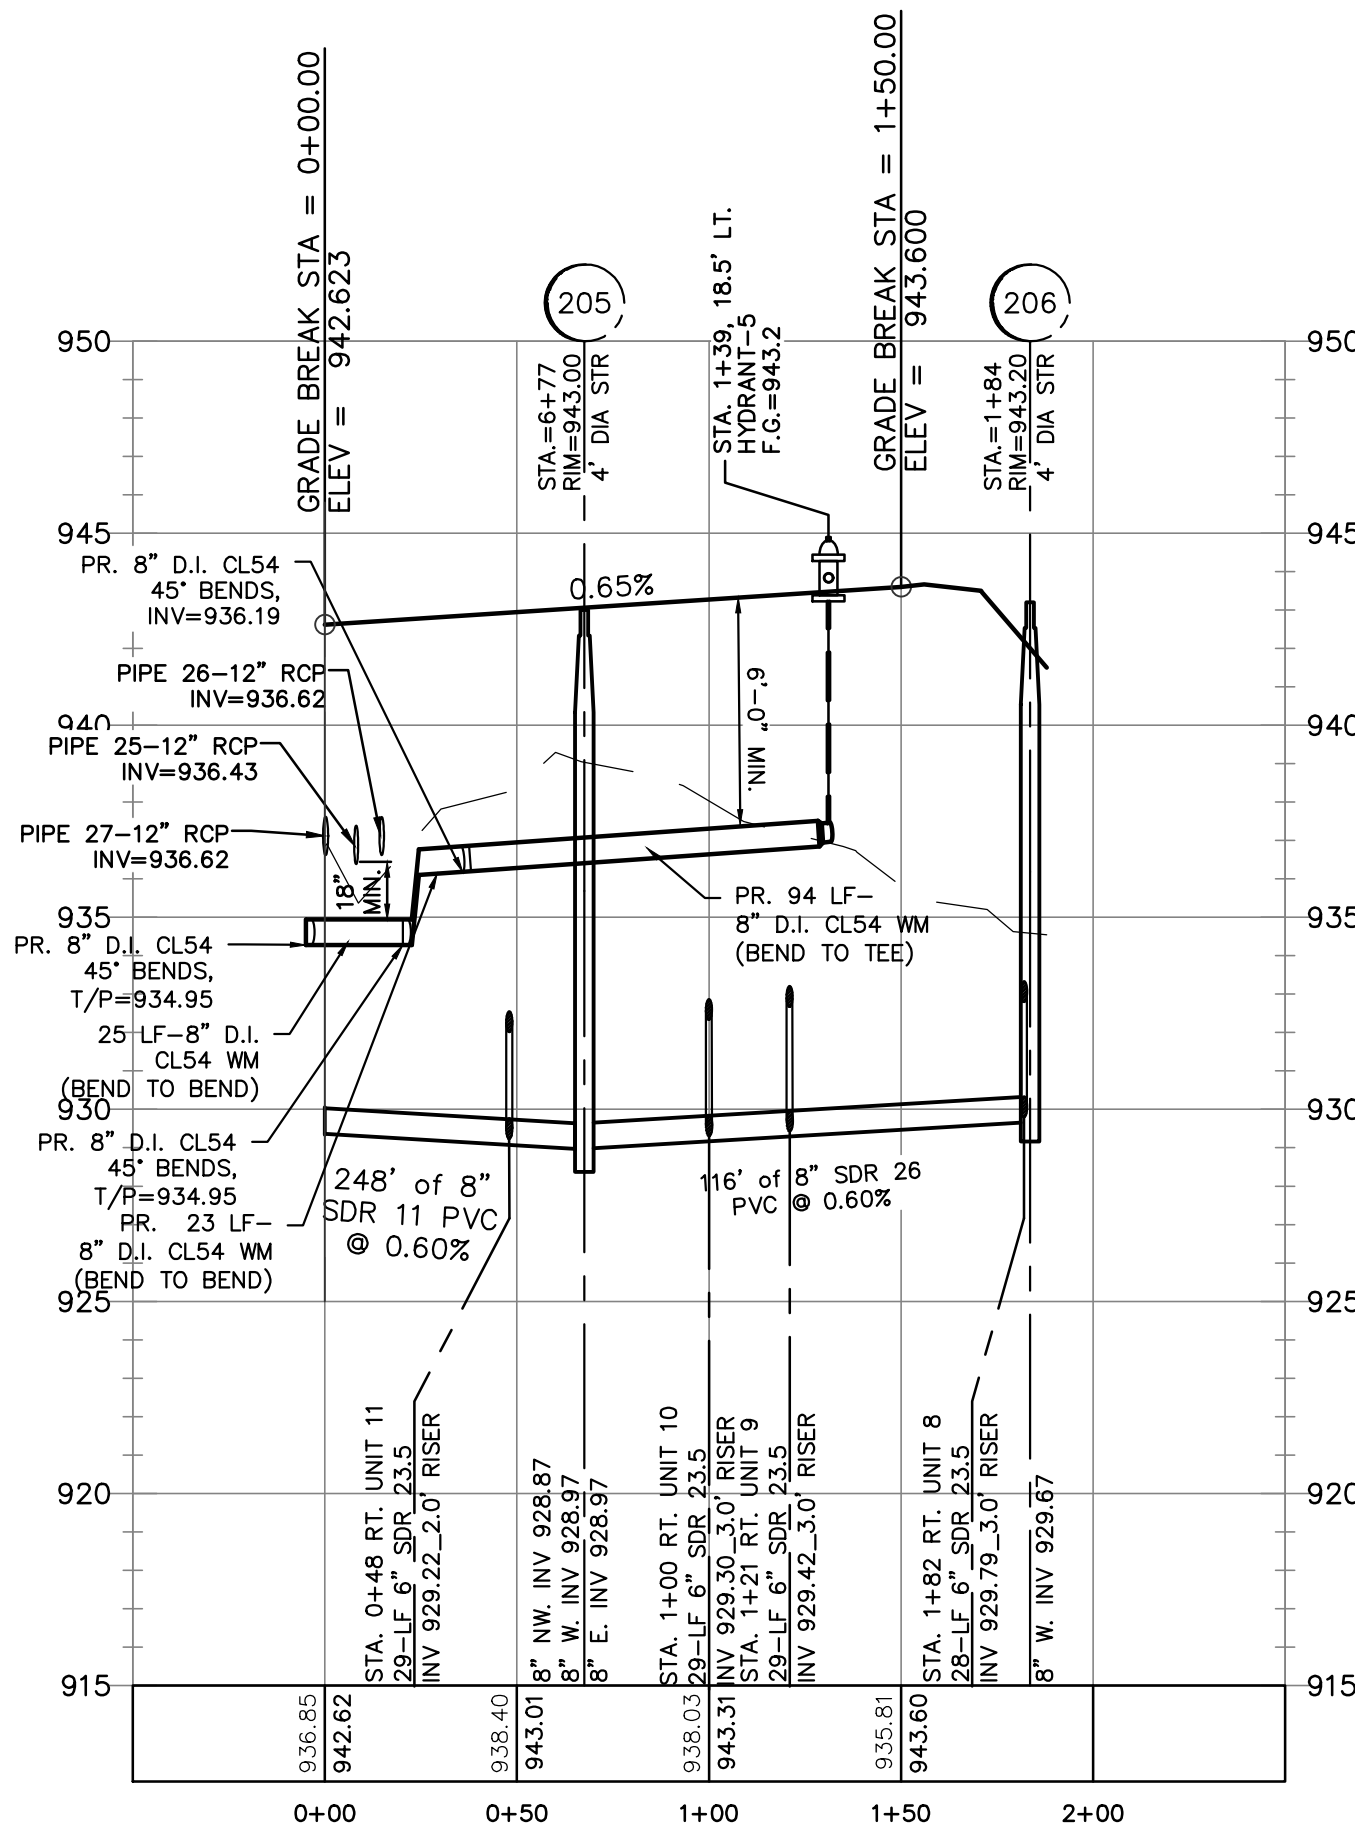

NOBLES TRAIL RIGHT

1"=50' HORIZ.
1"=5' VERT.

PR. UTILITY LEGEND	
SYMBOL	DESCRIPTION
---	PR. STORM SEWER
---	PR. SANITARY SEWER
---	PR. WATER MAIN
---	PR. CONTOURS
---	PR. LIMITS DISTURBANCE
---	PR. WATER VALVE
---	PR. HYDRANT
---	PR. FLOW DIRECTION
200	PR. SANITARY STRUCTURE NUMBER
100	PR. STORM STRUCTURE NUMBER
GV1	PR. WATER VALVE/HYDRANT NUMBER



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SCENIC PINES	SECTION 3
	TOWN 1 NORTH, RANGE 8 EAST
CLIENT: SINGH DEVELOPMENT, LLC. 7125 ORCHARD LAKE ROAD BLOOMFIELD HILLS, MICHIGAN 48322	CITY OF NOVI
	OAKLAND COUNTY, MICHIGAN
NOBLES TRAIL - ROAD, SANITARY, & WATERMAIN PLAN & PROFILE	

DATE:	11-27-2019
REVISIONS	
PER CITY 03-24-2020	
PER CITY 01-18-2021	


DR BY:	SDT
CK BY:	SDT/MY
P.M.	SA
SCALE	0
AS NOTED	
JOB NO.	180905
SHEET NO.	17
SHEET 17 OF 38	

UTILITY QUANTITIES

WATER MAIN

8" D.I. CL 54 WATER MAIN	1680 LF
6" D.I. CL54 HYD LEAD	53 LF
1" "K" COPPER WATER LEAD	1316 LF
HYDRANT & ASSEMBLY	5 EA
GATE VALVE & WELL	5 EA

NOTE:
THE FULL WIDTH OF BUFFINGTON, HENNING AND PEMBINE PAVEMENTS ADJACENT TO PROPOSED WATER MAIN AND SANITARY SEWER CONSTRUCTION SHALL BE REMOVED AND RESTORED TO EQUAL OR BETTER THAN PRECONSTRUCTION CONDITIONS.

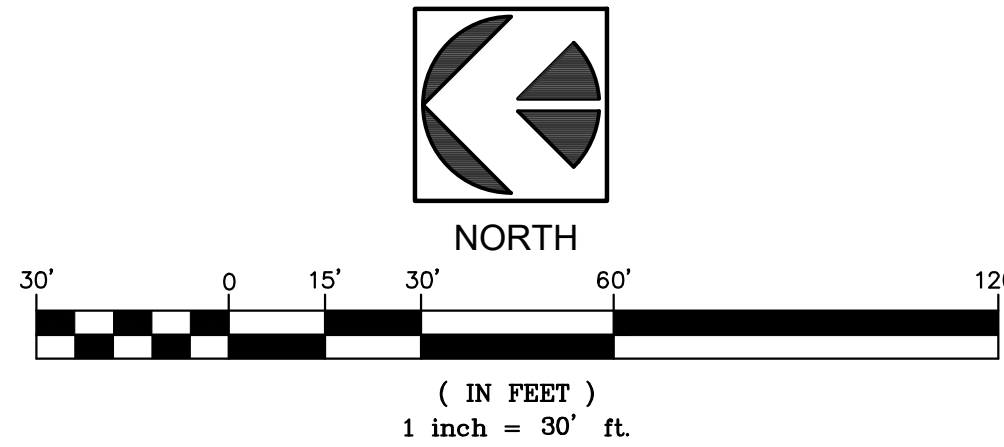


NOTE:
COMPACTED SAND BACKFILL (MDOT SAND CLASS 2) SHALL BE PROVIDED FOR ALL UTILITIES WITHIN THE INFLUENCE OF PAVED AREAS.

WATER MAIN NOTES:

1. ALL PUBLIC WATER MAINS AND/OR SERVICES SHALL BE LOCATED WITHIN A 20' WIDE DEDICATED EASEMENT.
2. ALL WATER MAINS SHALL BE 8" DUCTILE IRON CLASS 54.
3. ALL WATER SERVICES SHALL BE 1" "K" COPPER OR HDPE DR9 WITH TRACE WIRE. CURB STOPS TO BE PROVIDED 1' BEHIND PR. WALKS TYPICAL.
4. ALL WATER MAINS SHALL BE INSTALLED WITH 5'-6" MINIMUM COVER.
5. 18" MINIMUM SEPARATION SHALL BE PROVIDED BETWEEN WATER MAINS AND/OR SERVICE LEADS AND ALL OTHER UTILITIES.
6. ALL MATERIALS SHALL CONFORM TO THE CITY OF NOVI STANDARDS AND SPECIFICATIONS.
7. A 28' WIDE ACCESS EASEMENT SHALL BE PROVIDED ALONG ALL PR. ROADWAYS.
8. ALL HYDRANTS SHALL BE PLACED A MINIMUM OF 7 FEET BEHIND BACK OF CURB.
9. ALL HYDRANTS MUST BE INSTALLED AND OPERATIONAL PRIOR TO BEGINNING BUILDING CONSTRUCTION.

SEE SHEET 11 FOR OVERALL EASEMENT PLAN
SEE SHEET 16 FOR SANITARY & WATER PROFILES FOR PRISTINE LANE
SEE SHEET 17 FOR SANITARY & WATER PROFILES FOR NOBLE TRAIL
SEE SHEET 19 FOR OVERALL STORM SEWER PLAN
SEE SHEETS 20 & 21 FOR STORM SEWER PROFILES

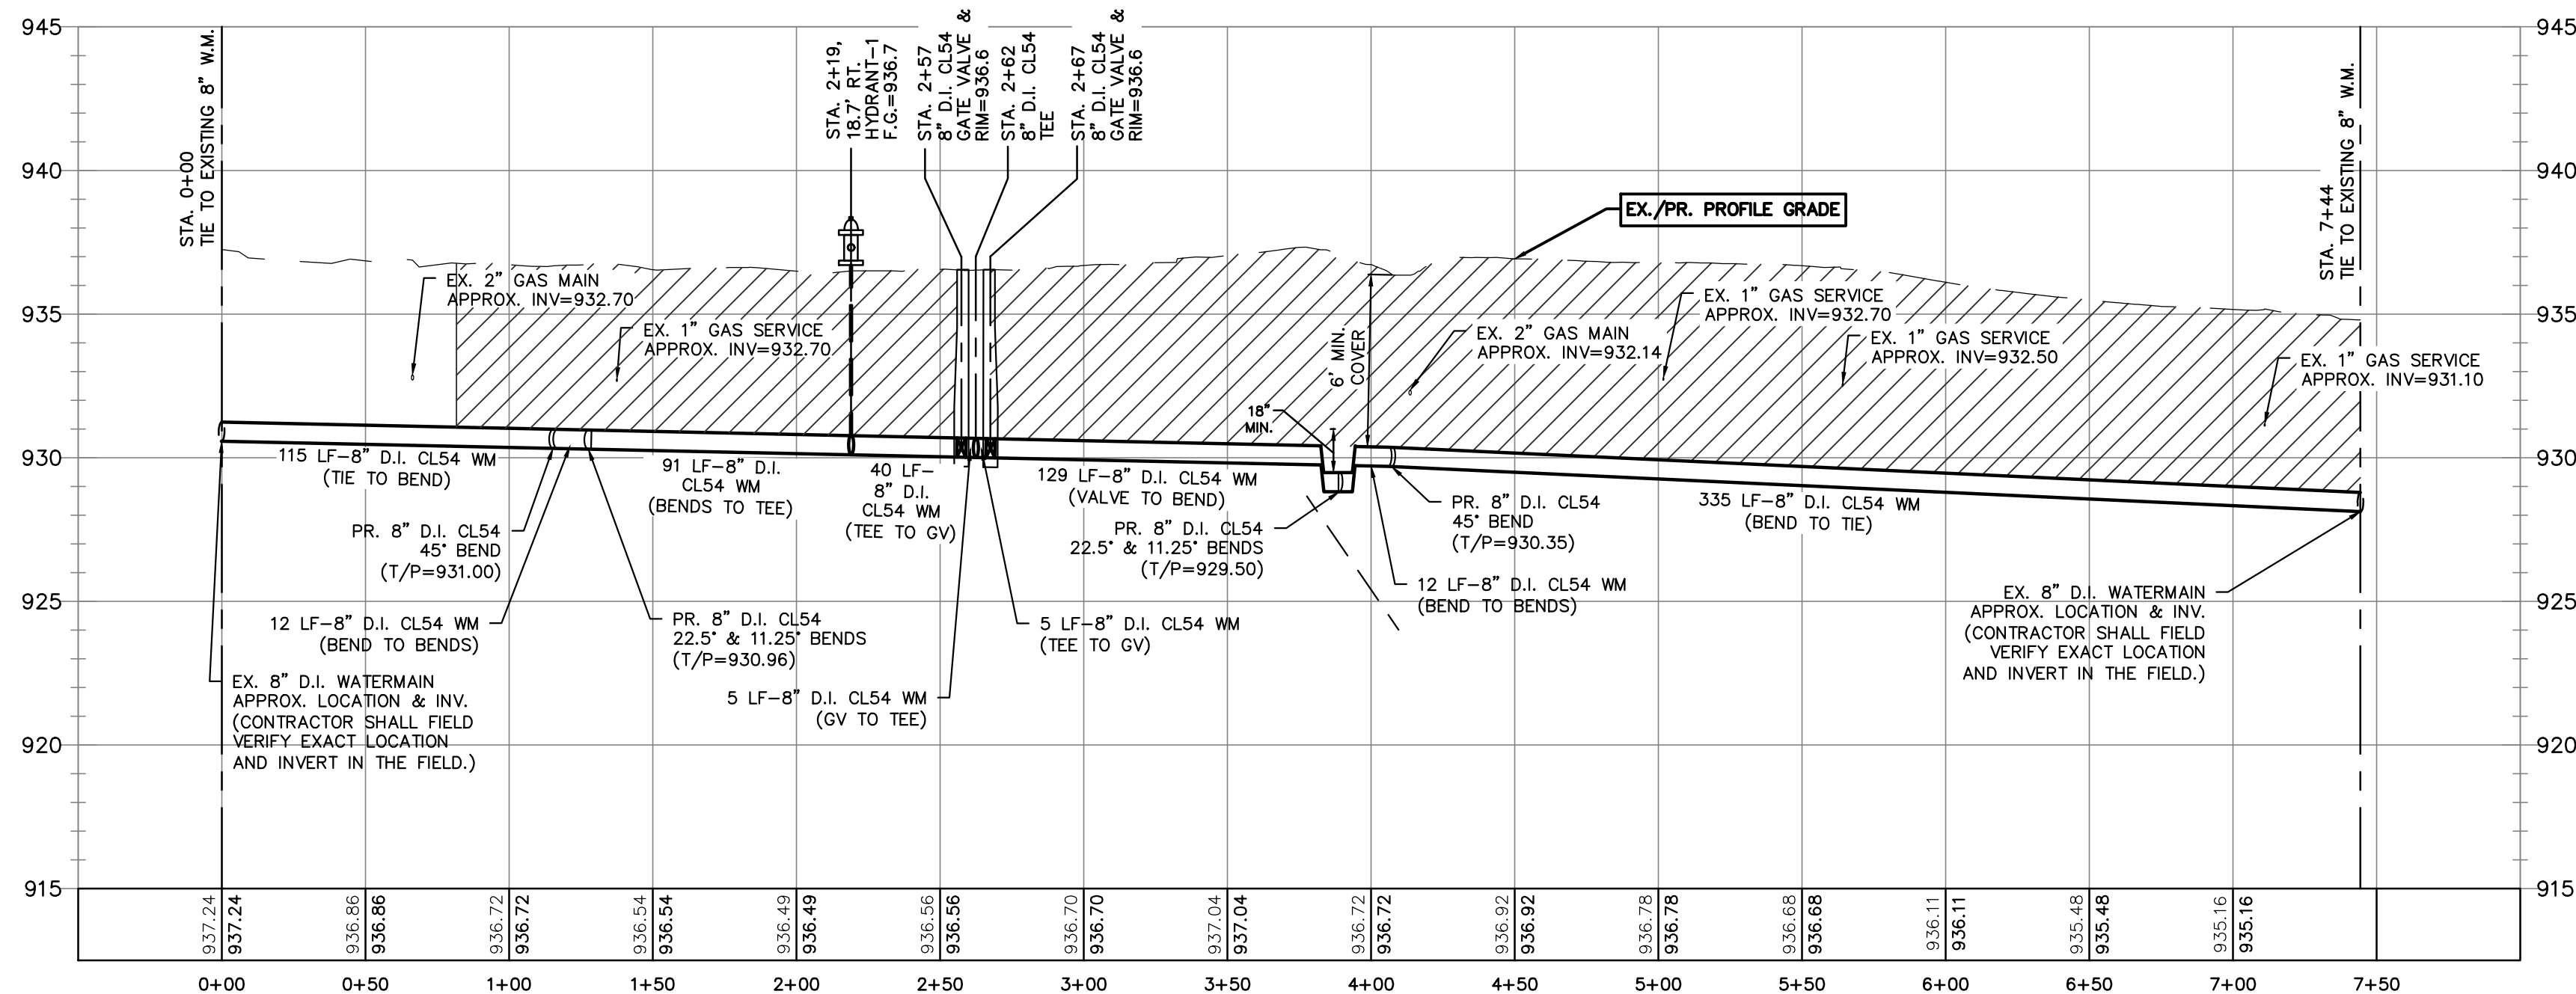

PROPOSED WATER MAIN
1"=50' HORIZ.
1"=5' VERT.

PR. UTILITY LEGEND	
SYMBOL	DESCRIPTION
	PR. STORM SEWER
	PR. SANITARY SEWER
	PR. WATER MAIN
	PR. CONTOURS
	PR. LIMITS DISTURBANCE
	PR. WATER VALVE
	PR. HYDRANT
	PR. FLOW DIRECTION
	PR. SANITARY STRUCTURE NUMBER
	PR. STORM STRUCTURE NUMBER
	PR. WATER VALVE/HYDRANT NUMBER



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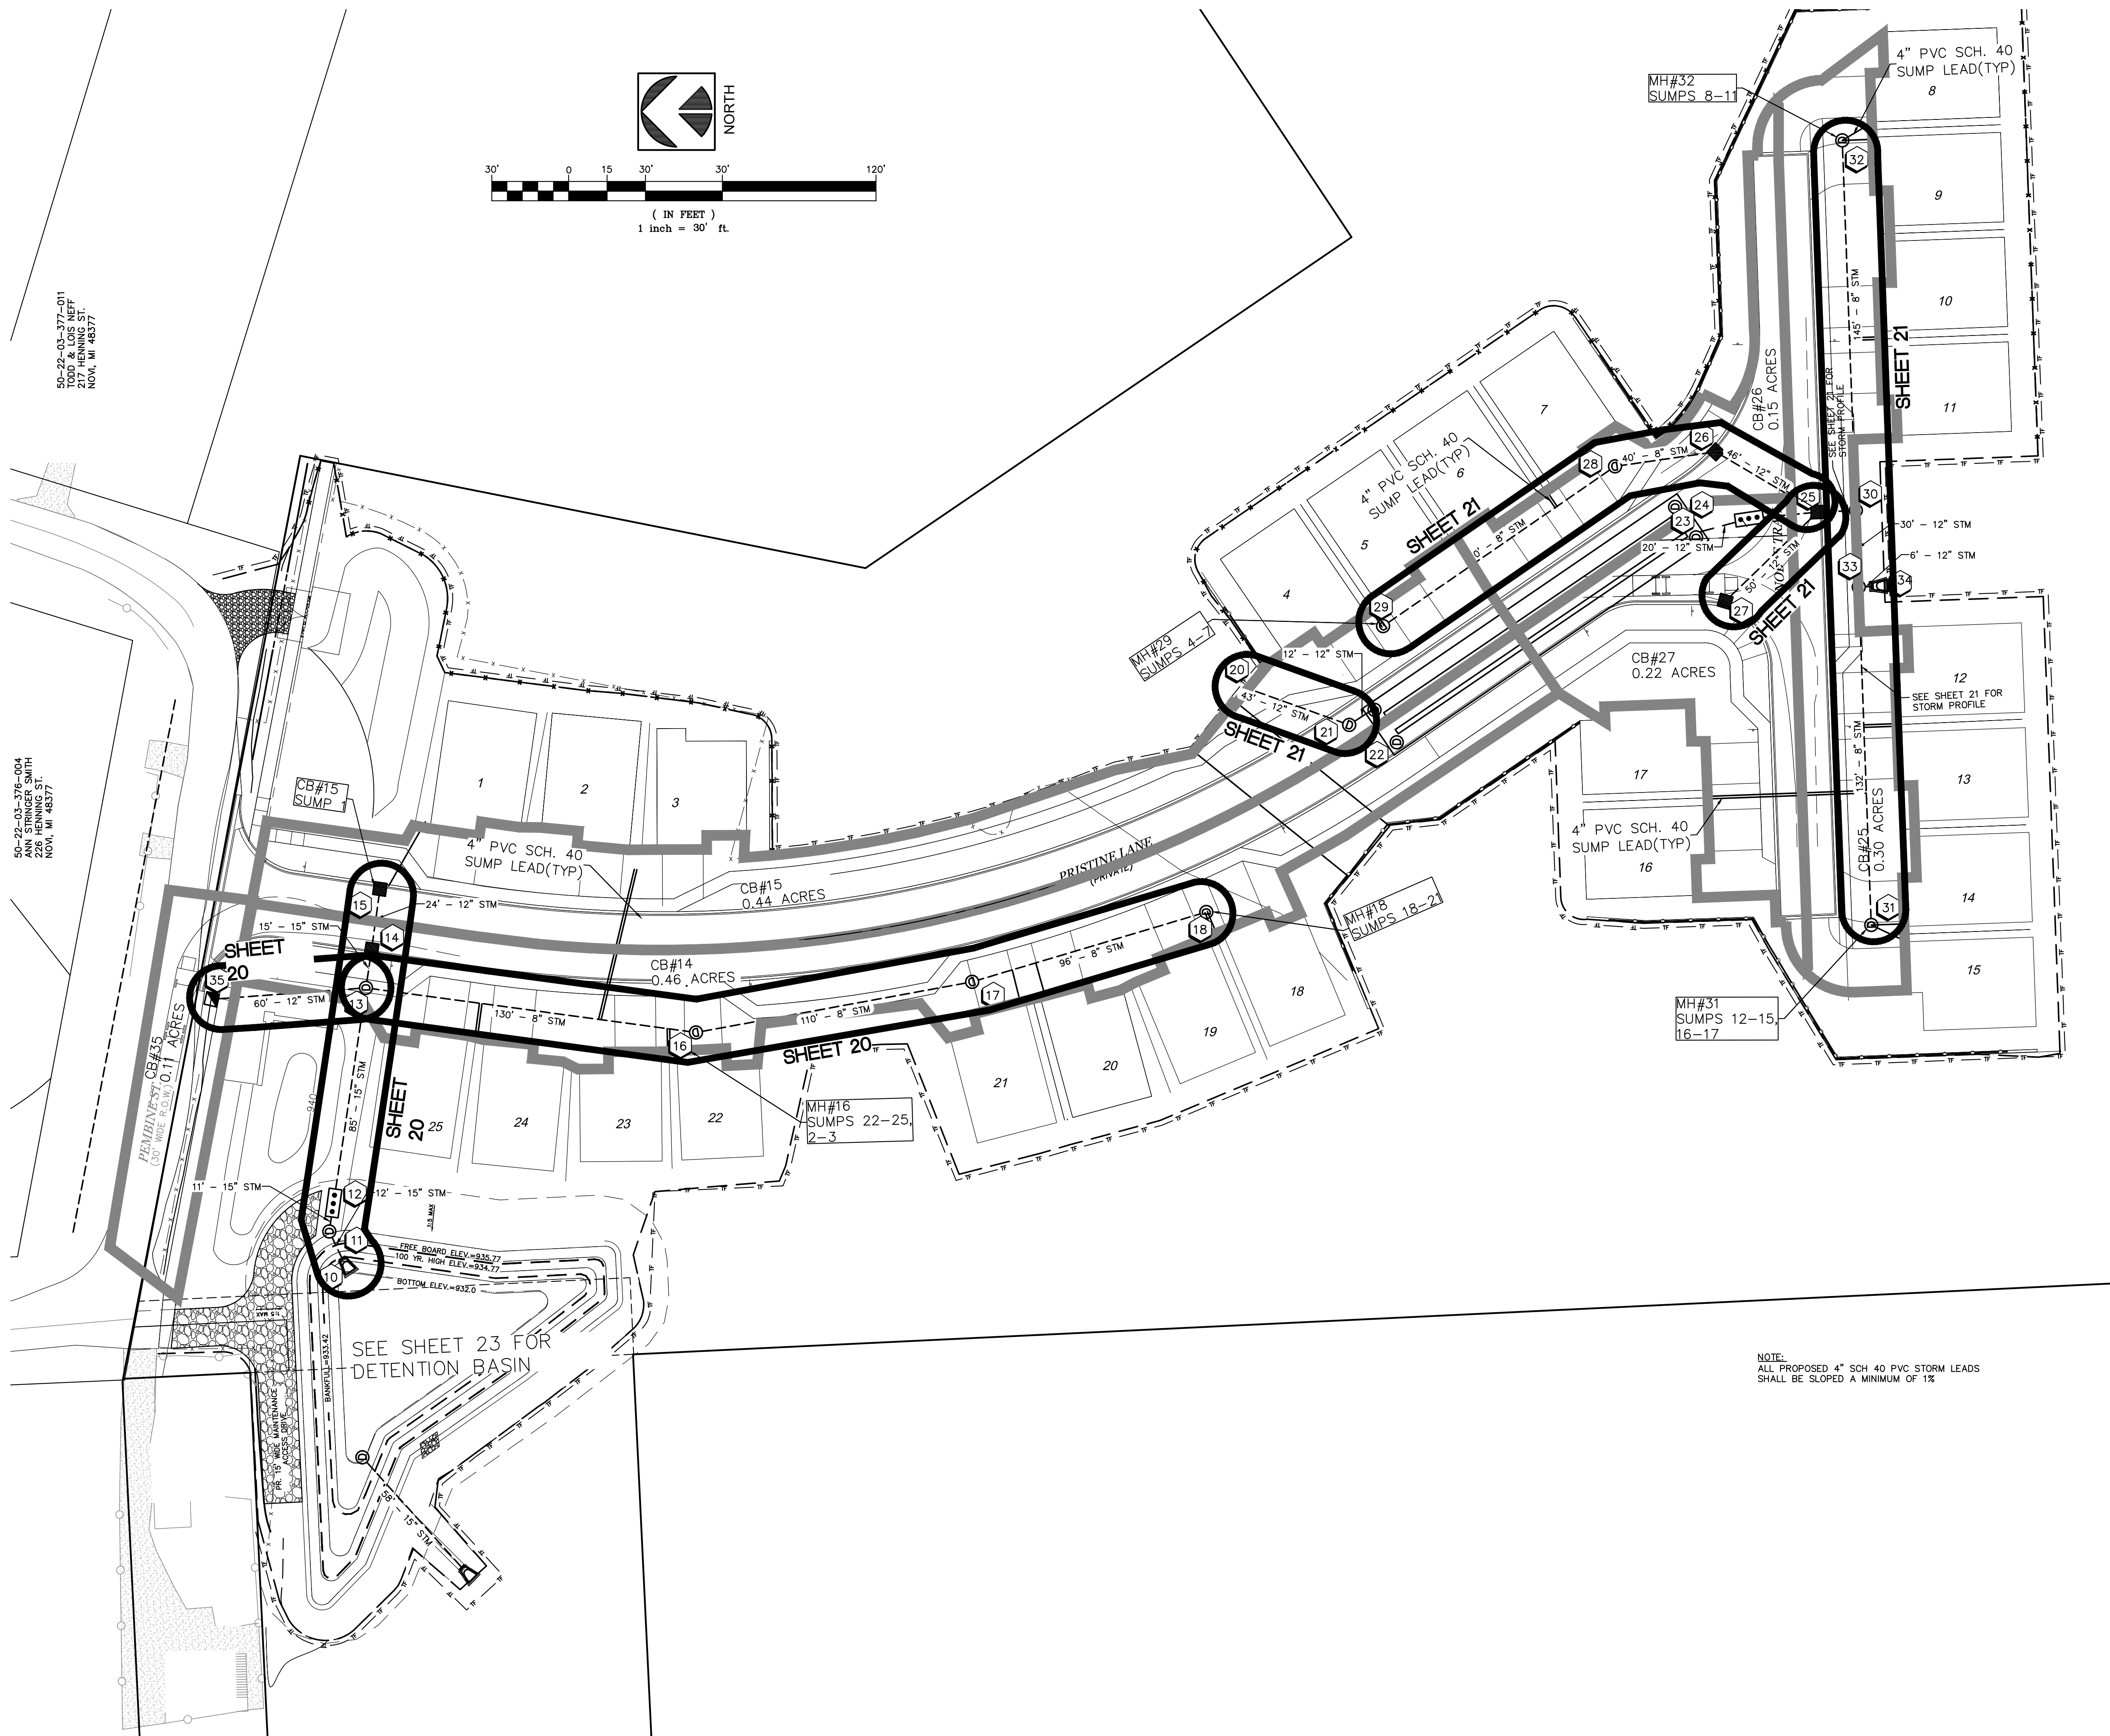
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The UMLOR Group

LAND DEVELOPMENT SERVICES

SECTION 3		SCENIC PINES	CLIENT: SINGH DEVELOPMENT, LLC. 7125 ORCHARD LAKE ROAD BLOOMFIELD HILLS, MICHIGAN 48322	DATE: 11-27-2019	TOWN 1 NORTH, RANGE 8 EAST
OAKLAND COUNTY, MICHIGAN		BUFFINGTON-PEMBINE-HENNING ST. WATERMAIN PLAN & PROFILE	REVISIONS PER CITY 03-24-2020 PER CITY 01-18-2021	DR BY: SDT CK BY: SDT/JMY P.M. SA SCALE 0 25 50 1" = 50 FEET JOB NO. 180905 SHEET NO. 18 SHEET 18 OF 38	CITY OF NOVI



NOTE:
ALL PROPOSED 4" SCH 40 PVC STORM LEADS
SHALL BE SLOPED A MINIMUM OF 1%



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LAND DEVELOPMENT SERVICES

SECTION 3	TOWN 1 NORTH, RANGE 8 EAST
CITY OF NOVI	OAKLAND COUNTY, MICHIGAN

SCENIC PINES

SINGH DEVELOPMENT, LLC.
7125 ORCHARD LAKE ROAD
BLOOMFIELD HILLS, MICHIGAN 48322

OVERALL STORM SEWER PLAN

DATE: 11-27-2019

REVISIONS


PER CITY 03-24-2020

PER CITY 01-18-2021


OR BY: SDT
CK BY: SDT/MY
P.M. SA

SCALE 0 15 30
1" = 30 FEET


JOB NO. 180905
SHEET NO. 19
SHEET 19 OF 38

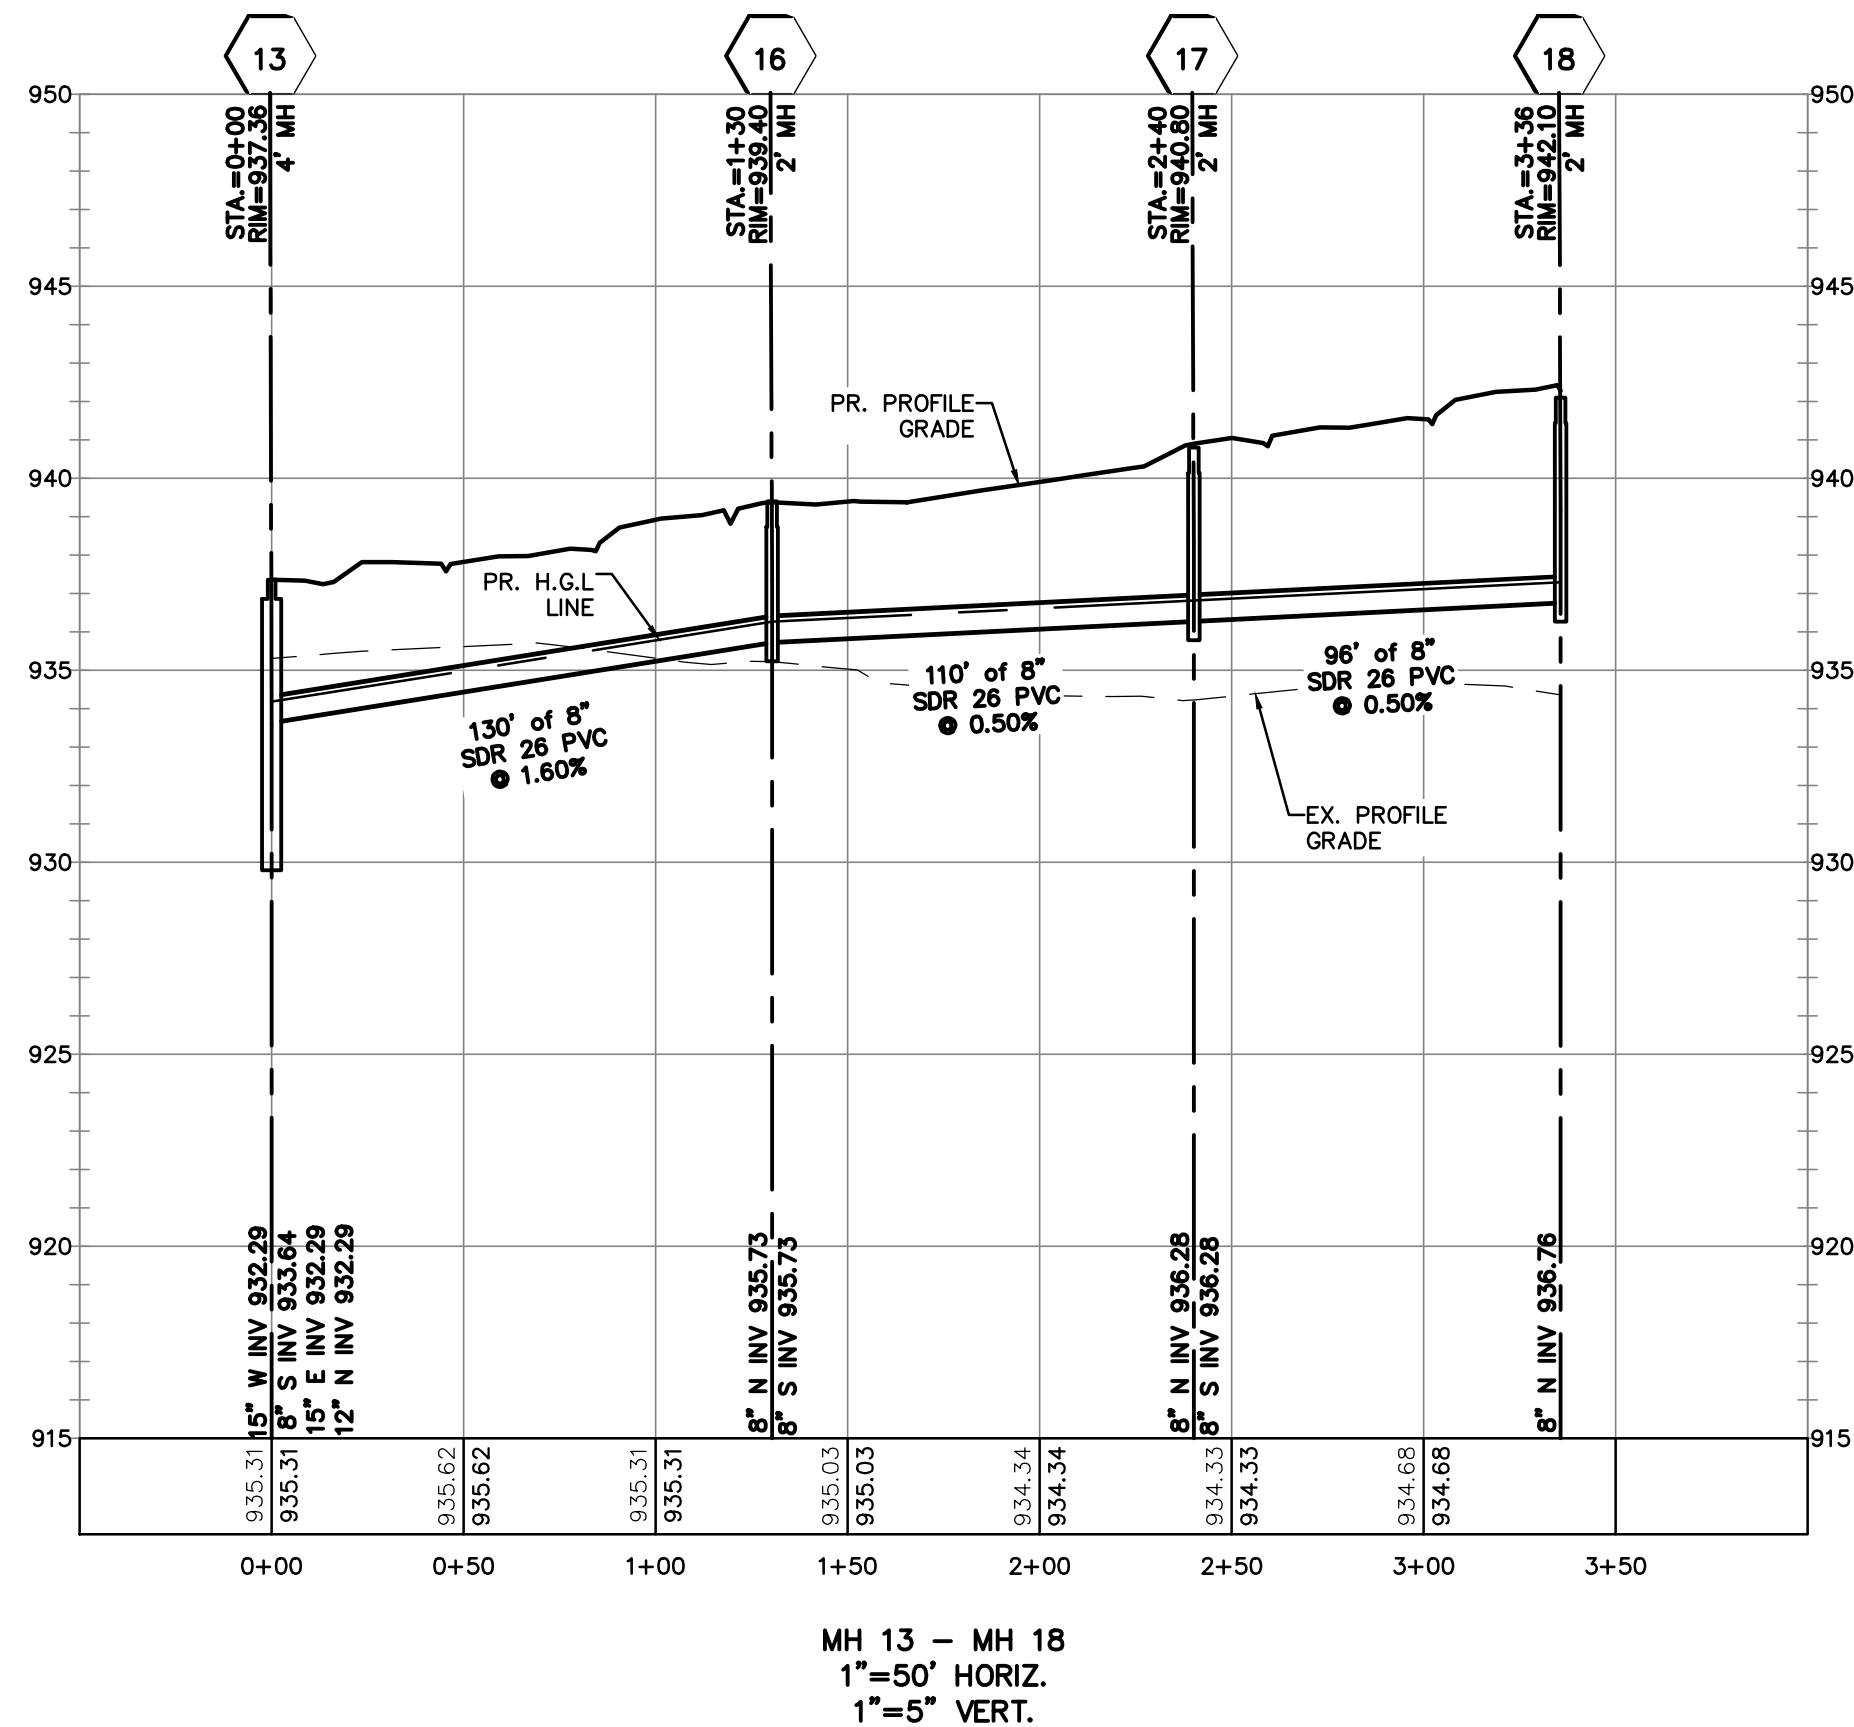


MH 13 - MH 18
1"=50' HORIZ.
1"=5' VERT.

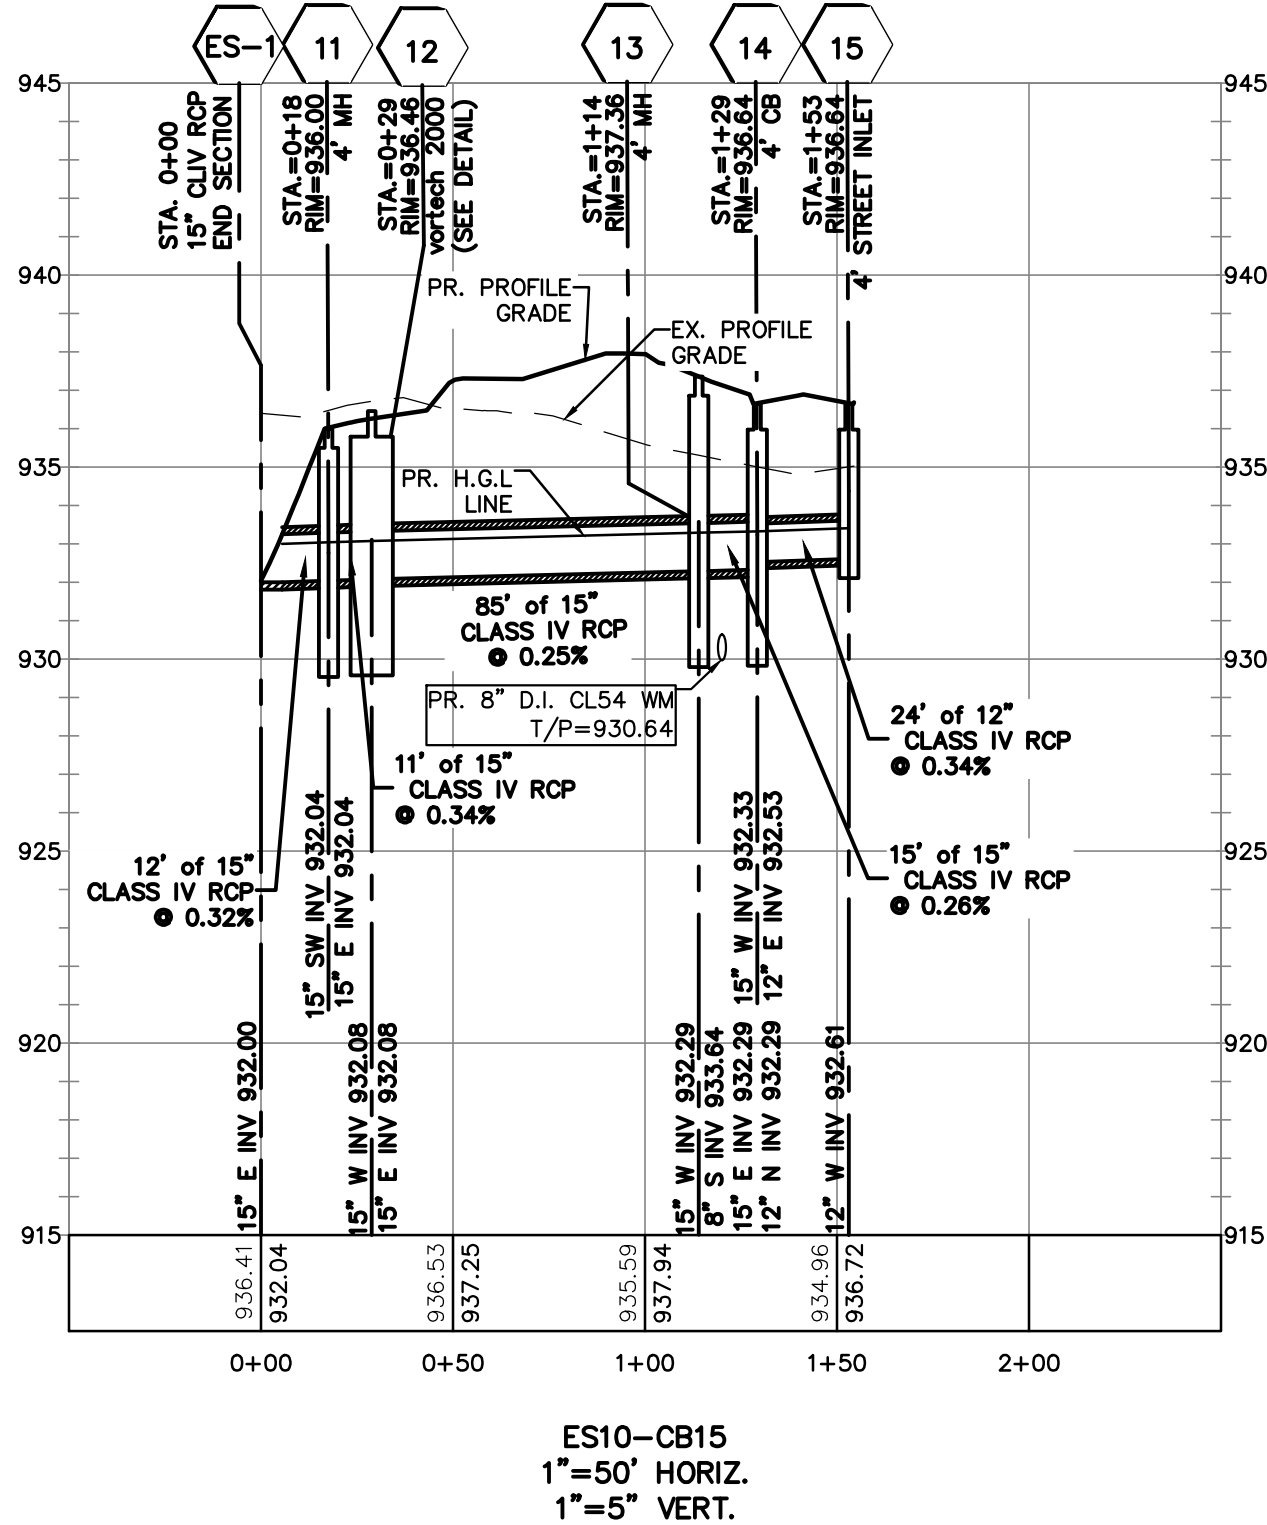

ES10-CB15
1"=50' HORIZ.
1"=5' VERT.

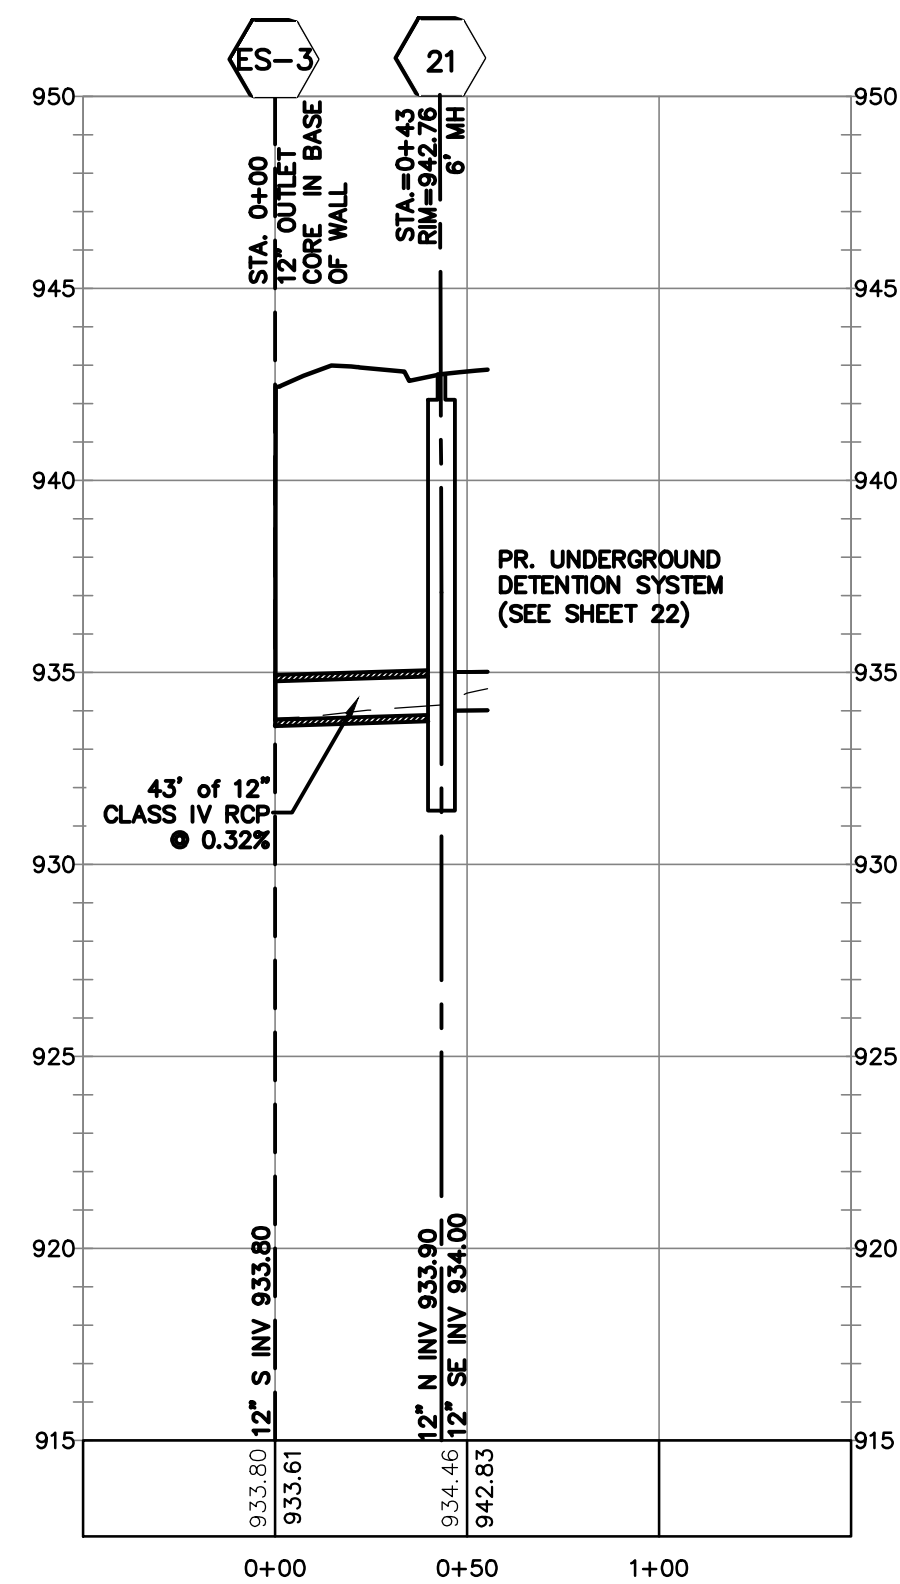

ES3 - UGD
1"=50' HORIZ.
1"=5' VERT.

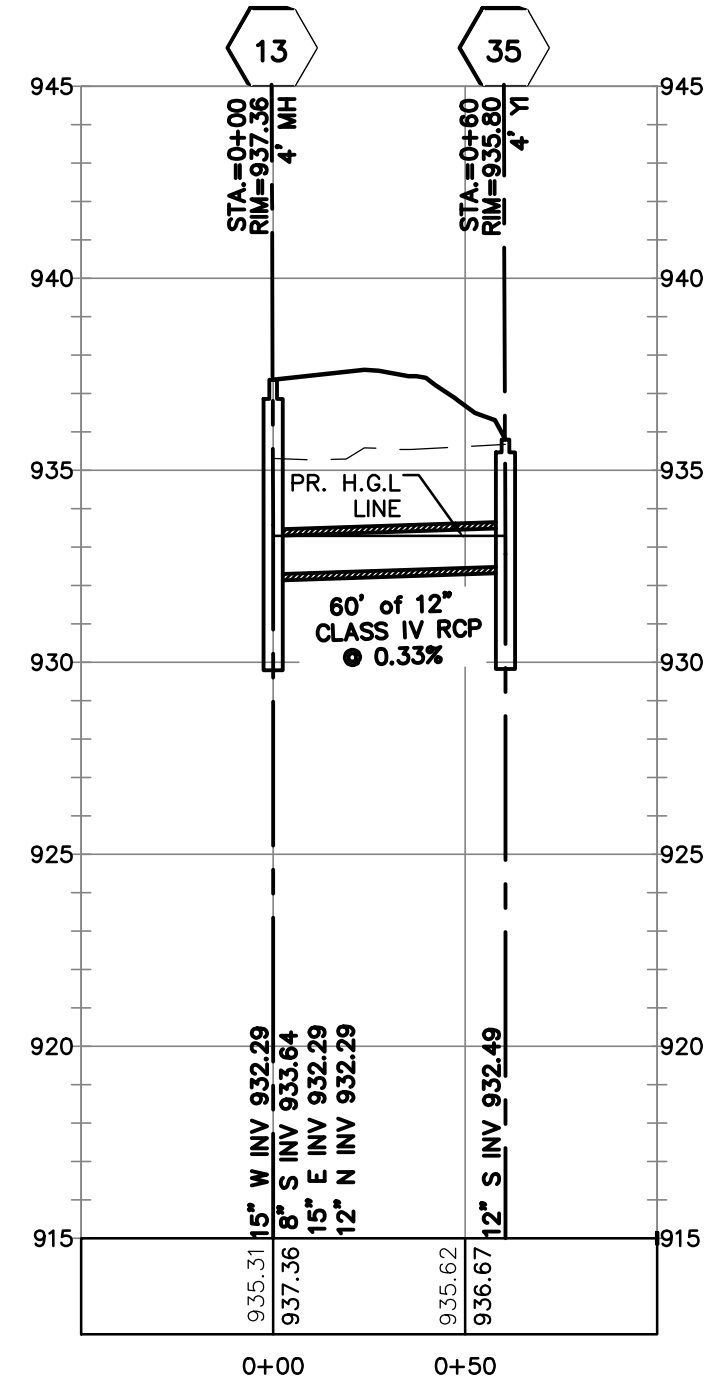

MH13 - IN35
1"=50' HORIZ.
1"=5' VERT.

NOTE:
8" SDR 26 PVC PIPE RECEIVES SUMP LEAD
WATER ONLY. NO SURFACE WATER TO ENTER
THIS PART OF SYSTEM.

STORM QUANTITIES

STORM SEWER

15" CLIV RCP	123 LF
12" CLIV RCP	278 LF
8" SDR 26 PVC	763 LF
2' MANHOLE	8 EA
2' CATCH BASIN	1 EA
4' STREET INLET	1 EA
4' CATCH BASIN	2 EA
4' MANHOLE	3 EA
4' YARD INLET	1 EA
6' MANHOLE	1 EA
7' CATCH BASIN	1 EA
WATER QUALITY STR	2 EA
15" CLIV RCP END SECTION	1 EA
12" CLIV RCP END SECTION	3 EA

UTILITY CROSSING TABLE:

#1 - SANITARY/STORM 8" STM B/P: 937.55 8" SAN T/P: 929.29 CLEARANCE = 8.26'	#6 - WTR/STORM 12" STM B/P: 936.45 8" WM T/P: 934.95 CLEARANCE = 1.50'
#2 - SANITARY/STORM 12" STM B/P: 936.85 8" SAN T/P: 929.89 CLEARANCE = 6.96'	#7 - WTR/STORM 18" STM B/P: 936.25 8" WM T/P: 934.75 CLEARANCE = 1.50'
#3 - WTR/SANITARY 8" WM B/P: 935.79 8" SAN T/P: 930.44 CLEARANCE = 5.35'	#8 - WTR/STORM 12" STM B/P: 936.54 8" WM T/P: 934.95 CLEARANCE = 1.59'
#4 - WTR/STORM 12" STM B/P: 936.52 8" WM T/P: 934.95 CLEARANCE = 1.57'	#9 - WTR/STORM 15" STM B/P: 932.11 8" WM T/P: 930.61 CLEARANCE = 1.50'
#5 - WTR/STORM 12" STM B/P: 936.50 8" WM T/P: 934.95 CLEARANCE = 1.55'	#10 - SAN/WTR 4" SAN B/P: 931.00 8" WM T/P: 929.50 CLEARANCE = 1.5'



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LAND DEVELOPMENT SERVICES

SECTION 3

TOWN 1 NORTH, RANGE 8 EAST

CITY OF NOVI

OAKLAND COUNTY, MICHIGAN

SCENIC PINES

SINGH DEVELOPMENT, LLC.
7125 ORCHARD LAKE ROAD
BLOOMFIELD HILLS, MICHIGAN 48322

STORM SEWER PROFILES

DATE: 11-27-2019

REVISIONS

PER CITY 03-24-2020

PER CITY 01-18-2021


DR BY: SDT
CK BY: SDT/MY
P.M. SA
SCALE 0 25 50
1" = 50 FEET
JOB NO. 180905
SHEET NO. 20
SHEET 20 OF 38

UTILITY CROSSING TABLE:


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- #5 - WTR/STORM
12" STM B/P: 936.50
8" WM T/P: 934.95
CLEARANCE = 1.55'
- #6 - WTR/STORM
12" STM B/P: 936.45
8" WM T/P: 934.95
CLEARANCE = 1.50'
- #7 - WTR/STORM
18" STM B/P: 936.25
8" WM T/P: 934.75
CLEARANCE = 1.50'
- #8 - WTR/STORM
12" STM B/P: 936.54
8" WM T/P: 934.95
CLEARANCE = 1.59'
- #9 - WTR/STORM
15" STM B/P: 932.11
8" WM T/P: 930.61
CLEARANCE = 1.50'
- #10 - SAN/WTR
4" SAN B/P: 931.00
8" WM T/P: 929.50
CLEARANCE = 1.5'

STORM QUANTITIES


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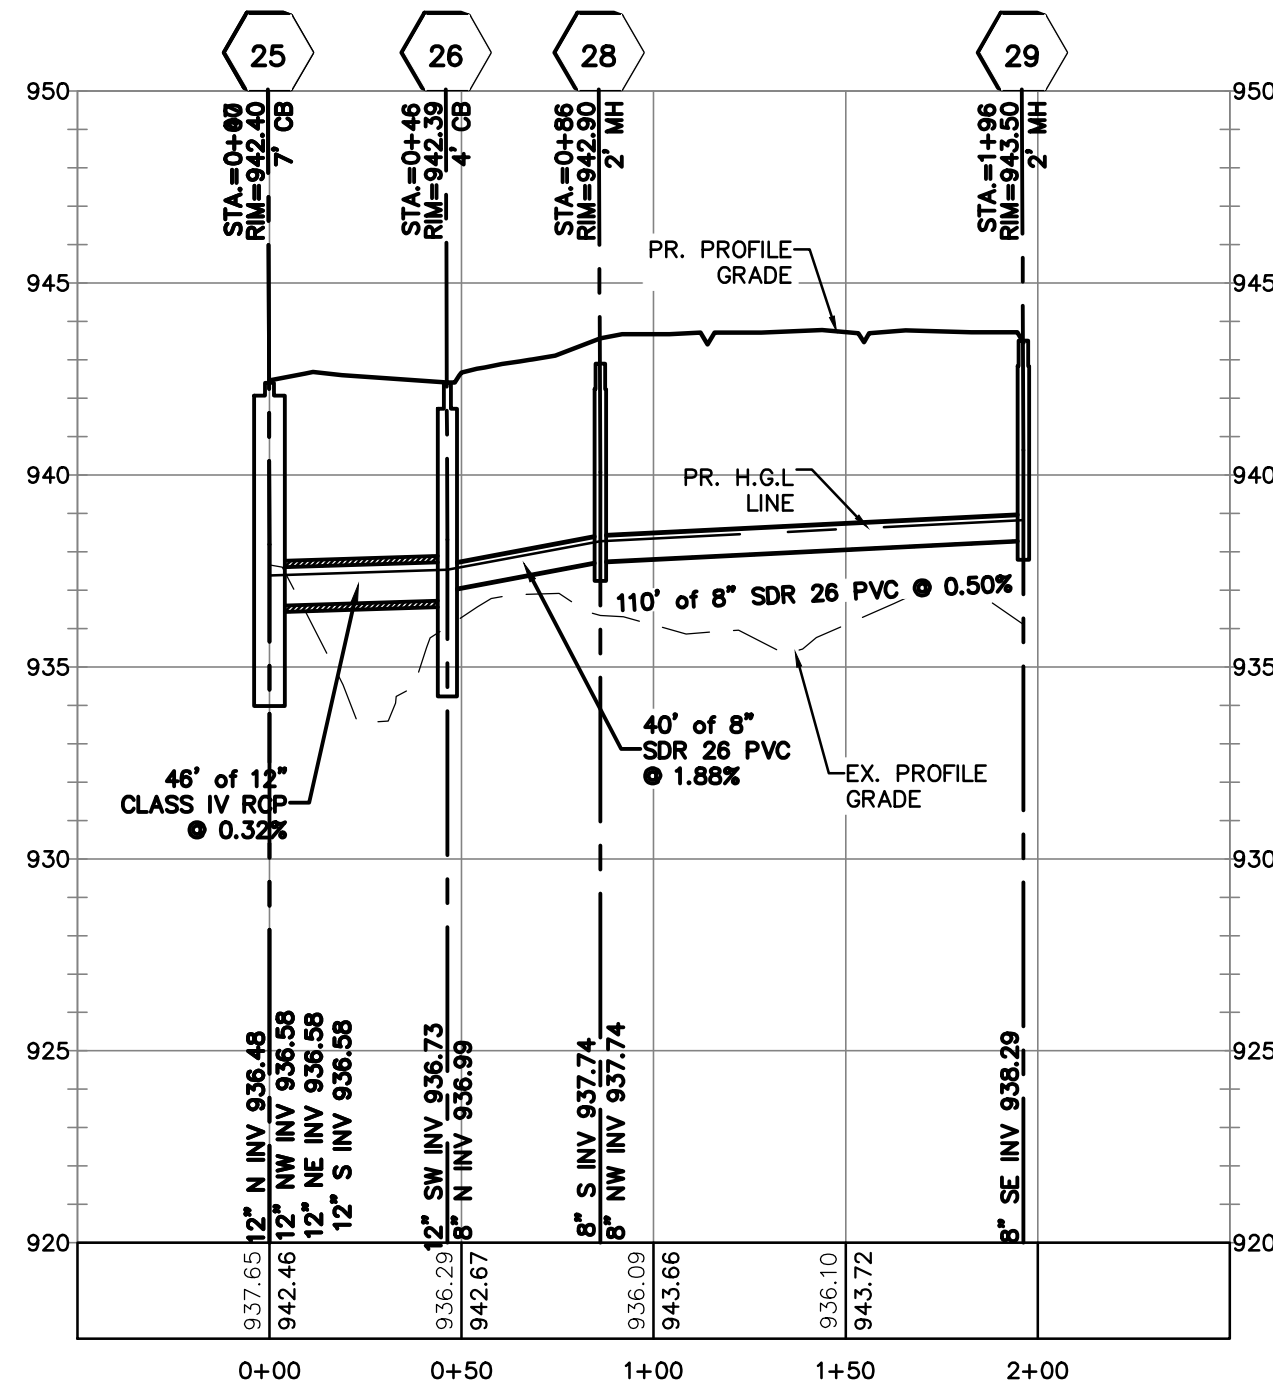
STM33 - STM 31
1"=50' HORIZ.
1"=5' VERT.

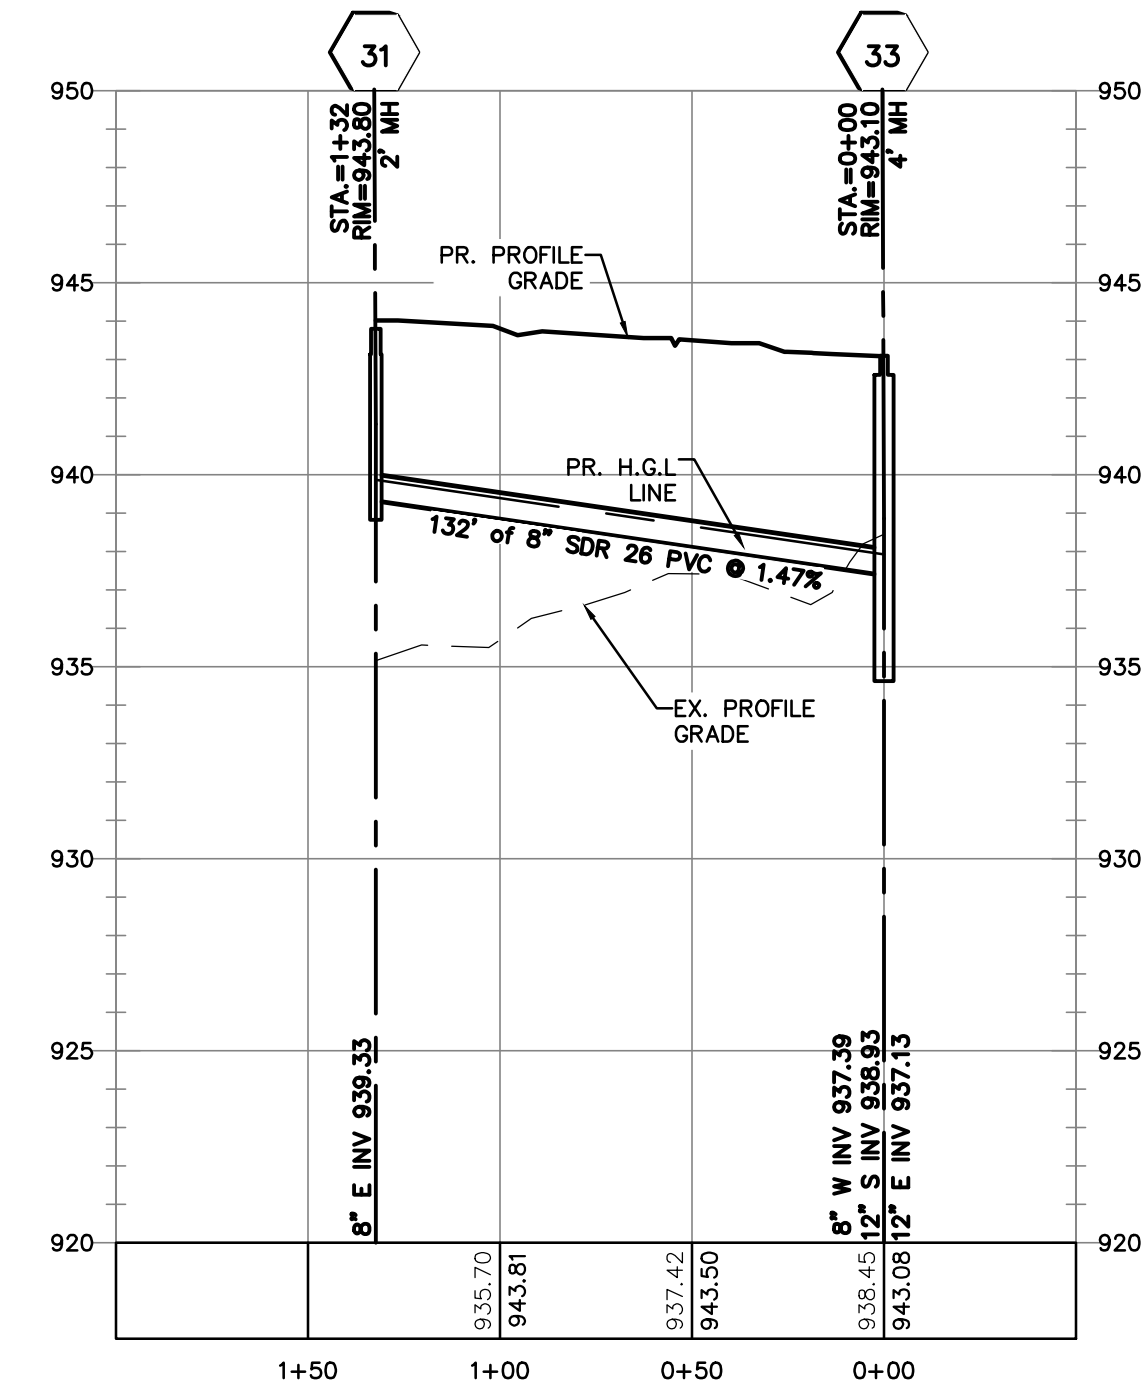


STM 24 - STM 34
1"=50' HORIZ.
1"=5' VERT.

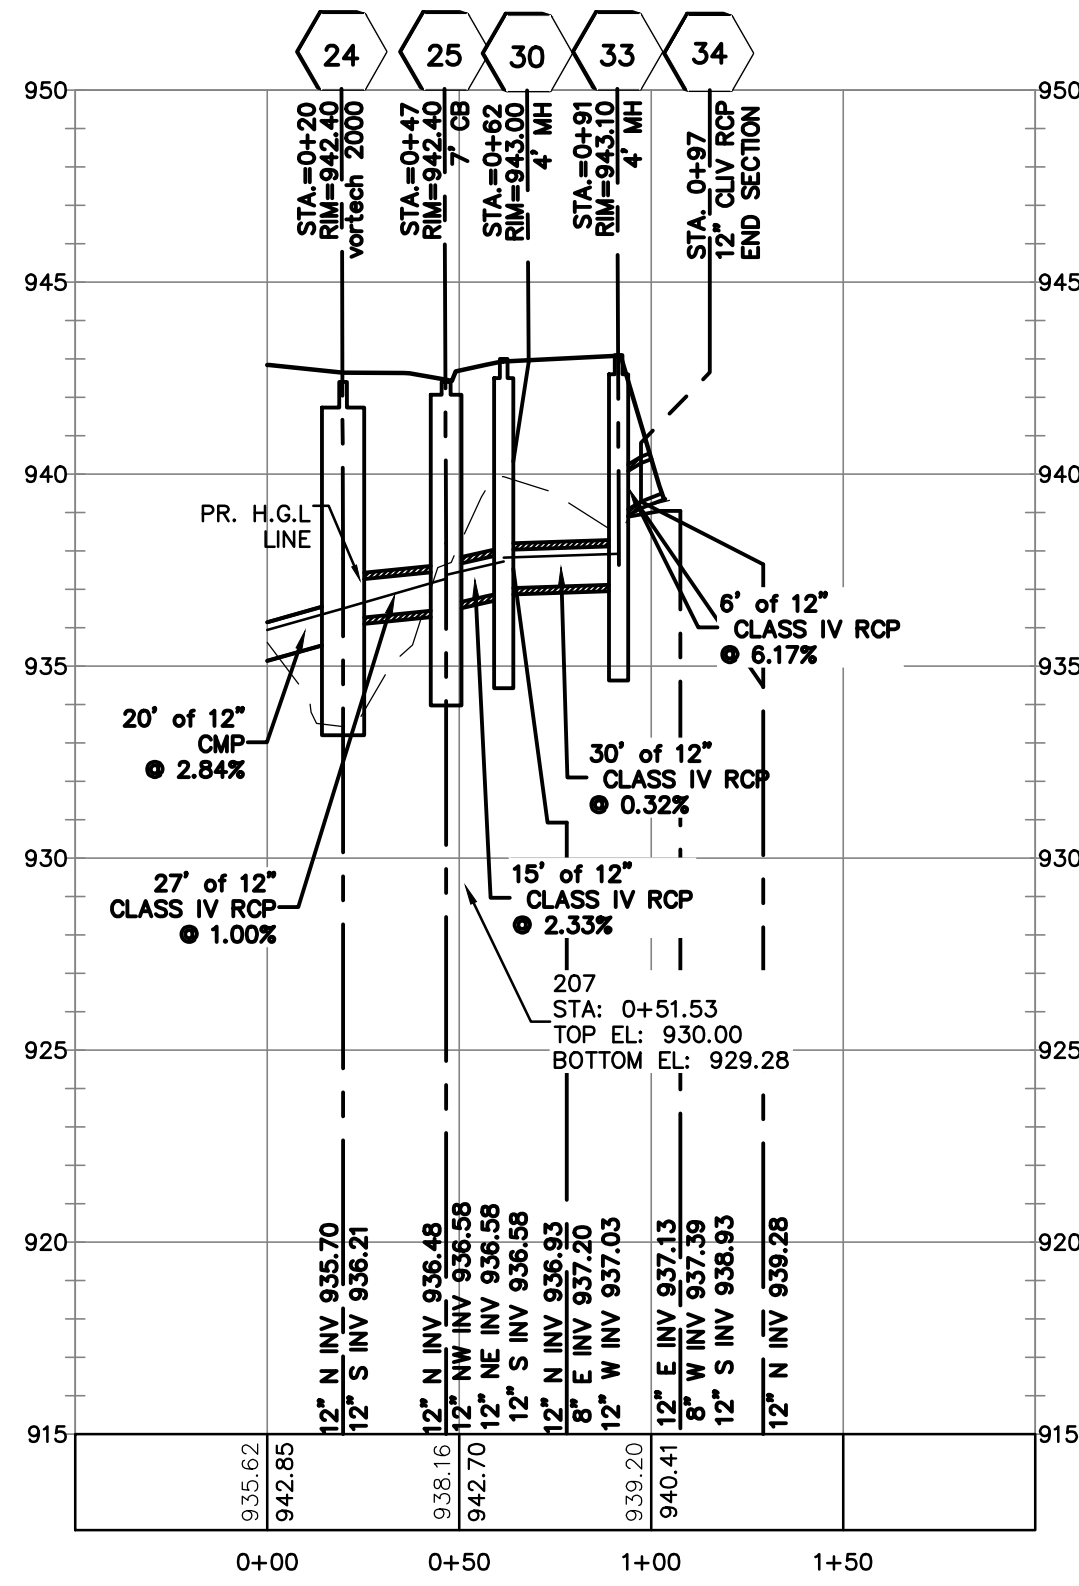

STM 33 - STM 31 (1)
1"=50' HORIZ.
1"=5' VERT.

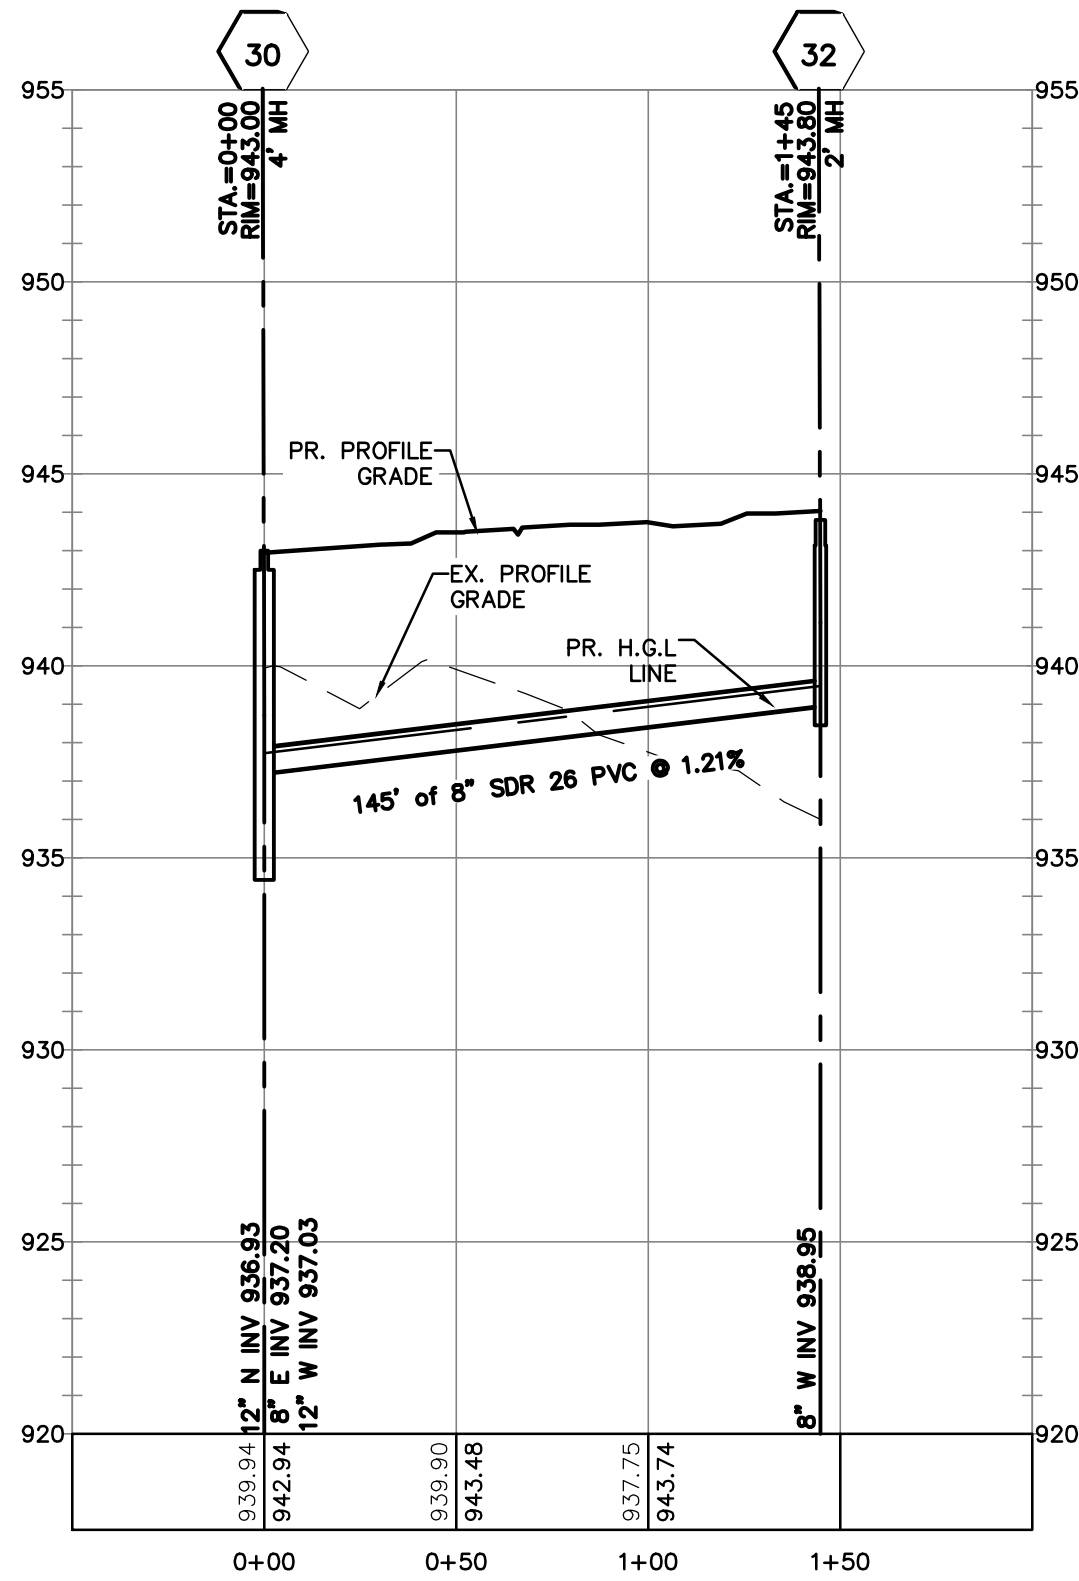


STM 25 - SM 29
1"=50' HORIZ.
1"=5' VERT.

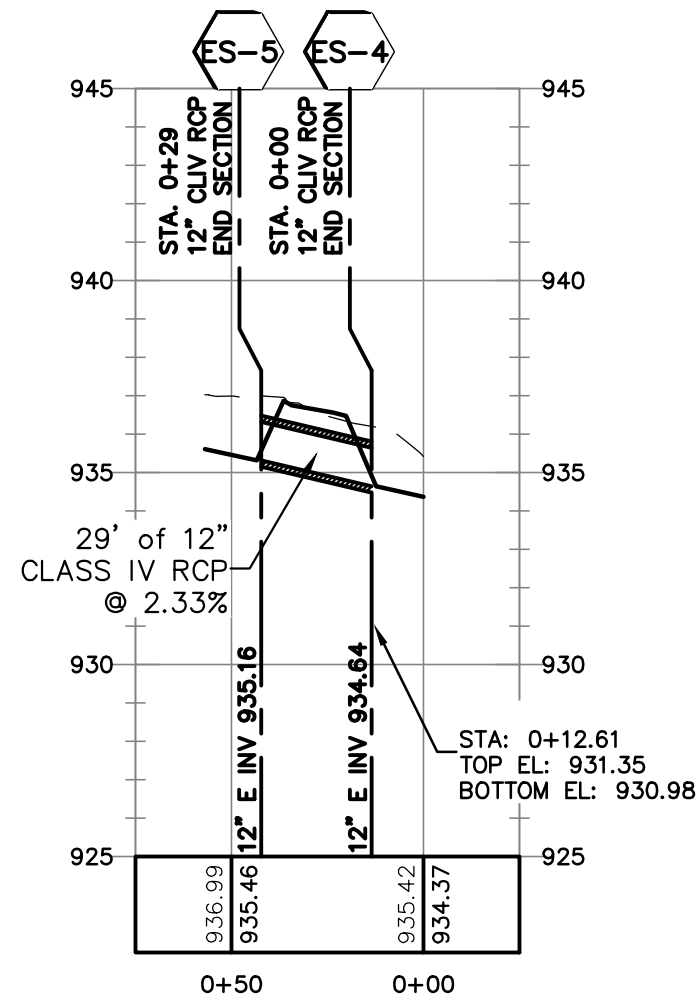

STM 36-37
1"=50' HORIZ.
1"=5' VERT.

NOTE:
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STM25 - STM 26
1"=50' HORIZ.
1"=5' VERT.

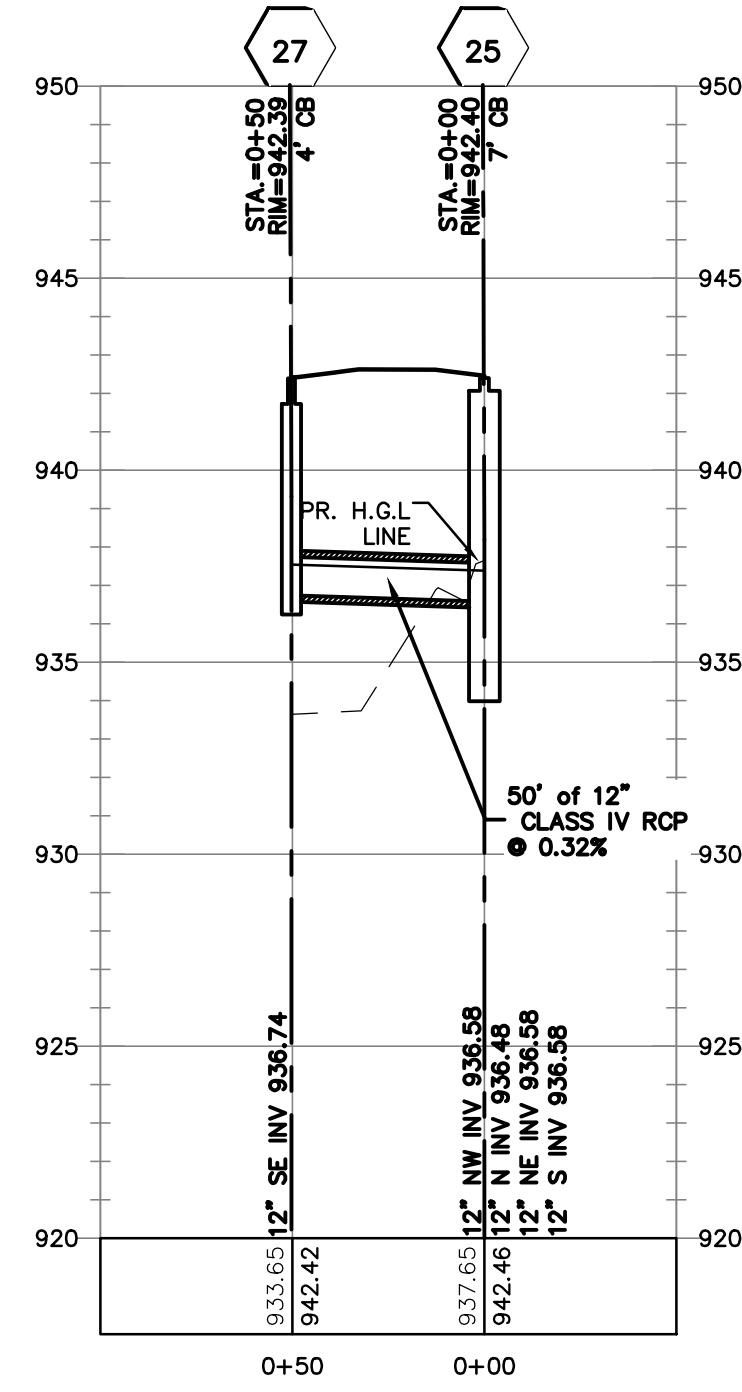

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SCENIC PINES	SINGH DEVELOPMENT, LLC. 7125 ORCHARD LAKE ROAD BLOOMFIELD HILLS, MICHIGAN 48322	STORM SEWER PROFILES	

DATE:	11-27-2019
REVISIONS	
PER CITY 03-24-2020	
PER CITY 01-18-2021	
DR BY:	SDT
CK BY:	SDT/MY
P.M.	SA
SCALE	0 25 50
1" = 50 FEET	
JOB NO.	180905
SHEET NO.	21
	SHEET 21 OF 38

A north arrow pointing upwards, labeled "NORTH". Below it is a graphic scale bar in feet, with markings at 20', 0, 10', 20', 40', and 60'. Below the scale bar, it says "(IN FEET)" and "1 inch = 20' ft."



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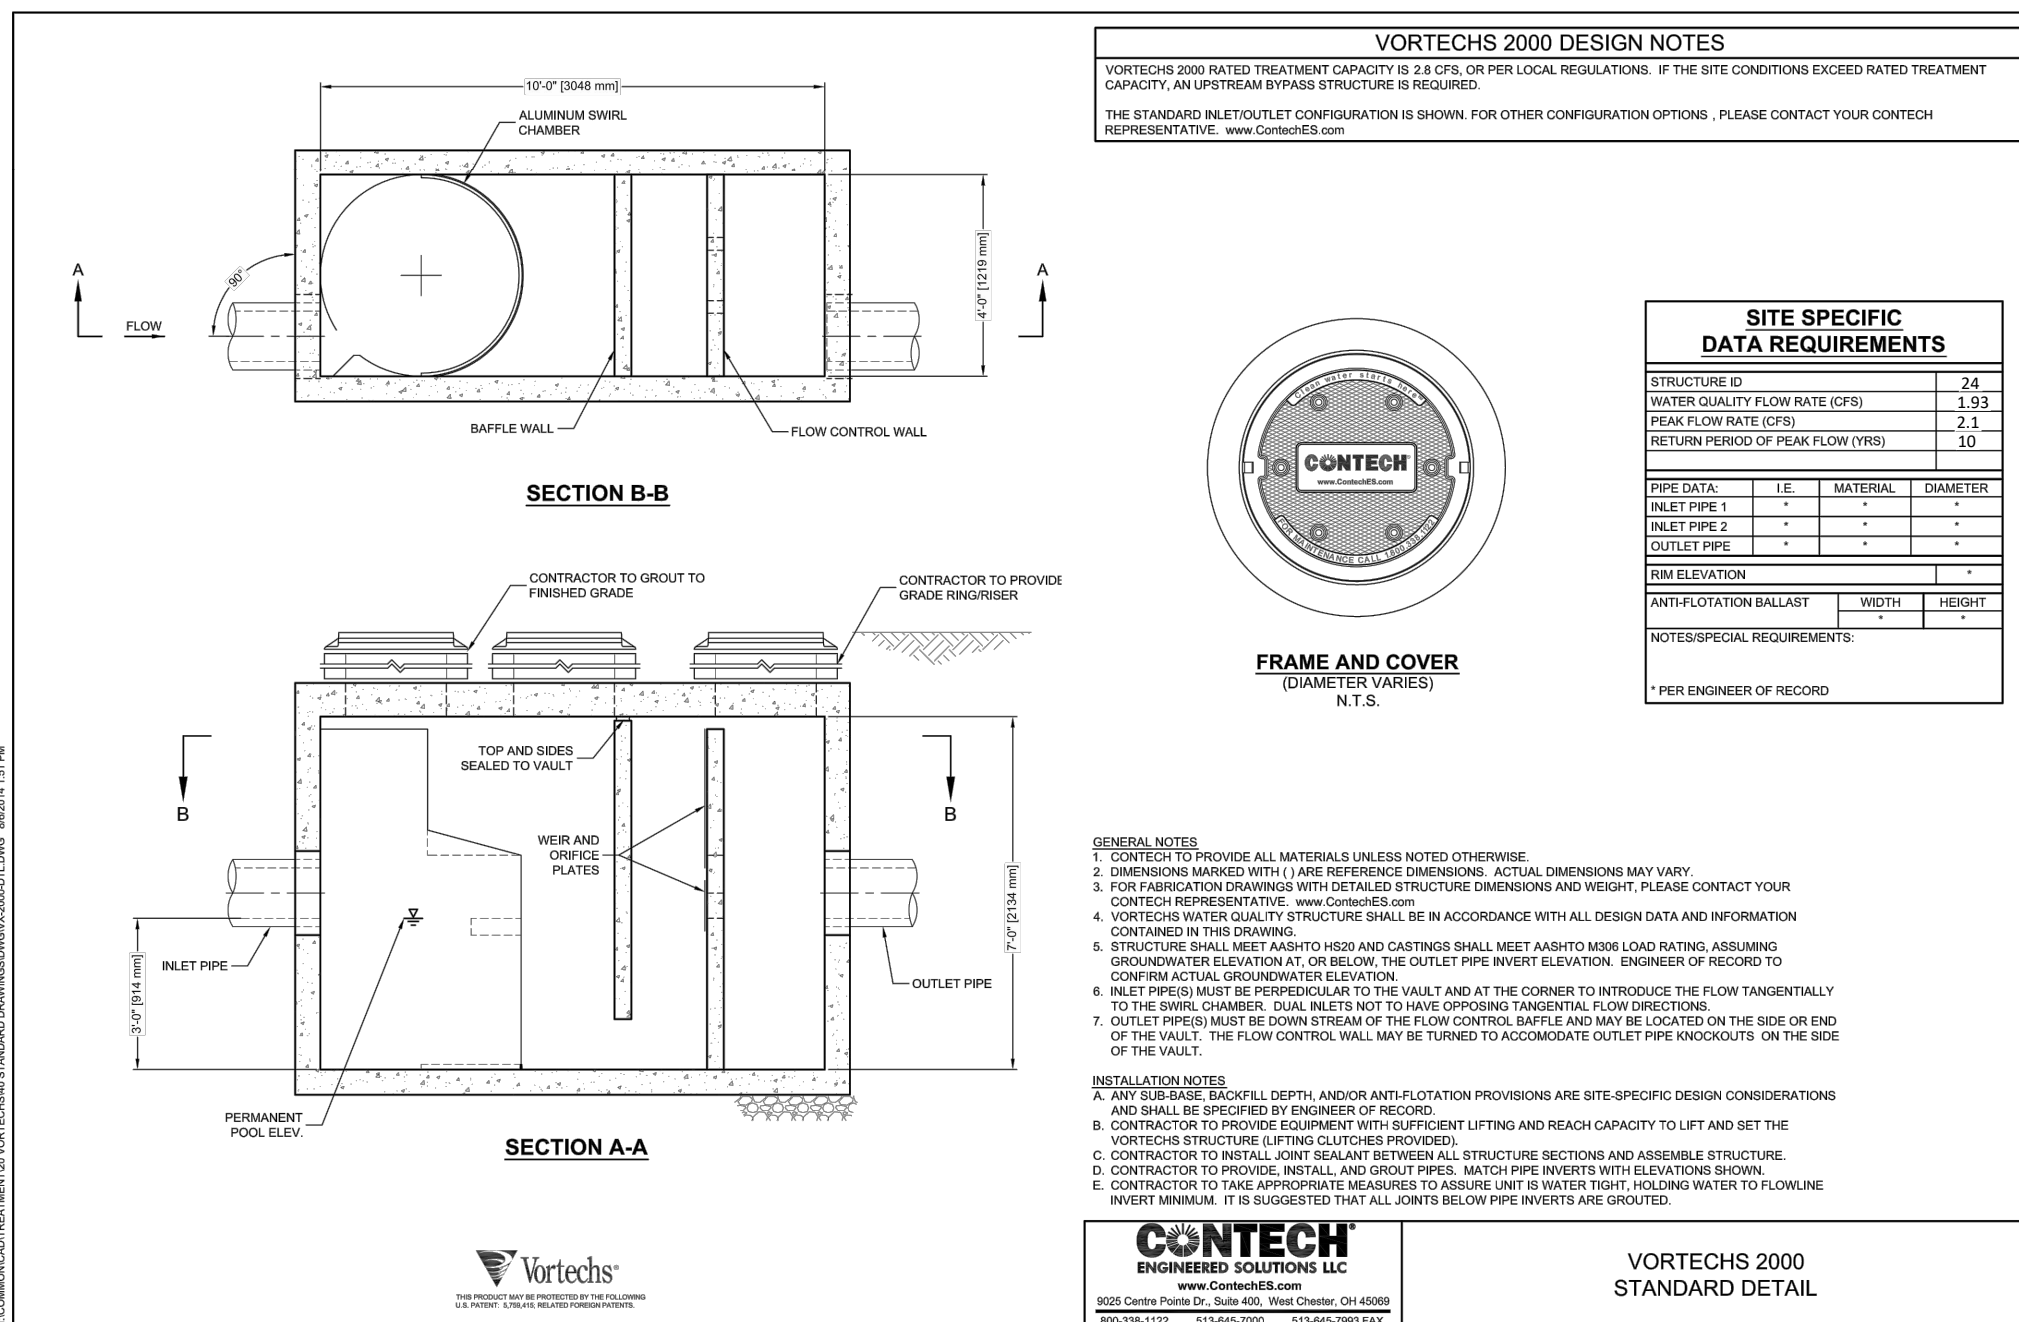





The UMLOR Group
LAND DEVELOPMENT SERVICES

CLIENT: SINGH DEVELOPMENT, LLC.
7125 ORCHARD LAKE ROAD
BLOOMFIELD HILLS, MICHIGAN 48322

UNDERGROUND DETENTION STORMWATER
MANAGEMENT PLAN AND DETAILS

22
SHEET 22 OF 38



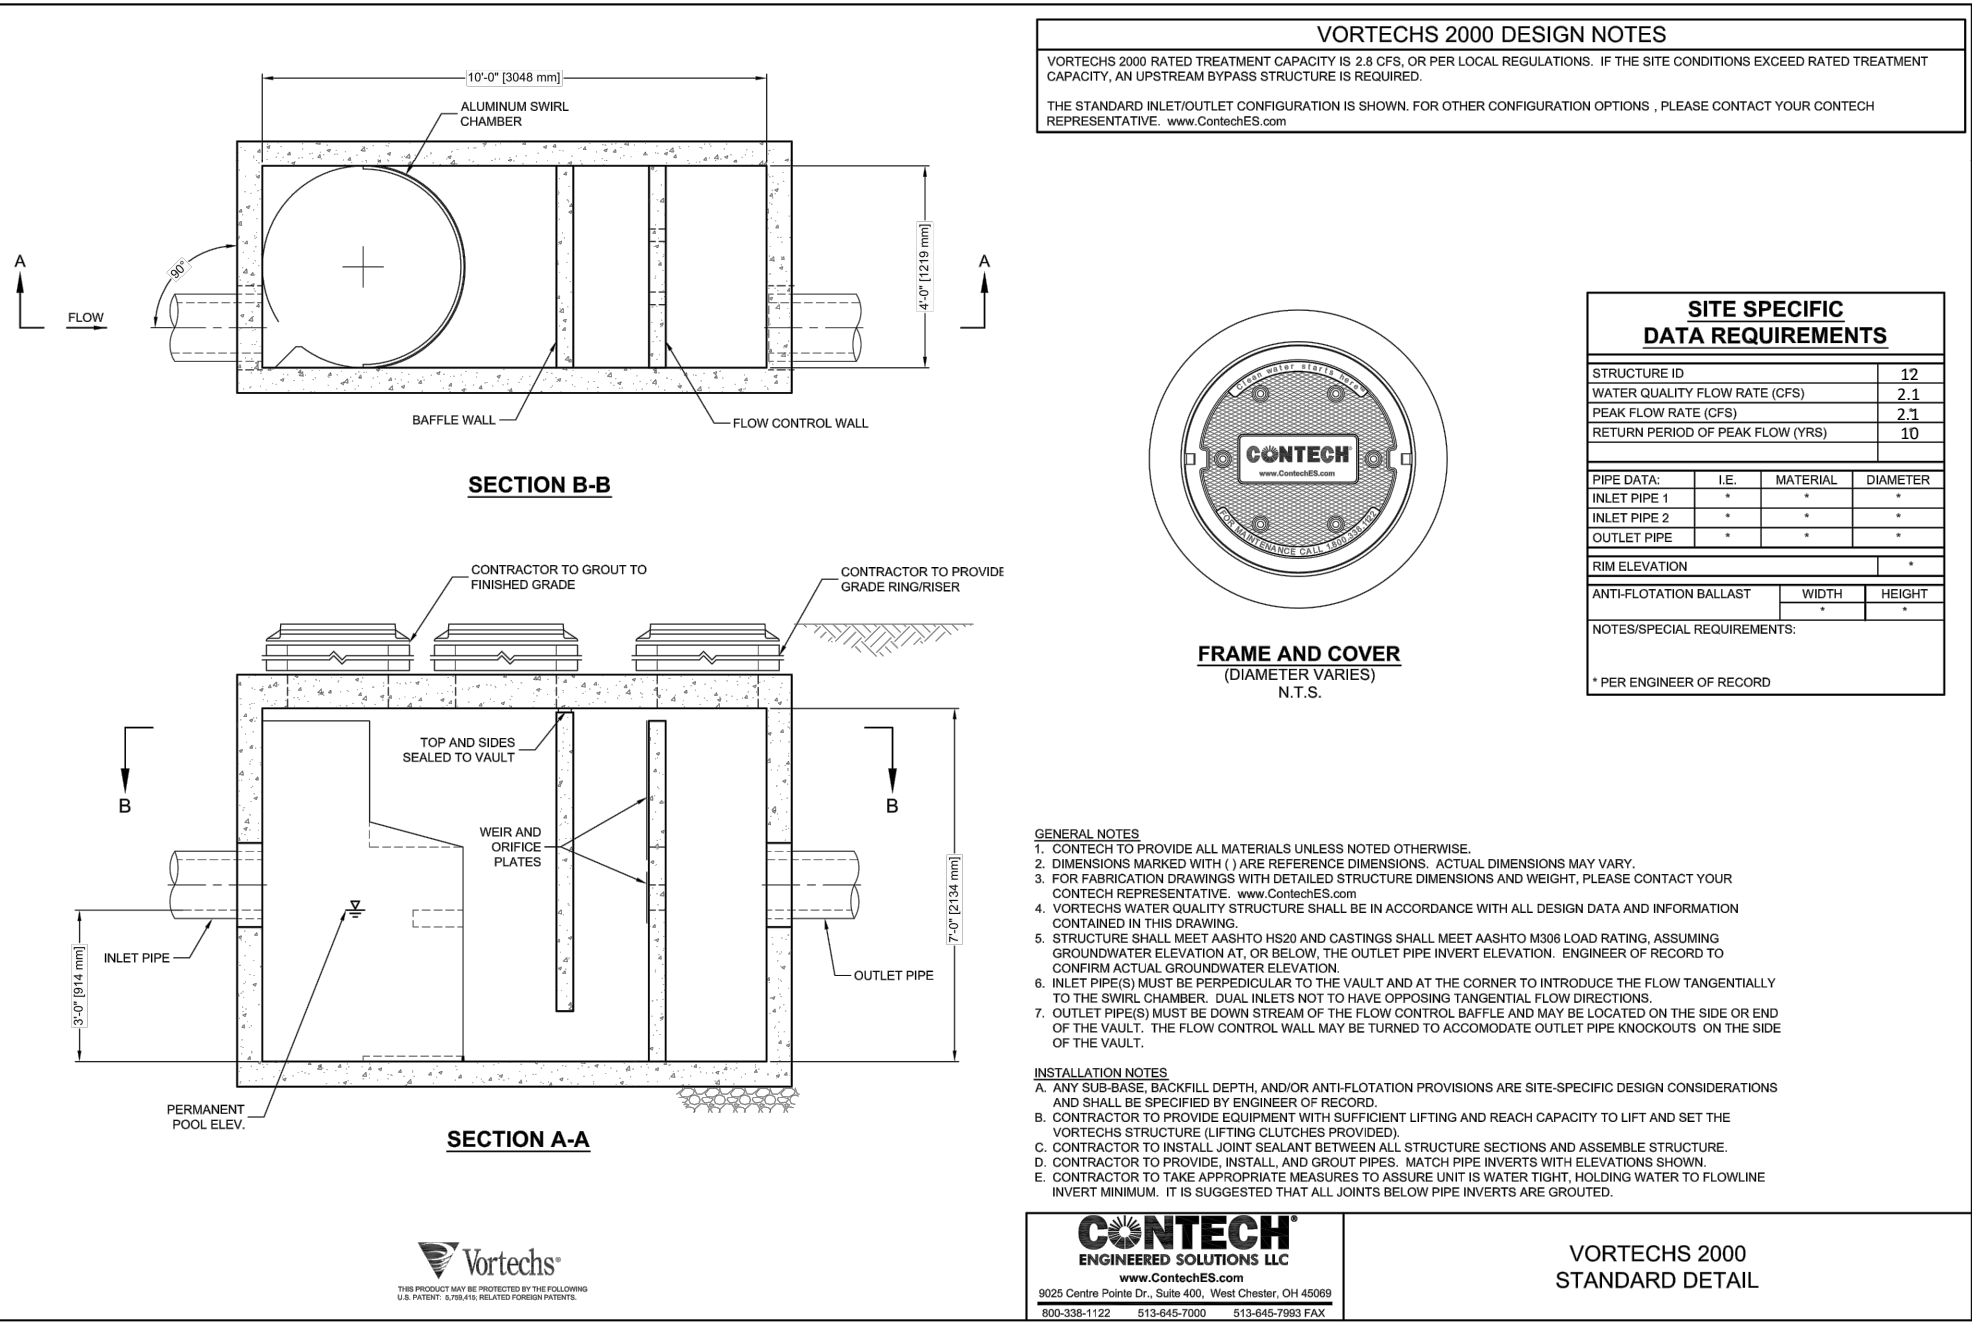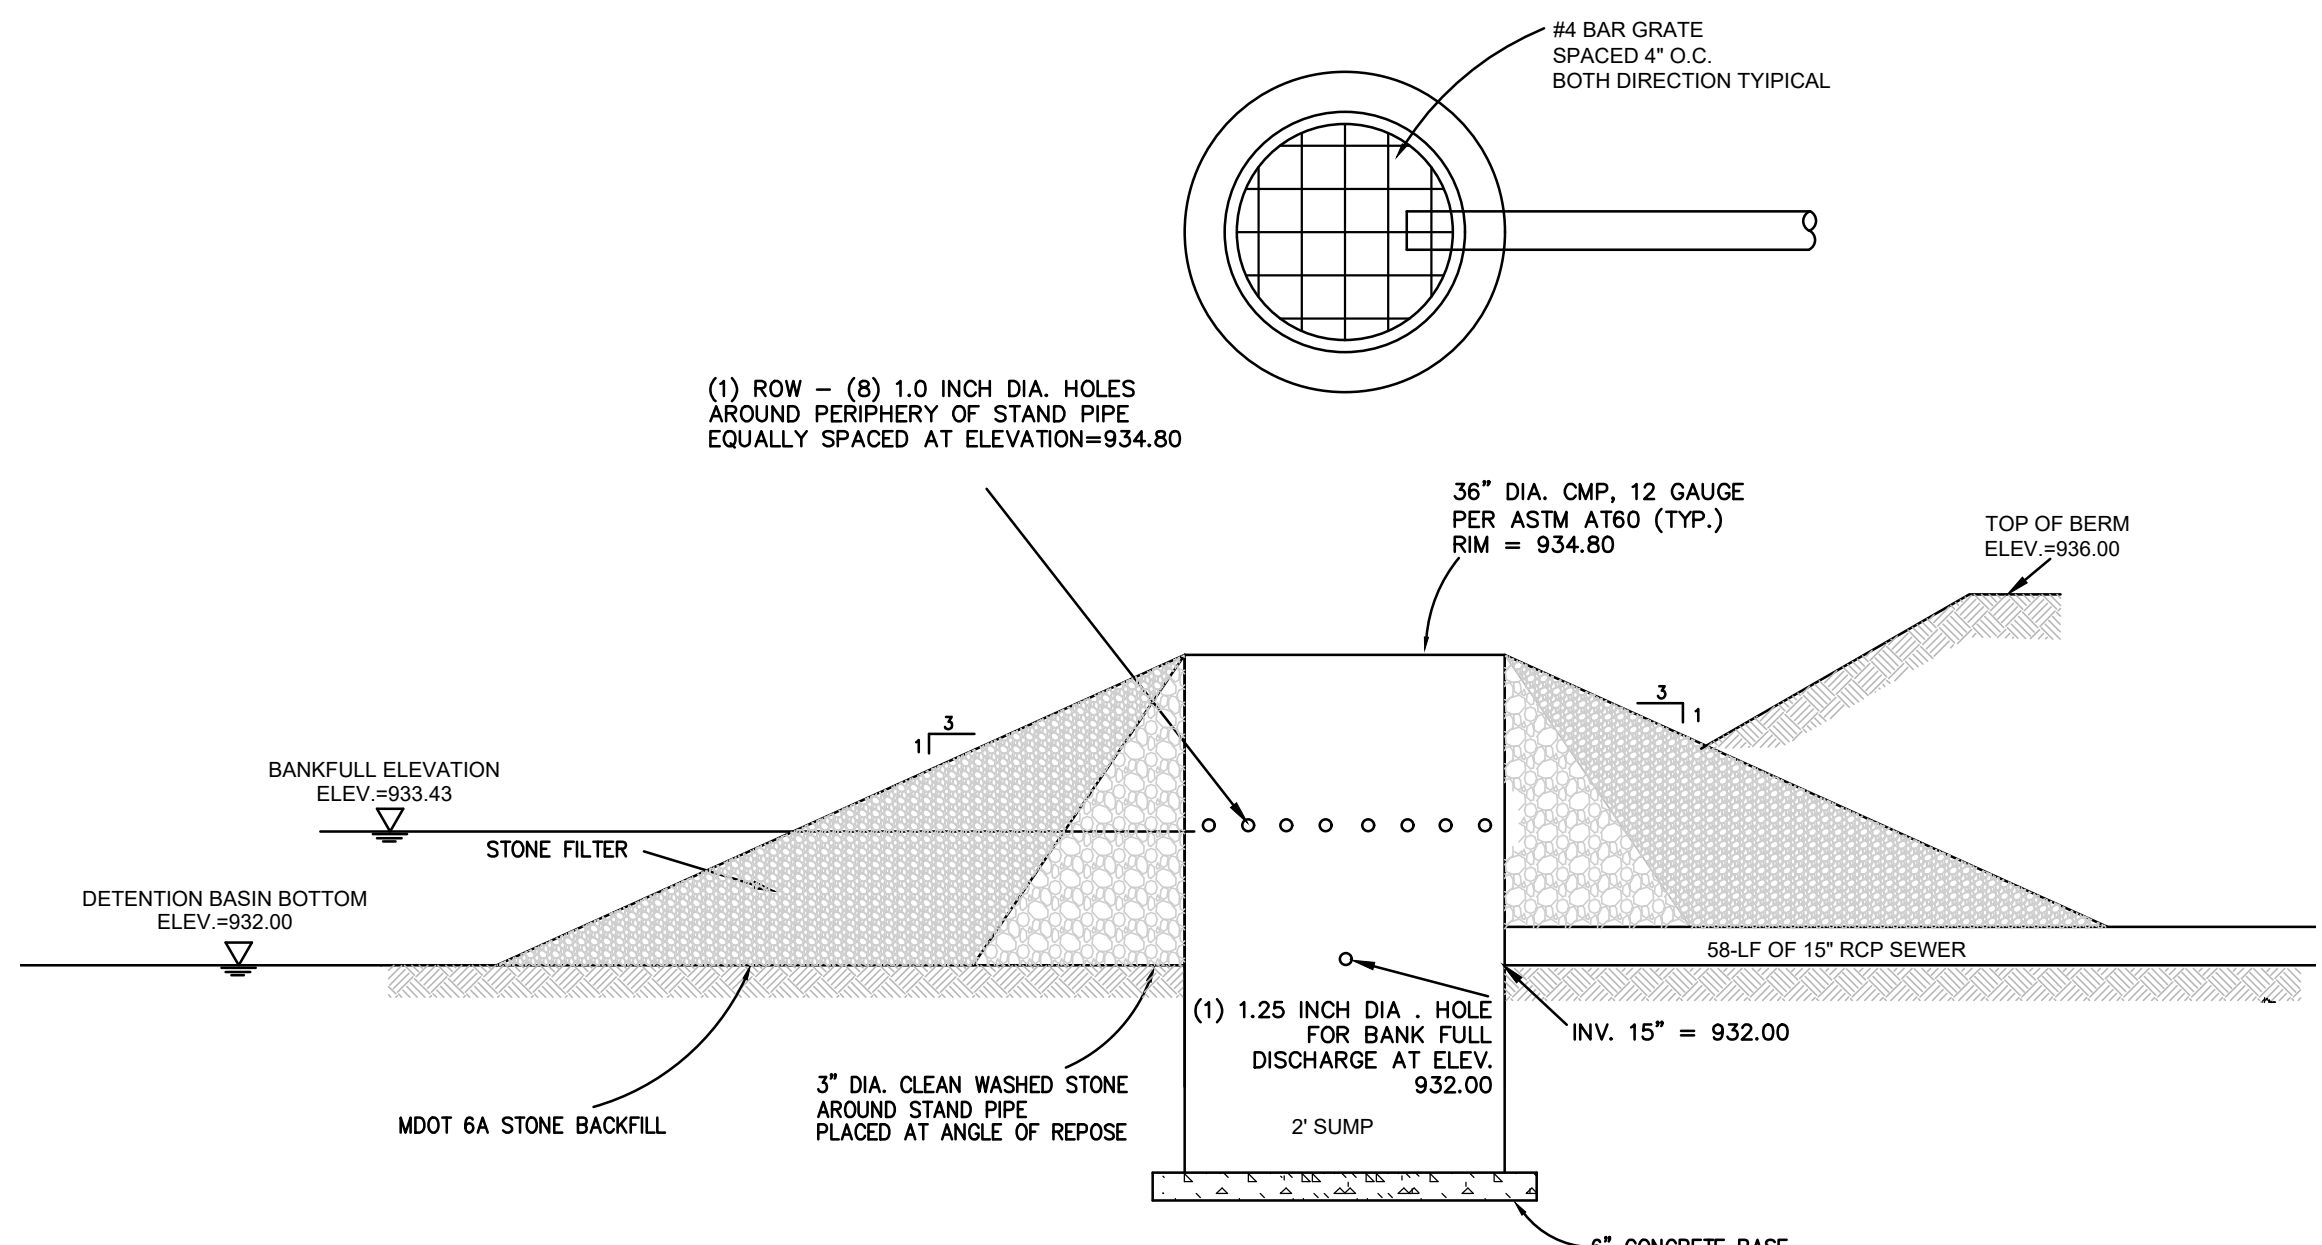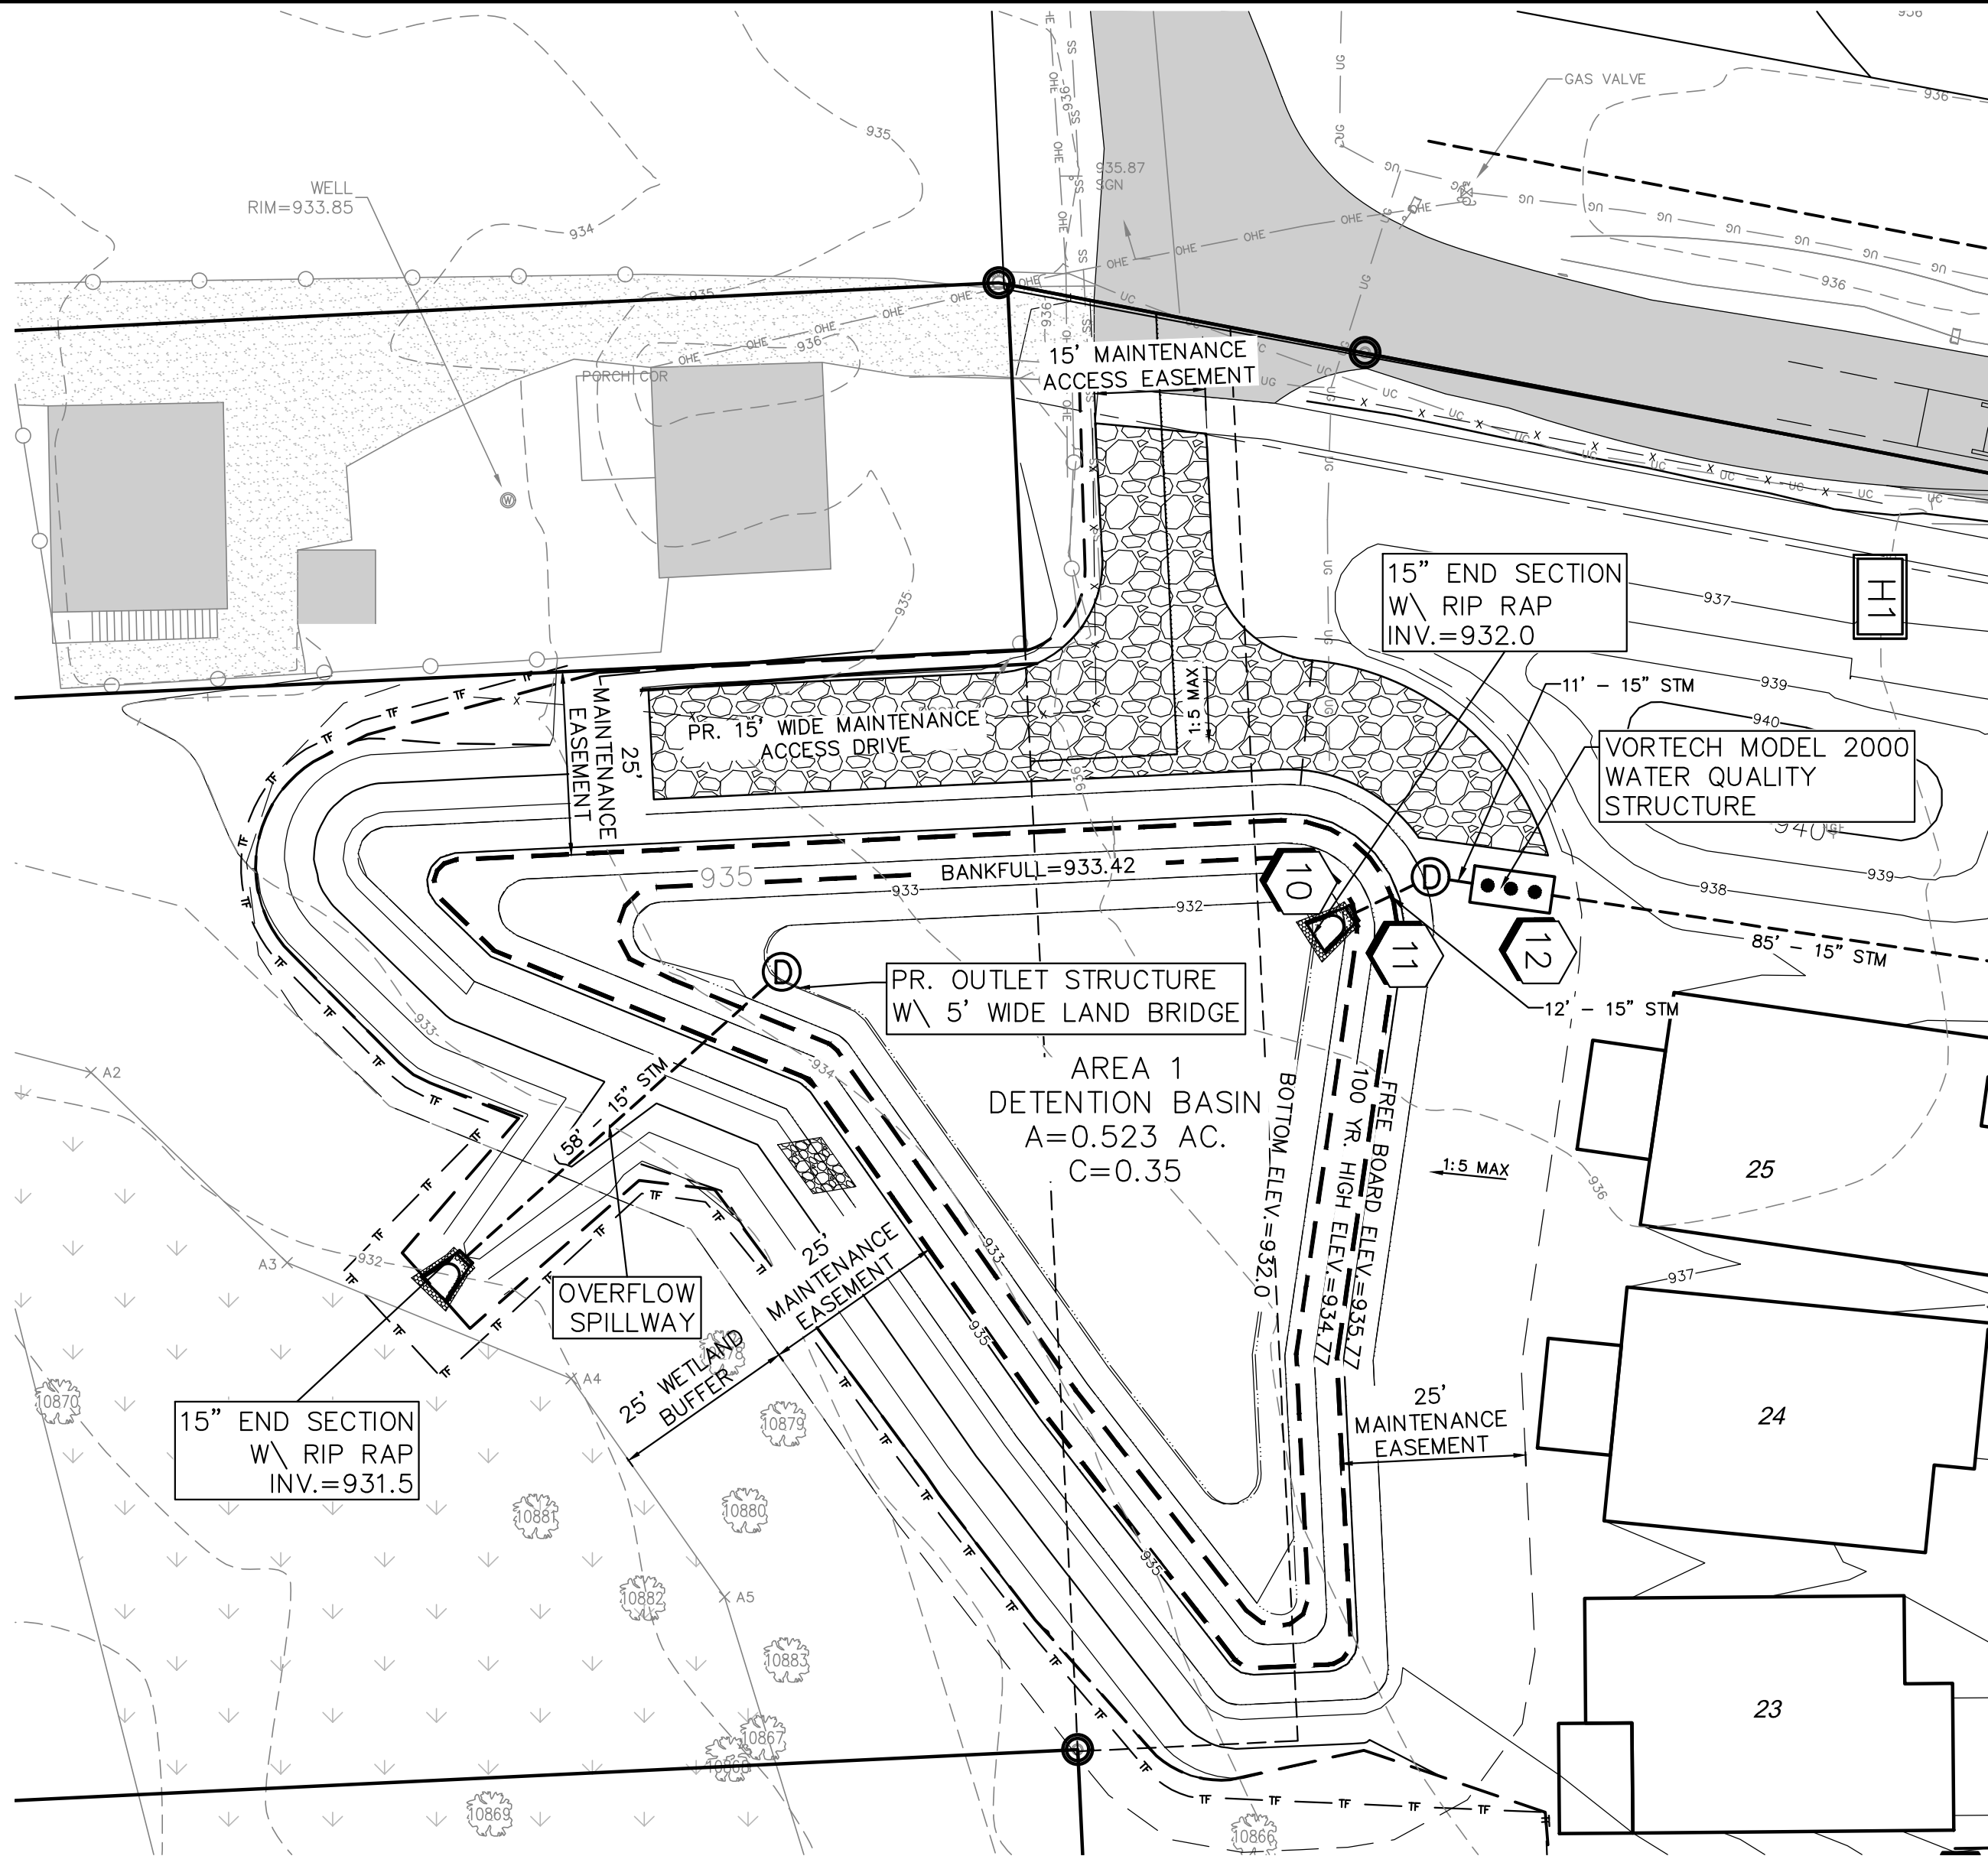

SCENIC PINES

SINGLE FAMILY RESIDENTIAL

STORM WATER MANAGEMENT PLAN

PEMBINE ROAD, CITY OF NOVI, OAKLAND COUNTY

City of Novi - Scenic Pines				
AREA 1 WEIGHTED 'C' CALCULATIONS				
	Type	Area (SF)	Runoff Coefficient 'C'	C x A
Total Drainage Area 'A'	Non Improved Outlet	77,101	0.2	
Proposed Impervious Area	Roofs, Patios, Drive, Walks	20,207	0.95	19,197
Proposed Impervious Area	Streets and Walks	20,302	0.95	19,287
Proposed Pervious Area		36,592	0.35	12,807
Sum (C x A)				51,291
Weighted 'Cw'=sum(C x A) / A		0.67	Use	

CITY OF NOVI				
Oakland County Drain Commission Method				
Gravity Outlet to Wetlands				
Time of Concentration T(min) =	20			
Existing Coefficient C =	0.2			
Proposed Coefficient C =	0.67			
Area 1 A(acres) =	1.77			

Frequency of Storm	Rainfall Intensity I (in/Hr)	Allowable Outflow Qa(cfs)	Maximum Outflow Qo(cfs/acre)	Storage Time Equation T(min)	Storage Volume Equation Vs(Ft3/(Ax C))	Storage Volume V(Ft3)
1 Year	1.60	0.35	0.30	69.77	2341	2757
5 Year	3.22	0.35	0.30	109.49	6766	6789
10 Year	3.89	0.35	0.30	122.74	7247	8533
25 Year	4.78	0.35	0.30	138.76	9262	10906
50 Year	5.44	0.35	0.30	149.81	10796	12712
100 Year	6.11	0.35	0.30	160.21	12346	14537

Mechanical Pre-treatment Calculation:				
Q = C x I x A = Q=0.68x(97/(T+30))x1.71				
Use Vortech Model 2000 rated at 2.8-cfs				
2.28 CFS				
Bankfull				
Vbf=5160xAxC	6075.779535			
BF Elev=	933.43			
Elev.100YR=	934.80			

Storage Analysis			
Elevation	Area (sf)	Ave. Area (sf)	Cumulative Volume (cft)
932	3,121	0	0
933	4,474	3,798	3,798
934	6,011	5,243	9,040
935	7,663	6,837	15,877
Xtop = 936	9,460	8,562	24,439

STORM WATER DETENTION CALCULATION				
Area 1				
TOTAL AREA	=	1.77		
Cavg	=	0.67		
Qa	=	0.20A = 0.20x 1.71 ACRES	=	0.354 cfs
Qo	=	Qa/(Ax C) = .43/(1.71x .68)	=	0.300843 cfs/acre
T100	=	Sqft (10312.5 / Qo)+ 25	=	160.2066 minutes
Vs100	=	16500 x T100 / (T100+25) - 40 x Qo x T100	=	12346.16 cft/acre
Vt100	=	Vs100 x A x C	=	14537.31 cft
Z100	=	935 - ((15877 - 14331)/(15877-9040))	=	934.80

BANK FULL CALCULATIONS				
Vbf	=	5160 x A x C	=	6075.78 cft
Zbf	=	934-(9040-5973)/(9040-3798))	=	933.43
Zout	=	932	=	932

STANDPIPE OUTLET HOLE SIZING - "BANK FULL" DISCHARGE				
BANKFULL SHOULD DISCHARGE WITHIN 36 TO 48 HOURS				
Qbf	=	Vbf/144000	=	0.042193 cfs
havg	=	2/3 (Zbf-Zout)	=	0.556864 ft
Aout	=	Qbf / (0.62 x Sqrt(2gh))	=	0.008669
1.25" DIA HOLE = 0.008 Sqft				
Aout / .008	=		=	1.083652

Check bank full release time				
A(Act)	=		=	0.008 sft
Qbf	=	(A x 0.62 x Sqrt(2*32.2*h))	=	0.038936 cfs
Tbf	=	(Vbf/(Qbf x 3600))	=	43.34607 hrs

STANDPIPE OUTLET HOLES SIZING - "100 YR DISCHARGE"				
Q100	=	Qa	=	0.354 cfs
havg	=	2/3 (Z100-Zout)	=	1.670304 ft
A	=	Q100/(0.62 x Sqrt(64.4 x h))	=	0.002025 sft
1" dia hole	=		=	0.0055 sft
Aout	=	A/0.0055	=	9.459102
Check 100 YR release rate not to exceed allowable release rate				
A(Act)	=		=	0.044 sft
Q100	=	(A x 0.62 x Sqrt(2*32.2*h))	=	0.299394 cfs
Q100+Qbf	=	(0.299+0.039)	=	0.33833 cfs

OVERFLOW WEIR SIZING				
Size of Overflow Manhole=				3 ft
% of Manhole that can be used as a weir				100 %
Calculated length of weir =	L =			9.42 ft
Drainage Area, A =				1.77 ac
C-Factor, C =				0.67

(From Pipe Flow Calculations)				
Longest To from Pipe Calcs =				25.00 min
Sum of all flow into Basin =				3.17 cfs

Volume of Basin =				14537 ft ³
Storage elevation =				934.77 ft
Freeboard Elevation =				935.77 ft
Time to fill basin =				76.43 min
I = 175 / (T+25)				1.38 in / hr



Qexp = C ^{1/4} A				1.63 cfs
Qweir = 3.33*(L) ^{3/2} (h ^{1/2})				
Calculate how high the water will rise above the Overflow Structure to pass the expected flow.				
h=				0.14 ft
Elevation of Water during Overflow Conditions =				0.14 ft

DETERMINE WIDTH OF OVERFLOW SPILLWAYS FOR DETENTION BASIN FOR 100-YEAR				
Acreeage Trib to Overflow (on + offsite):				1.77 ac
Composite run off coefficient:				0.67
(From Pipe Flow Calculations)				
Longest time of flow to basin:				25.00 min
Sum of all Flow into Basin				3.17 cfs
Volume of the Detention Basin =				14,537 of
Time to Fill basin = Vb=Qexp/Flow into Basin				76.43 min.
I = 275/(T + 25)				2.71 in / hr
Qexp=CIA=				3.19 cfs

CAPACITY OF 3 FOOT DIAMETER MANHOLE				
Q = C ^{1/4} L ^{1/2}				
C =				3.33
L =				9.42 ft
H =				1.00 ft
Qprov =				31.38 cfs

Size Spillway				
Sufficient capacity exists in the overflow Man Hole				
Provide minimum 3 feet wide overflow spillway				

CAPACITY OF THE 12" DETENTION BASIN OUTLET PIPE				
Orifice Formula, Q = 0.625*A*sqrt(64.4*H)				
Qexp 100-year				3.19 cfs
Outlet Size =				15 in
Invert Elevation =				932.00 ft
Springline EL. =				932.50 ft
H =				2.30 ft
Area Req'd = A =				0.42 sf
Area of Outlet Used				1.23 sf
Diameter Req'd =				15.00 in
Use				15.00 in Dia Outlet

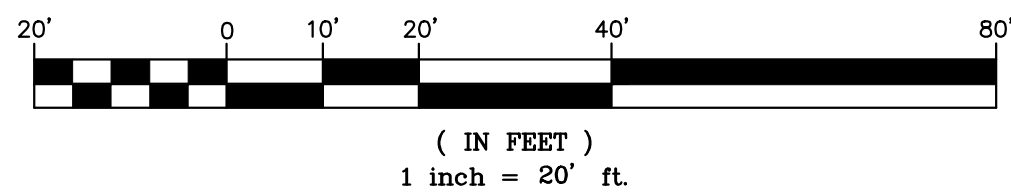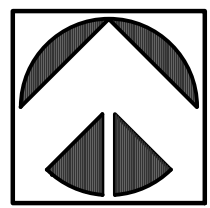

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SECTION 3
TOWN 1 NORTH, RANGE 8 EAST
CITY OF NOVI
OAKLAND COUNTY, MICHIGAN

SCENIC PINES
CLIENT: SINGH DEVELOPMENT, LLC.
7125 ORCHARD LAKE ROAD
BLOOMFIELD HILLS, MICHIGAN 48322
DETENTION BASIN - STORMWATER MANAGEMENT PLAN

DATE: 11-27-2019
REVISIONS
PER CITY 03-24-2020
PER CITY 01-18-2021

OR BY: SDT
CK BY: SDT/MY
P.M. SA
SCALE 0
AS NOTED
JOB NO. 180905
SHEET NO. 23
SHEET 23 OF 38



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1 - GENERAL

1.0 STANDARDS AND DEFINITIONS

1.1 STANDARDS - ALL STANDARDS REFER TO LATEST EDITION UNLESS OTHERWISE NOTED.

1.1.1 ASTM B-864 "STANDARD SPECIFICATION FOR CORRUGATED ALUMINUM BOX CULVERTS" (AASHTO DESIGNATION M-219).

1.1.2 AASHTO STANDARD SPECIFICATION FOR HIGHWAY BRIDGES - SECTION 12 DIVISION 1 - DESIGN.

1.1.3 AASHTO STANDARD SPECIFICATION FOR HIGHWAY BRIDGES - SECTION 26 DIVISION 1 - CONSTRUCTION.

1.2 DEFINITIONS

1.2.1 OWNER - IN THESE SPECIFICATIONS THE WORD "OWNER" SHALL MEAN CONTECH Engineered Solutions, LLC.

1.2.2 ENGINEER - IN THESE SPECIFICATIONS THE WORD "ENGINEER" SHALL MEAN THE ENGINEER OF RECORD OR OWNER'S DESIGNATED ENGINEERING REPRESENTATIVE.

1.2.3 MANUFACTURER - IN THESE SPECIFICATIONS THE WORD "MANUFACTURER" SHALL MEAN CONTECH ENGINEERED SOLUTIONS, LLC 800-338-1122.

1.2.4 CONTRACTOR - IN THESE SPECIFICATIONS THE WORD "CONTRACTOR" SHALL MEAN THE FIRM OR CORPORATION UNDERTAKING THE EXECUTION OF ANY INSTALLATION WORK UNDER THE TERMS OF THESE SPECIFICATIONS.

1.2.5 APPROVED - IN THESE SPECIFICATIONS THE WORD "APPROVED" SHALL REFER TO THE APPROVAL OF THE ENGINEER OR HIS DESIGNATED REPRESENTATIVE.

1.2.6 AS DIRECTED - IN THESE SPECIFICATIONS THE WORDS "AS DIRECTED" SHALL REFER TO THE DIRECTIONS TO THE CONTRACTOR FROM THE OWNER OR HIS DESIGNATED REPRESENTATIVE.

2.0 GENERAL CONDITIONS

2.1 THE CONTRACTOR SHALL FURNISH ALL LABOR, MATERIAL, AND EQUIPMENT AND PERFORM ALL WORK AND SERVICES EXCEPT THOSE SET OUT AND FURNISHED BY THE OWNER, NECESSARY TO COMPLETE IN A SATISFACTORY MANNER THE SITE PREPARATION, EXCAVATION, FILLING, COMPACTION, GRADING AS SHOWN ON THE PLANS AND AS DESCRIBED THEREIN. THIS WORK SHALL CONSIST OF ALL MOBILIZATION CLEARING AND GRADING, GRUBBING, STRIPPING, REMOVAL OF EXISTING MATERIAL UNLESS OTHERWISE STATED, PREPARATION OF THE LAND TO BE FILLED, FILLING OF THE LAND, SPREADING AND COMPACTION OF THE FILL, AND ALL SUBSIDIARY WORK NECESSARY TO COMPLETE THE GRADING OF THE CUT AND FILL AREAS TO CONFORM WITH THE LINES, GRADES, SLOPES, AND SPECIFICATIONS. THIS WORK IS TO BE ACCOMPLISHED UNDER THE OBSERVATION OF THE OWNER OR HIS DESIGNATED REPRESENTATIVE.

2.2 PRIOR TO BIDDING THE WORK, THE CONTRACTOR SHALL EXAMINE, INVESTIGATE AND INSPECT THE CONSTRUCTION SITE AS TO THE NATURE AND LOCATION OF THE WORK, AND THE GENERAL AND LOCAL CONDITIONS AT THE CONSTRUCTION SITE, INCLUDING WITHOUT LIMITATION, THE CHARACTER OF SURFACE OR SUBSURFACE CONDITIONS AND OBSTACLES TO BE ENCOUNTERED ON AND AROUND THE CONSTRUCTION SITE AND SHALL MAKE SUCH ADDITIONAL INVESTIGATION AS HE MAY DEEM NECESSARY FOR THE PLANNING AND PROPER EXECUTION OF THE WORK.

IF CONDITIONS OTHER THAN THOSE INDICATED ARE DISCOVERED BY THE CONTRACTOR, THE OWNER SHALL BE NOTIFIED IMMEDIATELY. THE MATERIAL WHICH THE CONTRACTOR BELIEVES TO BE A CHANGED CONDITION SHALL NOT BE DISTURBED TO THAT THE OWNER CAN INVESTIGATE THE CONDITION.

2.3 THE CONSTRUCTION SHALL BE PERFORMED UNDER THE DIRECTION OF THE ENGINEER.

2.4 ALL ASPECTS OF THE STRUCTURE DESIGN AND SITE LAYOUT INCLUDING FOUNDATIONS, BACKFILL, END TREATMENTS AND NECESSARY SCOUR CONSIDERATION SHALL BE PERFORMED BY THE ENGINEER.

ANY INSTALLATION GUIDANCE PROVIDED HEREIN SHALL BE ENDORSED BY THE ENGINEER OR SUPERSEDED BY THE ENGINEER'S PLANS AND SPECIFICATIONS.

BRIDGE PLAN
TYPE VI CROWN RIBS (TYP.) @ 9" O.C.
TYPE VI HAUNCH RIBS (TYP.) @ 18" O.C.

PRELIMINARY
NOT FOR CONSTRUCTION

ALBC #82 - 25'-2" X 6'-2"
SCENIC PINES ESTATES SUBDIVISION
WETLAND CROSSING ON PEMBINE ROAD
NOVI, MI

Project No: 180905-004 Date: 12/13/2019
Designed: J.S.B. Drawn:
Checked: Approved:
Sheet No: 1 OF 8

CONTECH
ENGINEERED SOLUTIONS
9033 Centre Pointe Dr., Suite 400, West Chester, OH 45390
800-338-1122 513-445-7000 513-445-7099 FAX

PROPOSAL
DRAWING

6' 0" ON CENTER

1 1/8" x 1" RAILS

2" x 2" POSTS

5/8" x 5/8" PICKETS

3.792" SPACING

1 1/8" x 1" RAIL

36" 42" 48" 60"

23 1/4" 29 1/4" 35 1/4" 47 1/4"

2"

Post Size

36" Tall	2" x 2" x 5 1/2"
42" Tall	2" x 2" x 6"
48" Tall	2" x 2" x 6 1/2"
60" Tall	2" x 2" x 7 1/2"

CourtYard® Aluminum Fence

Scale: 3/32" = 1"
Date: 8/08/06

Approved By: F.S.B.
Revised:

Drawn By: J.D.S.
Revised:

0230 (3-Rail Flat Top)

As Shown: 6" x 48" 0230
Drawing Number: 0230

COURTYARD
MANUFACTURING & FENCE SYSTEMS




ALUMINUM FENCE DETAIL
NO SCALE

SCENIC PINES

SINGLE FAMILY RESIDENTIAL

STORM WATER MANAGEMENT PLAN

PEMBINE ROAD, CITY OF NOVI, OAKLAND COUNTY

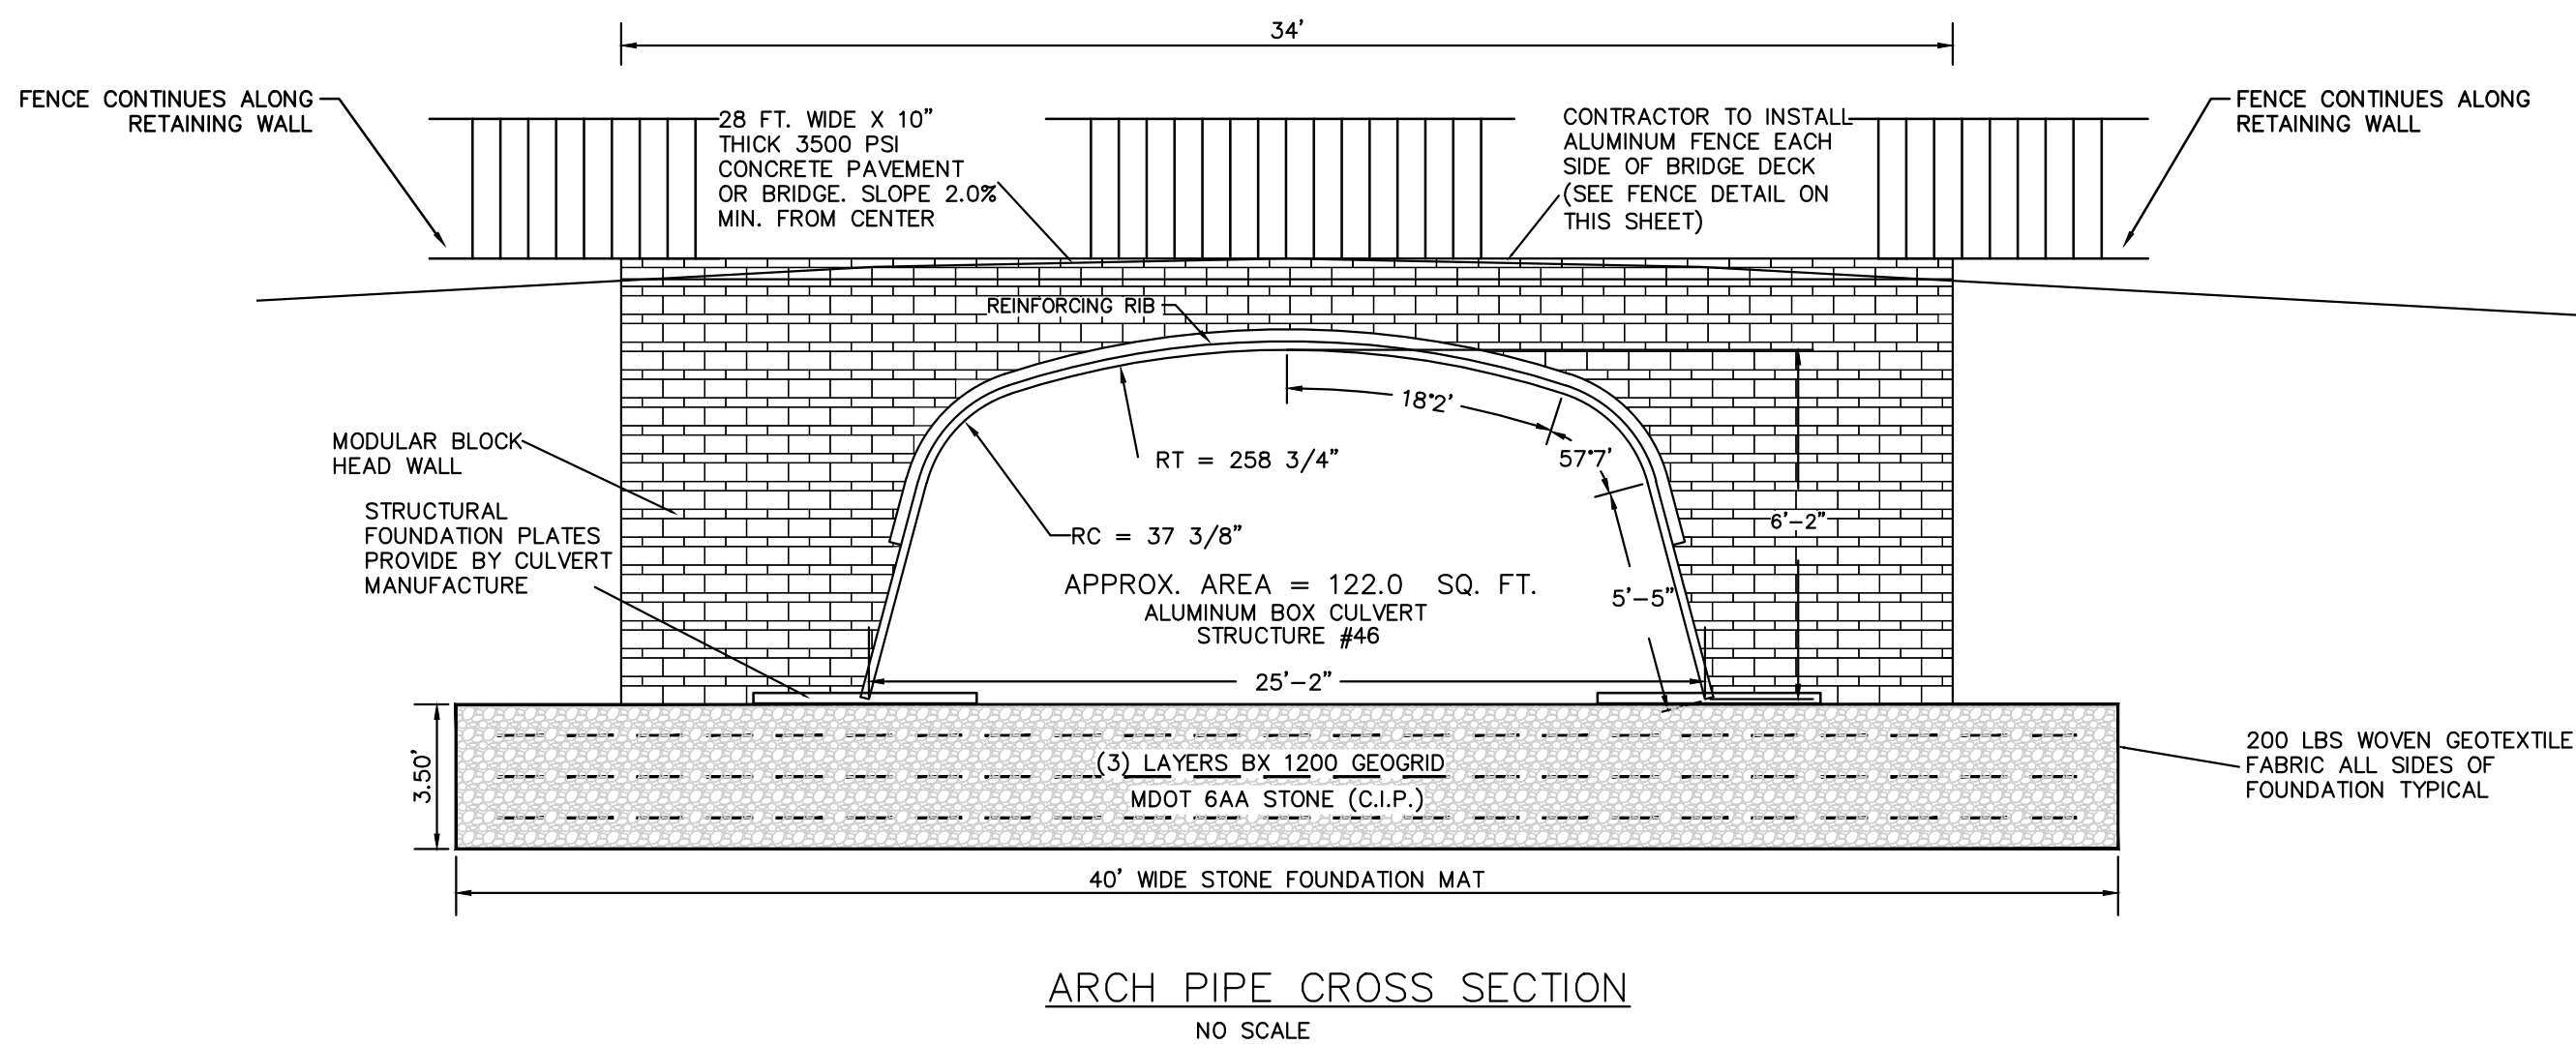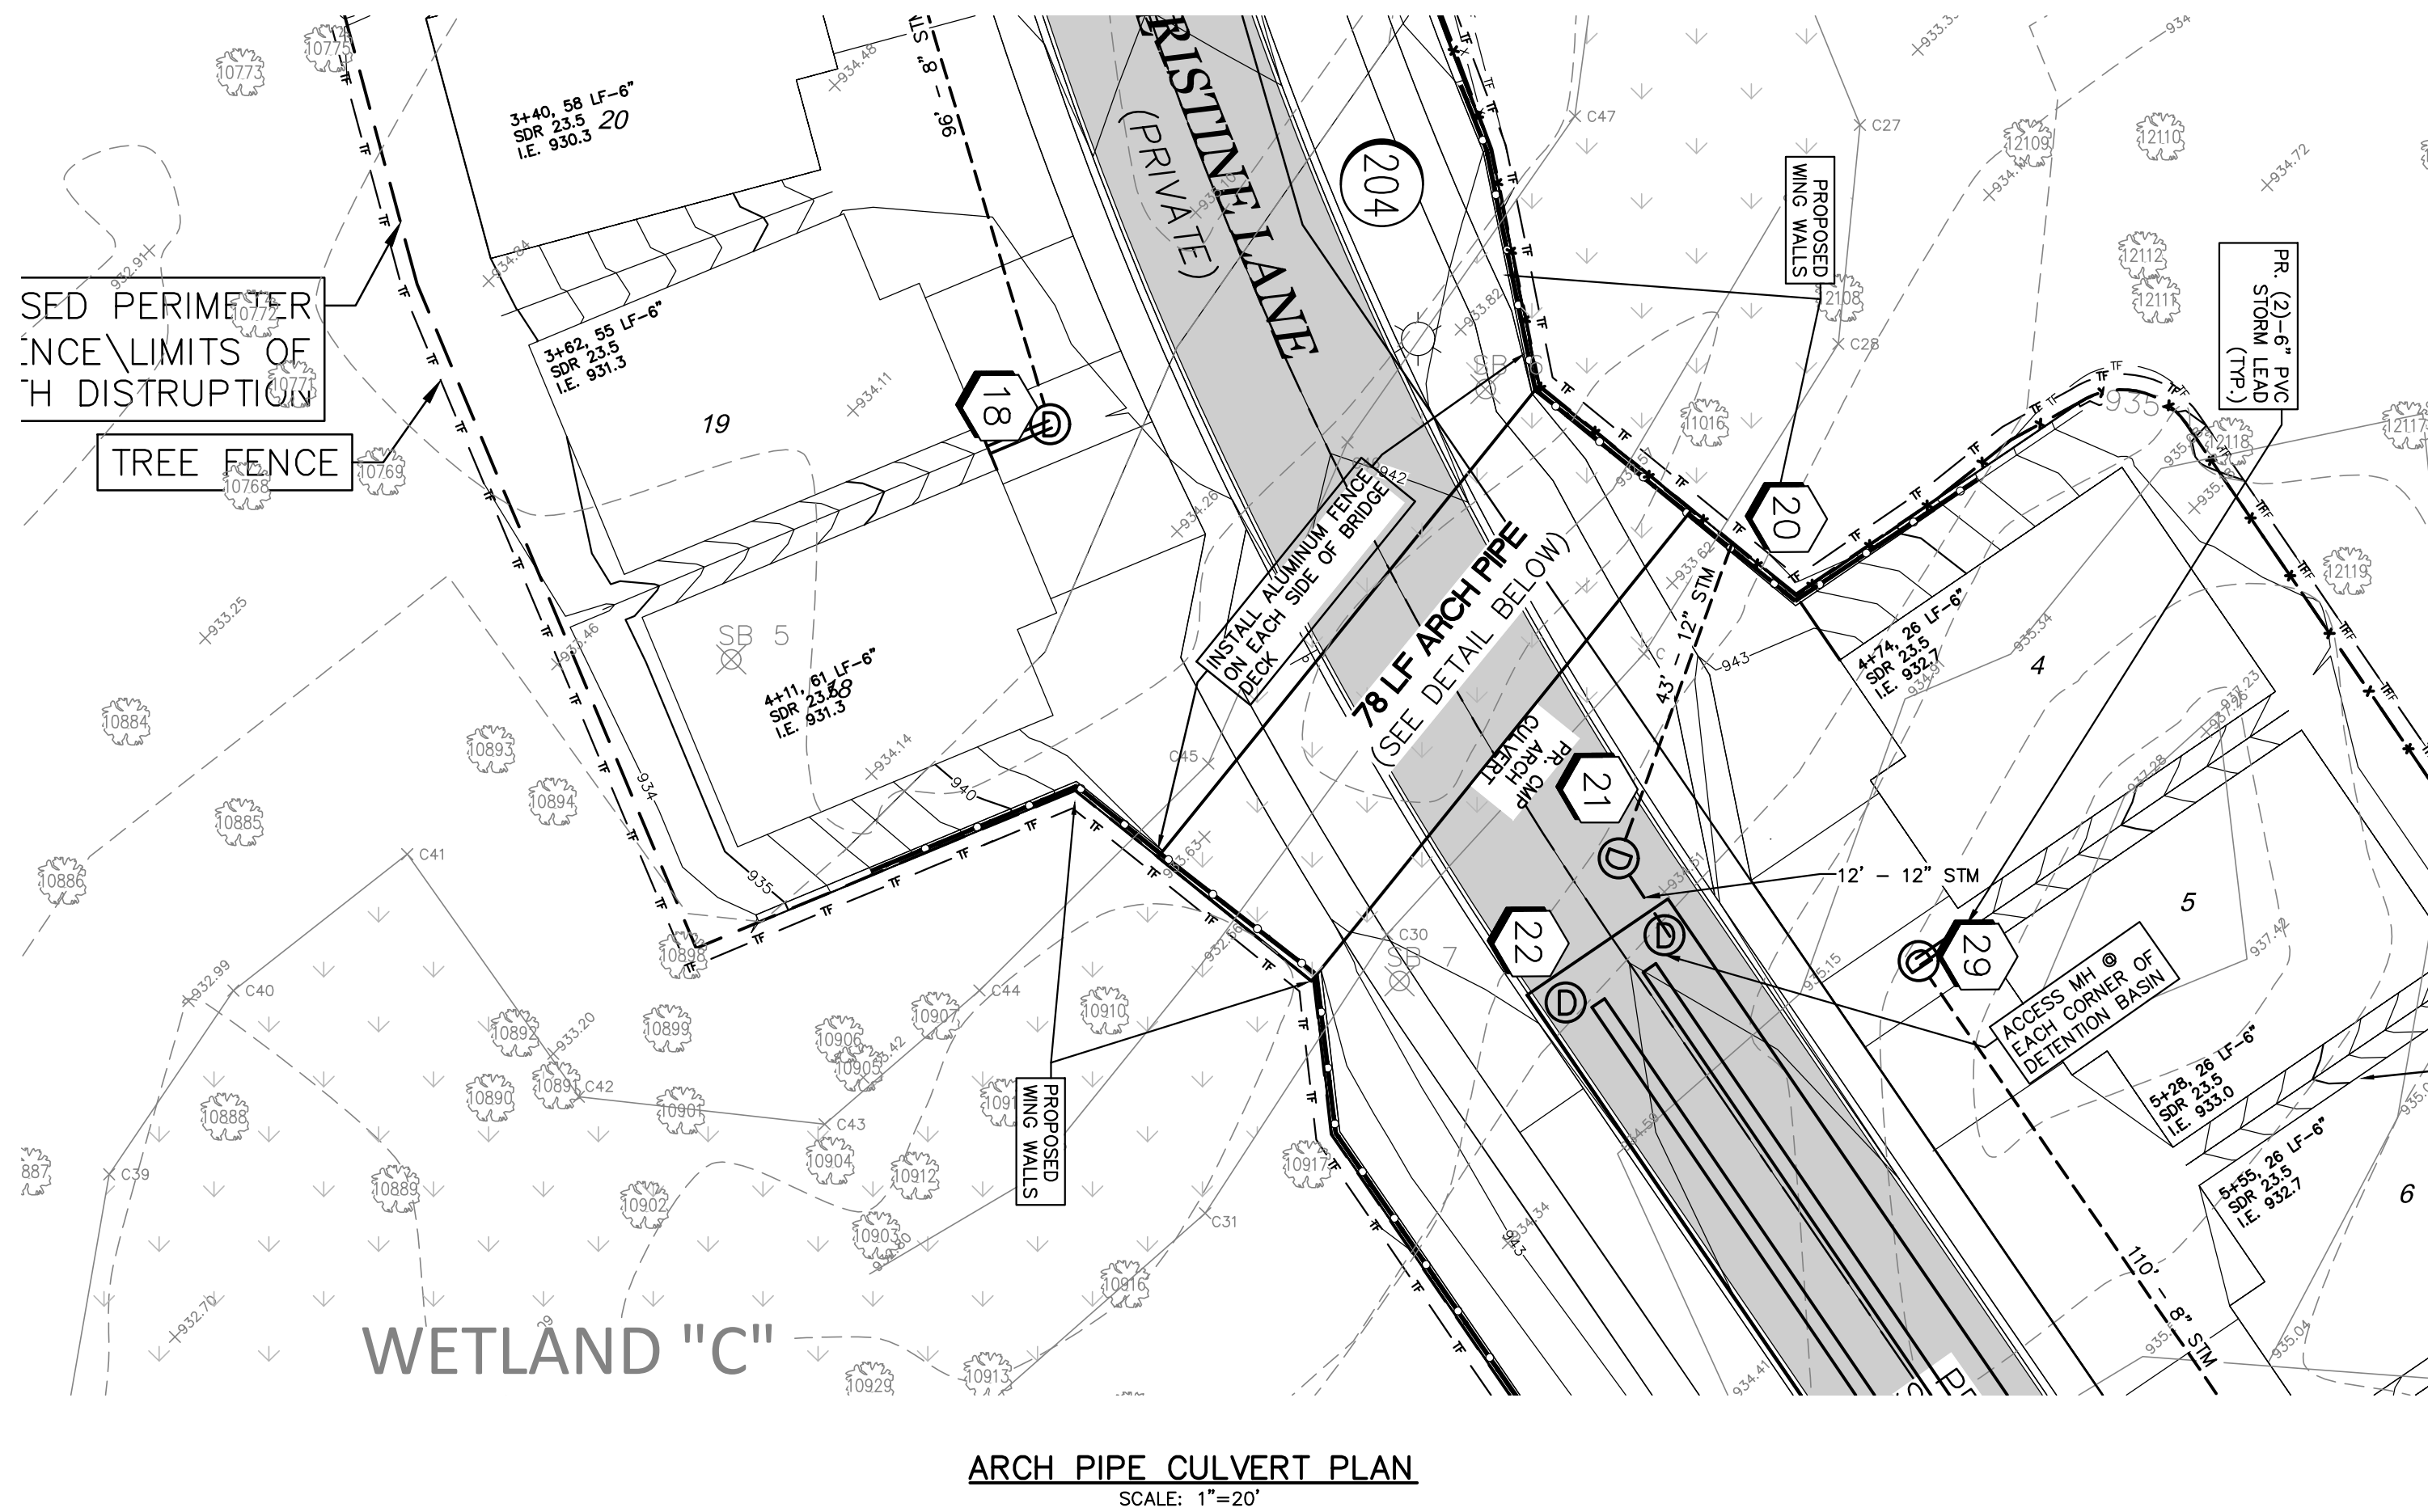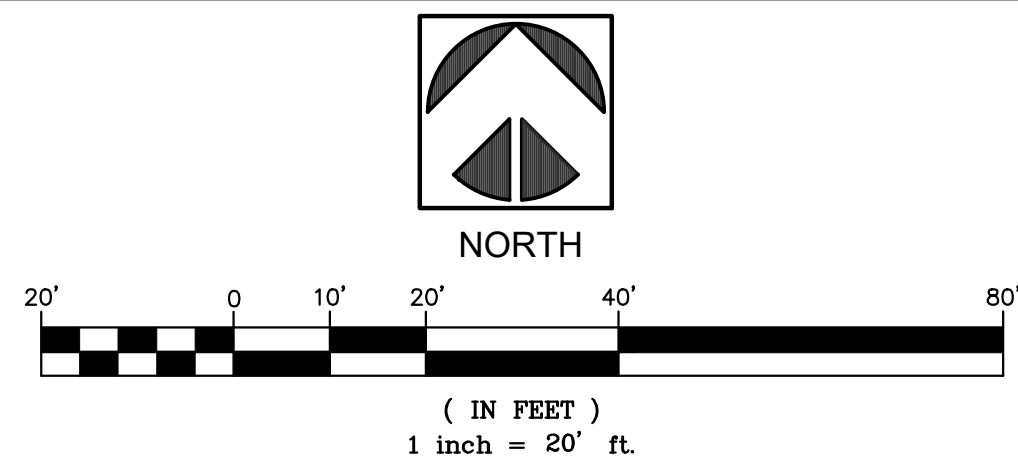

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The UMLOR Group

LAND DEVELOPMENT SERVICES

SECTION 3
TOWN 1 NORTH, RANGE 8 EAST
CITY OF NOVI
OAKLAND COUNTY, MICHIGAN

CLIENT: SCENIC PINES
SINGH DEVELOPMENT, LLC.
7125 ORCHARD LAKE ROAD
BLOOMFIELD HILLS, MICHIGAN 48322

ARCH PIPE BRIDGE PLAN AND DETAILS

DATE: 11-27-2019





REVISIONS

PER CITY 03-24-2020

PER CITY 05-14-2020

PER CITY 01-18-2021

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CK BY: SDT/MY
P.M. SA
SCALE 0
AS NOTED
JOB NO. 180905
SHEET NO. 24
SHEET 24 OF 38

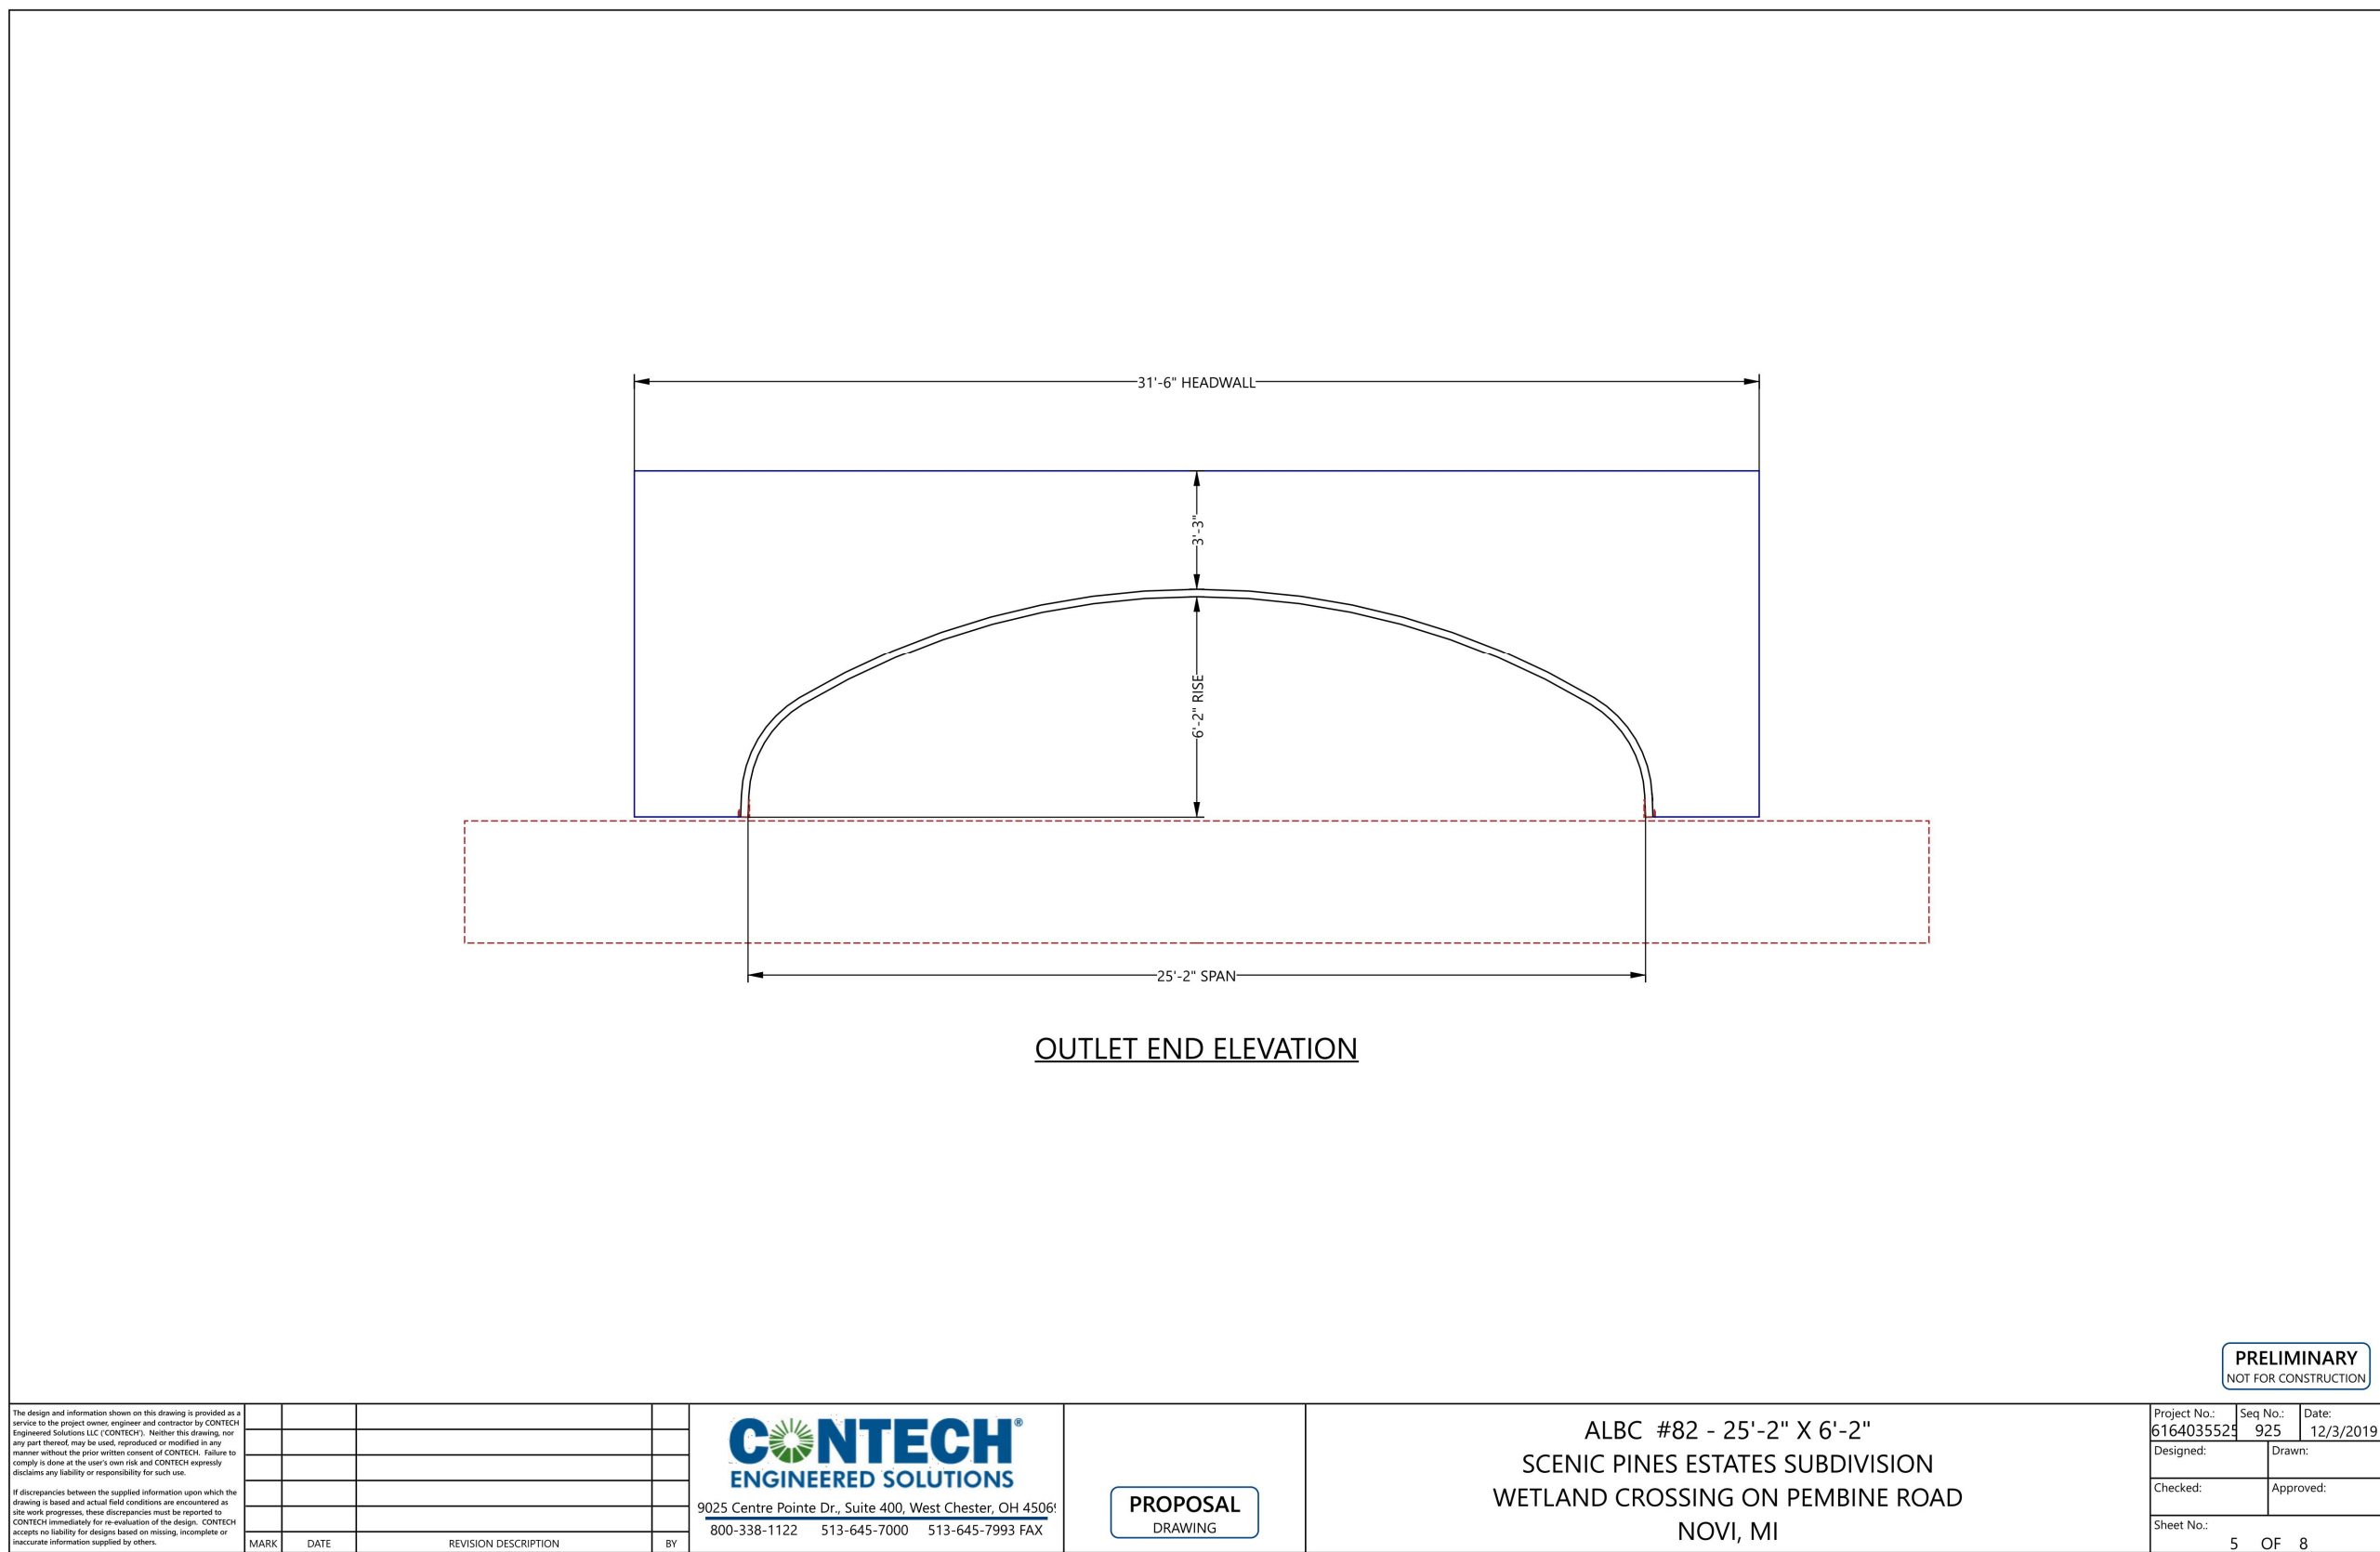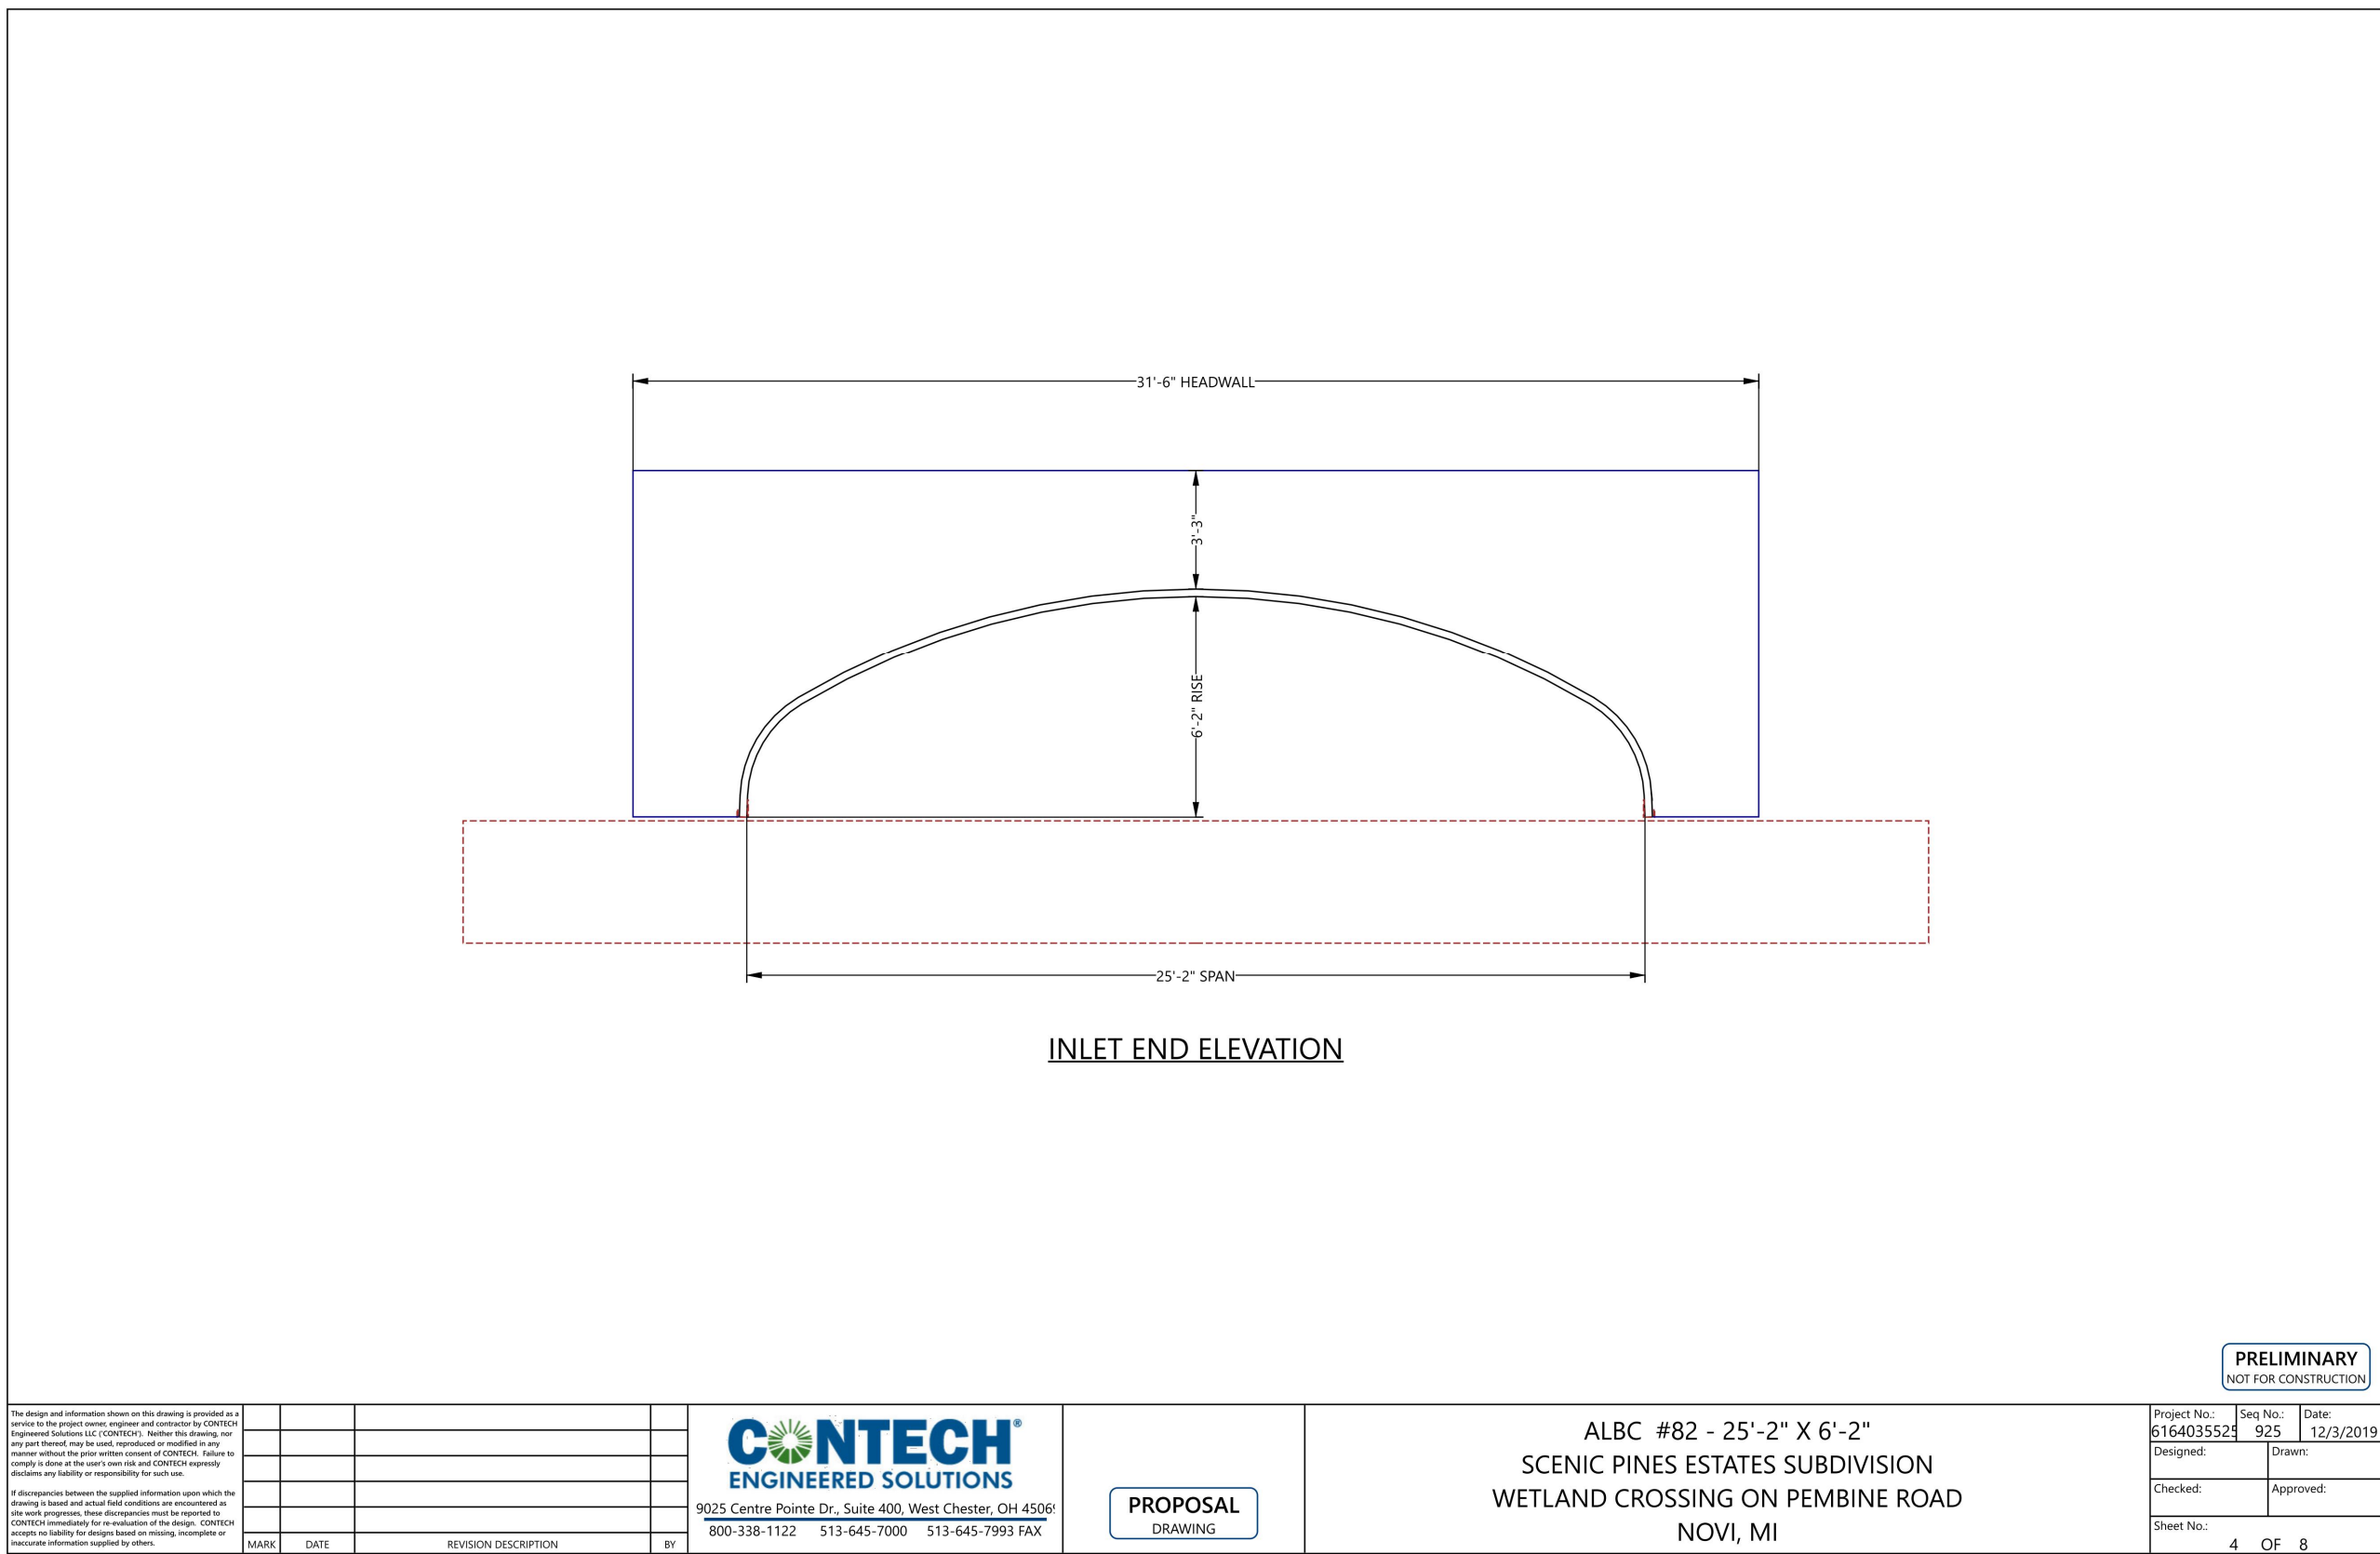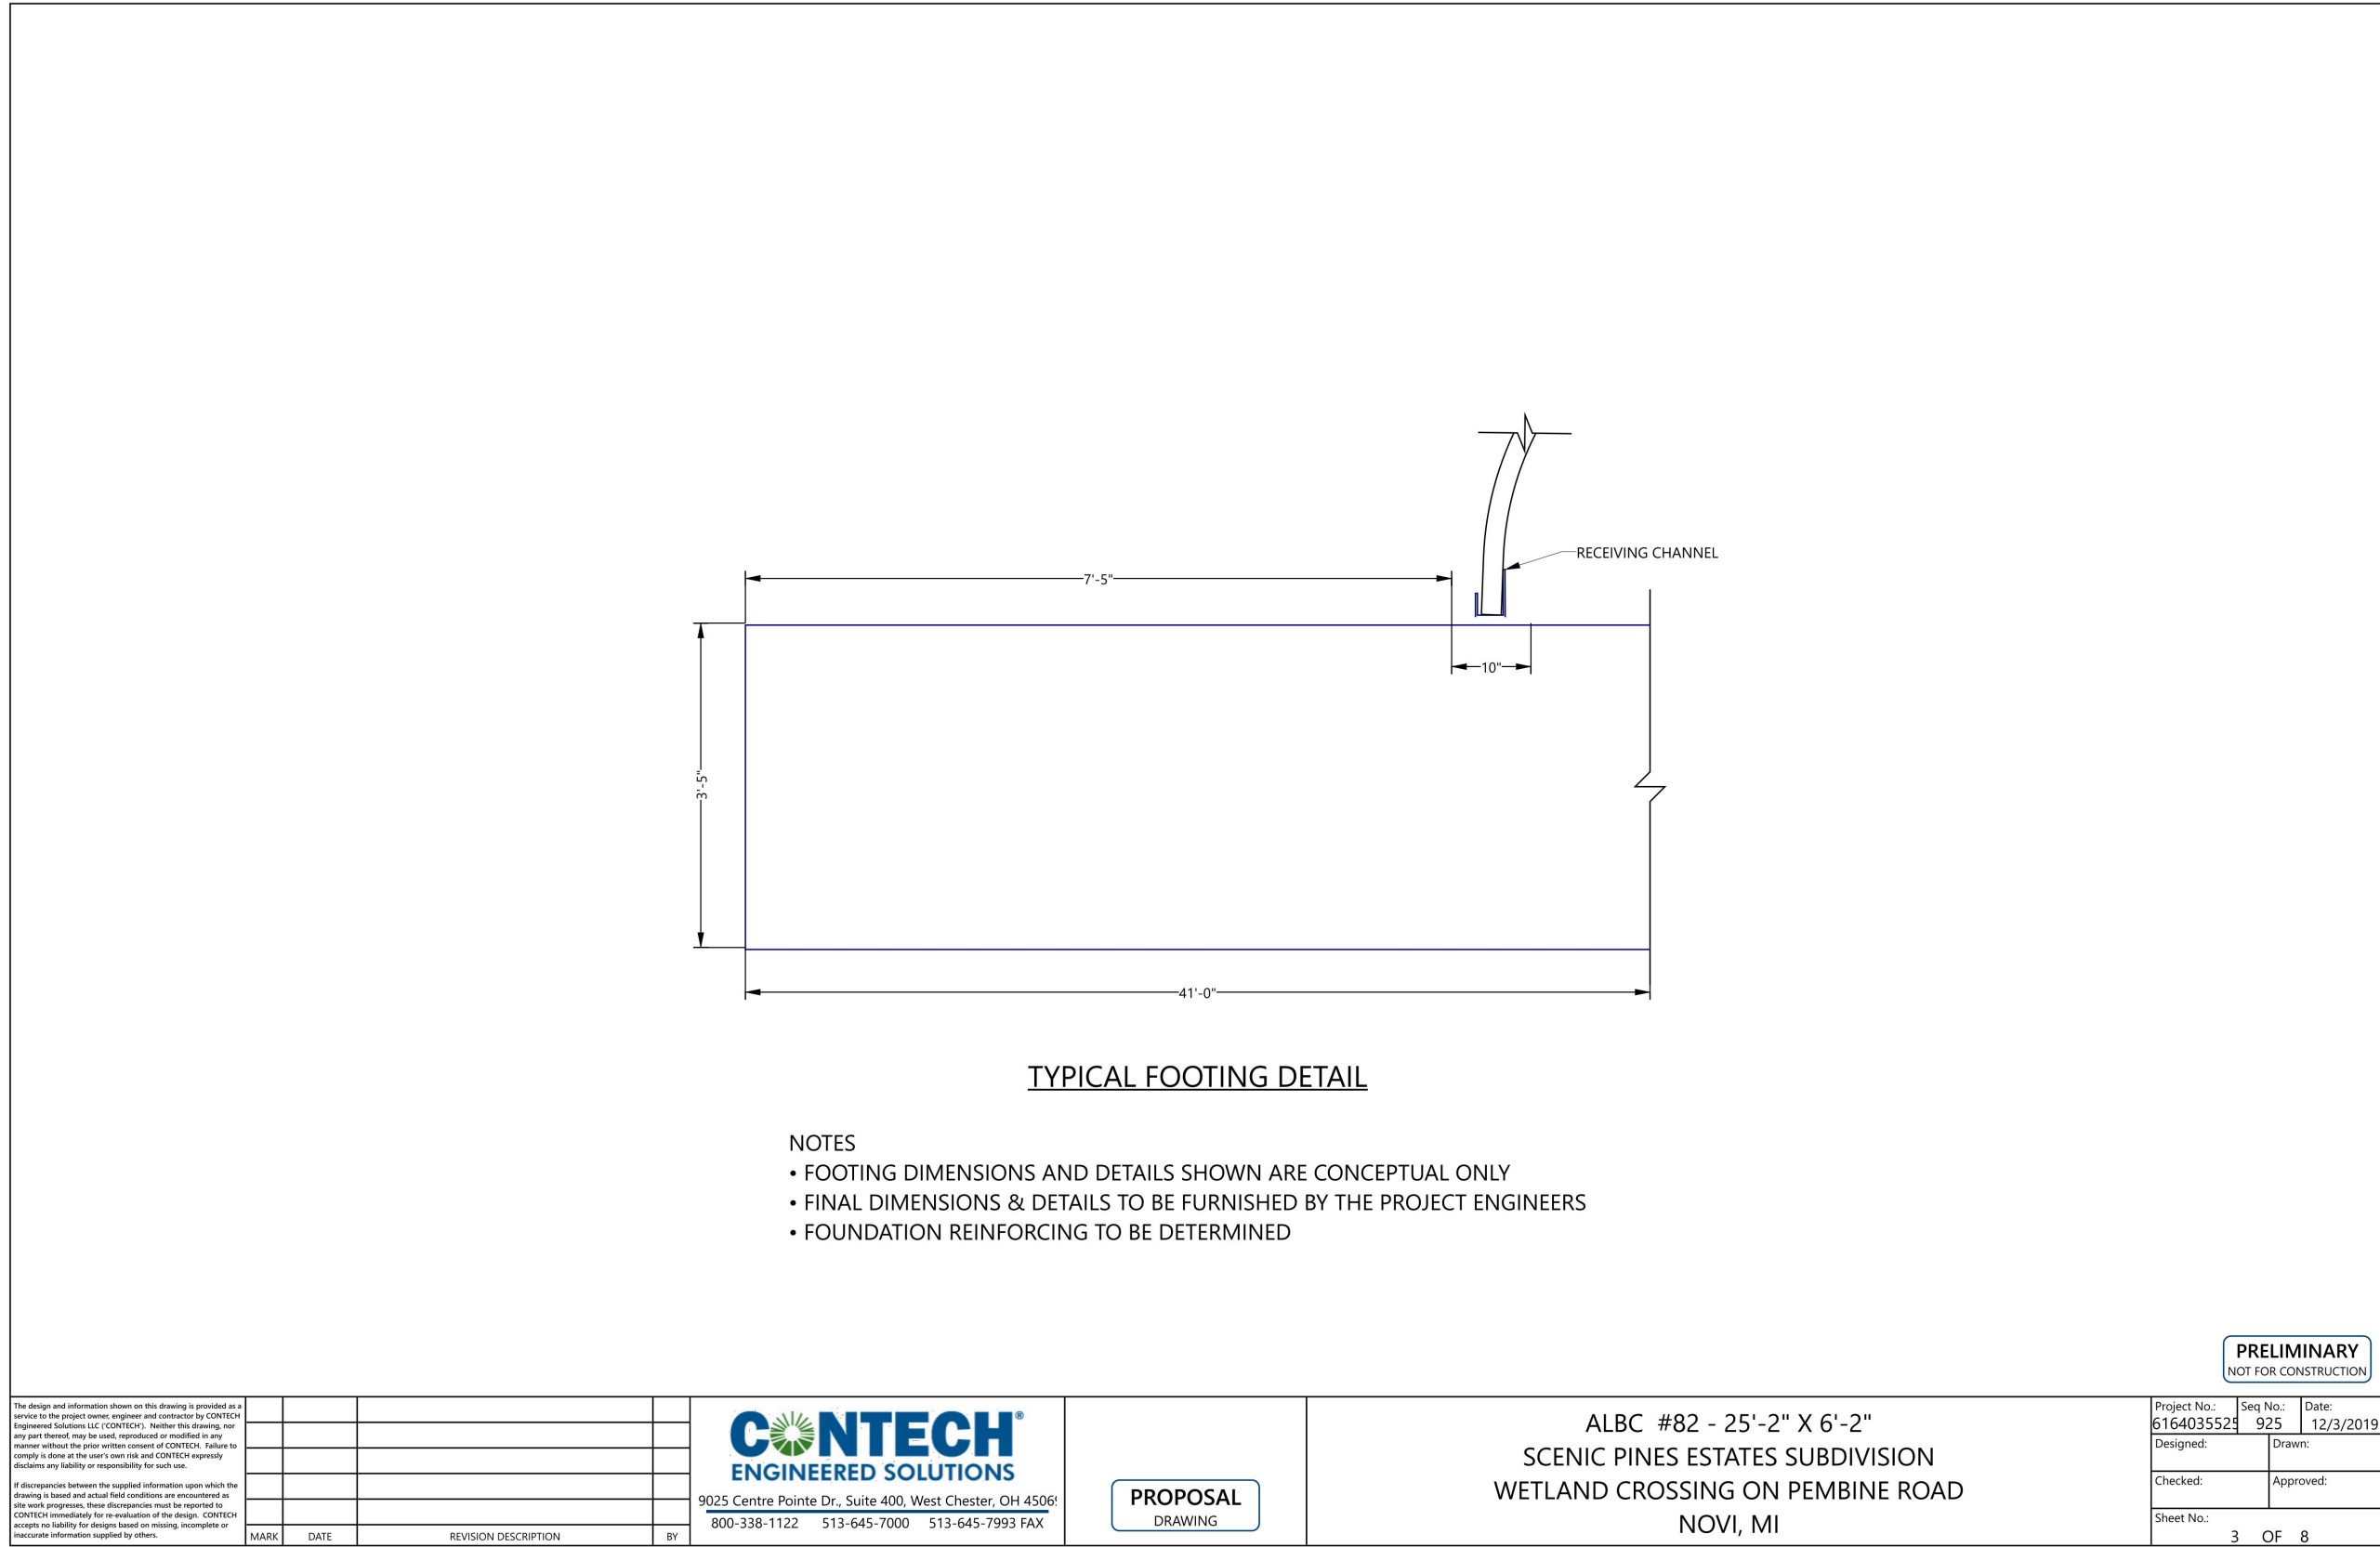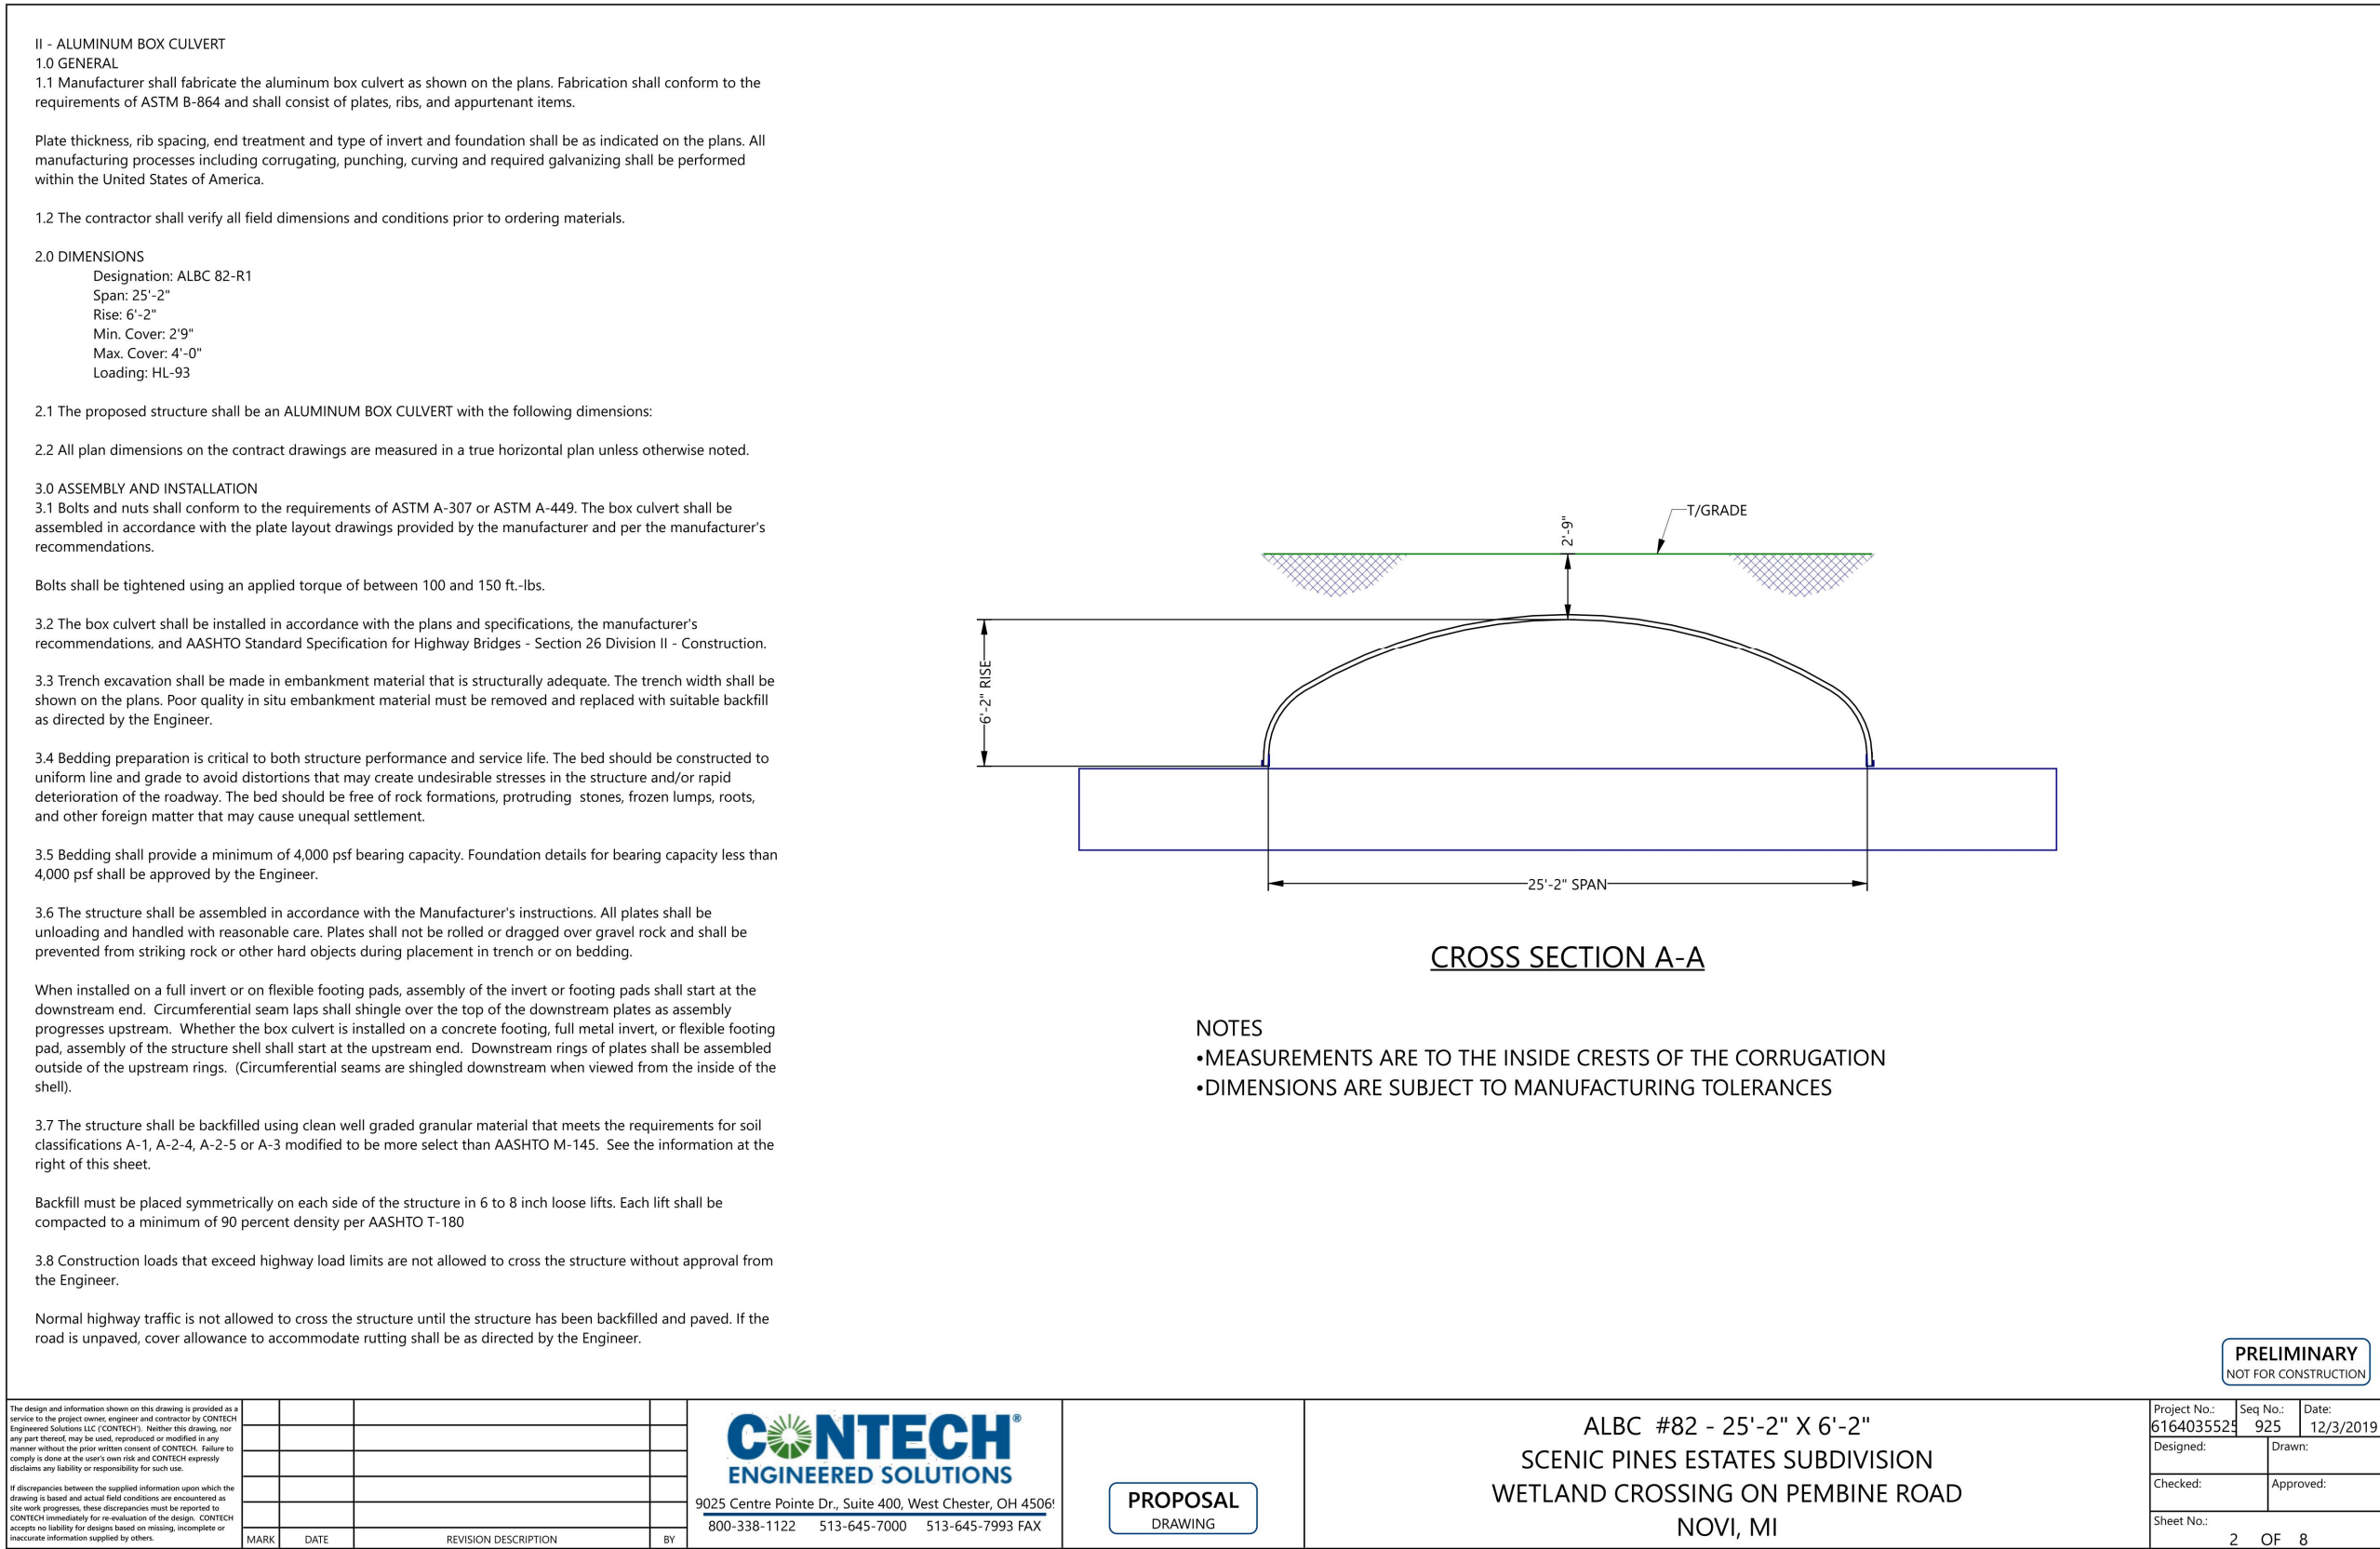

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OAKLAND COUNTY, MICHIGAN

CLIENT:
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SINGH DEVELOPMENT, LLC.
7125 ORCHARD LAKE ROAD
BLOOMFIELD HILLS, MICHIGAN 48322

ARCH PIPE DETAILS

DATE: 11-27-2019

REVISIONS
PER CITY 03-24-2020
PER CITY 05-14-2020
PER CITY 01-18-2021

OR BY: SDT
CK BY: SDT/MY
P.M. SA
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SHEET NO. 25
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SCENIC PINES

SINGLE FAMILY RESIDENTIAL
STORM WATER MANAGEMENT PLAN
PEMBINE ROAD, CITY OF NOVI, OAKLAND COUNTY

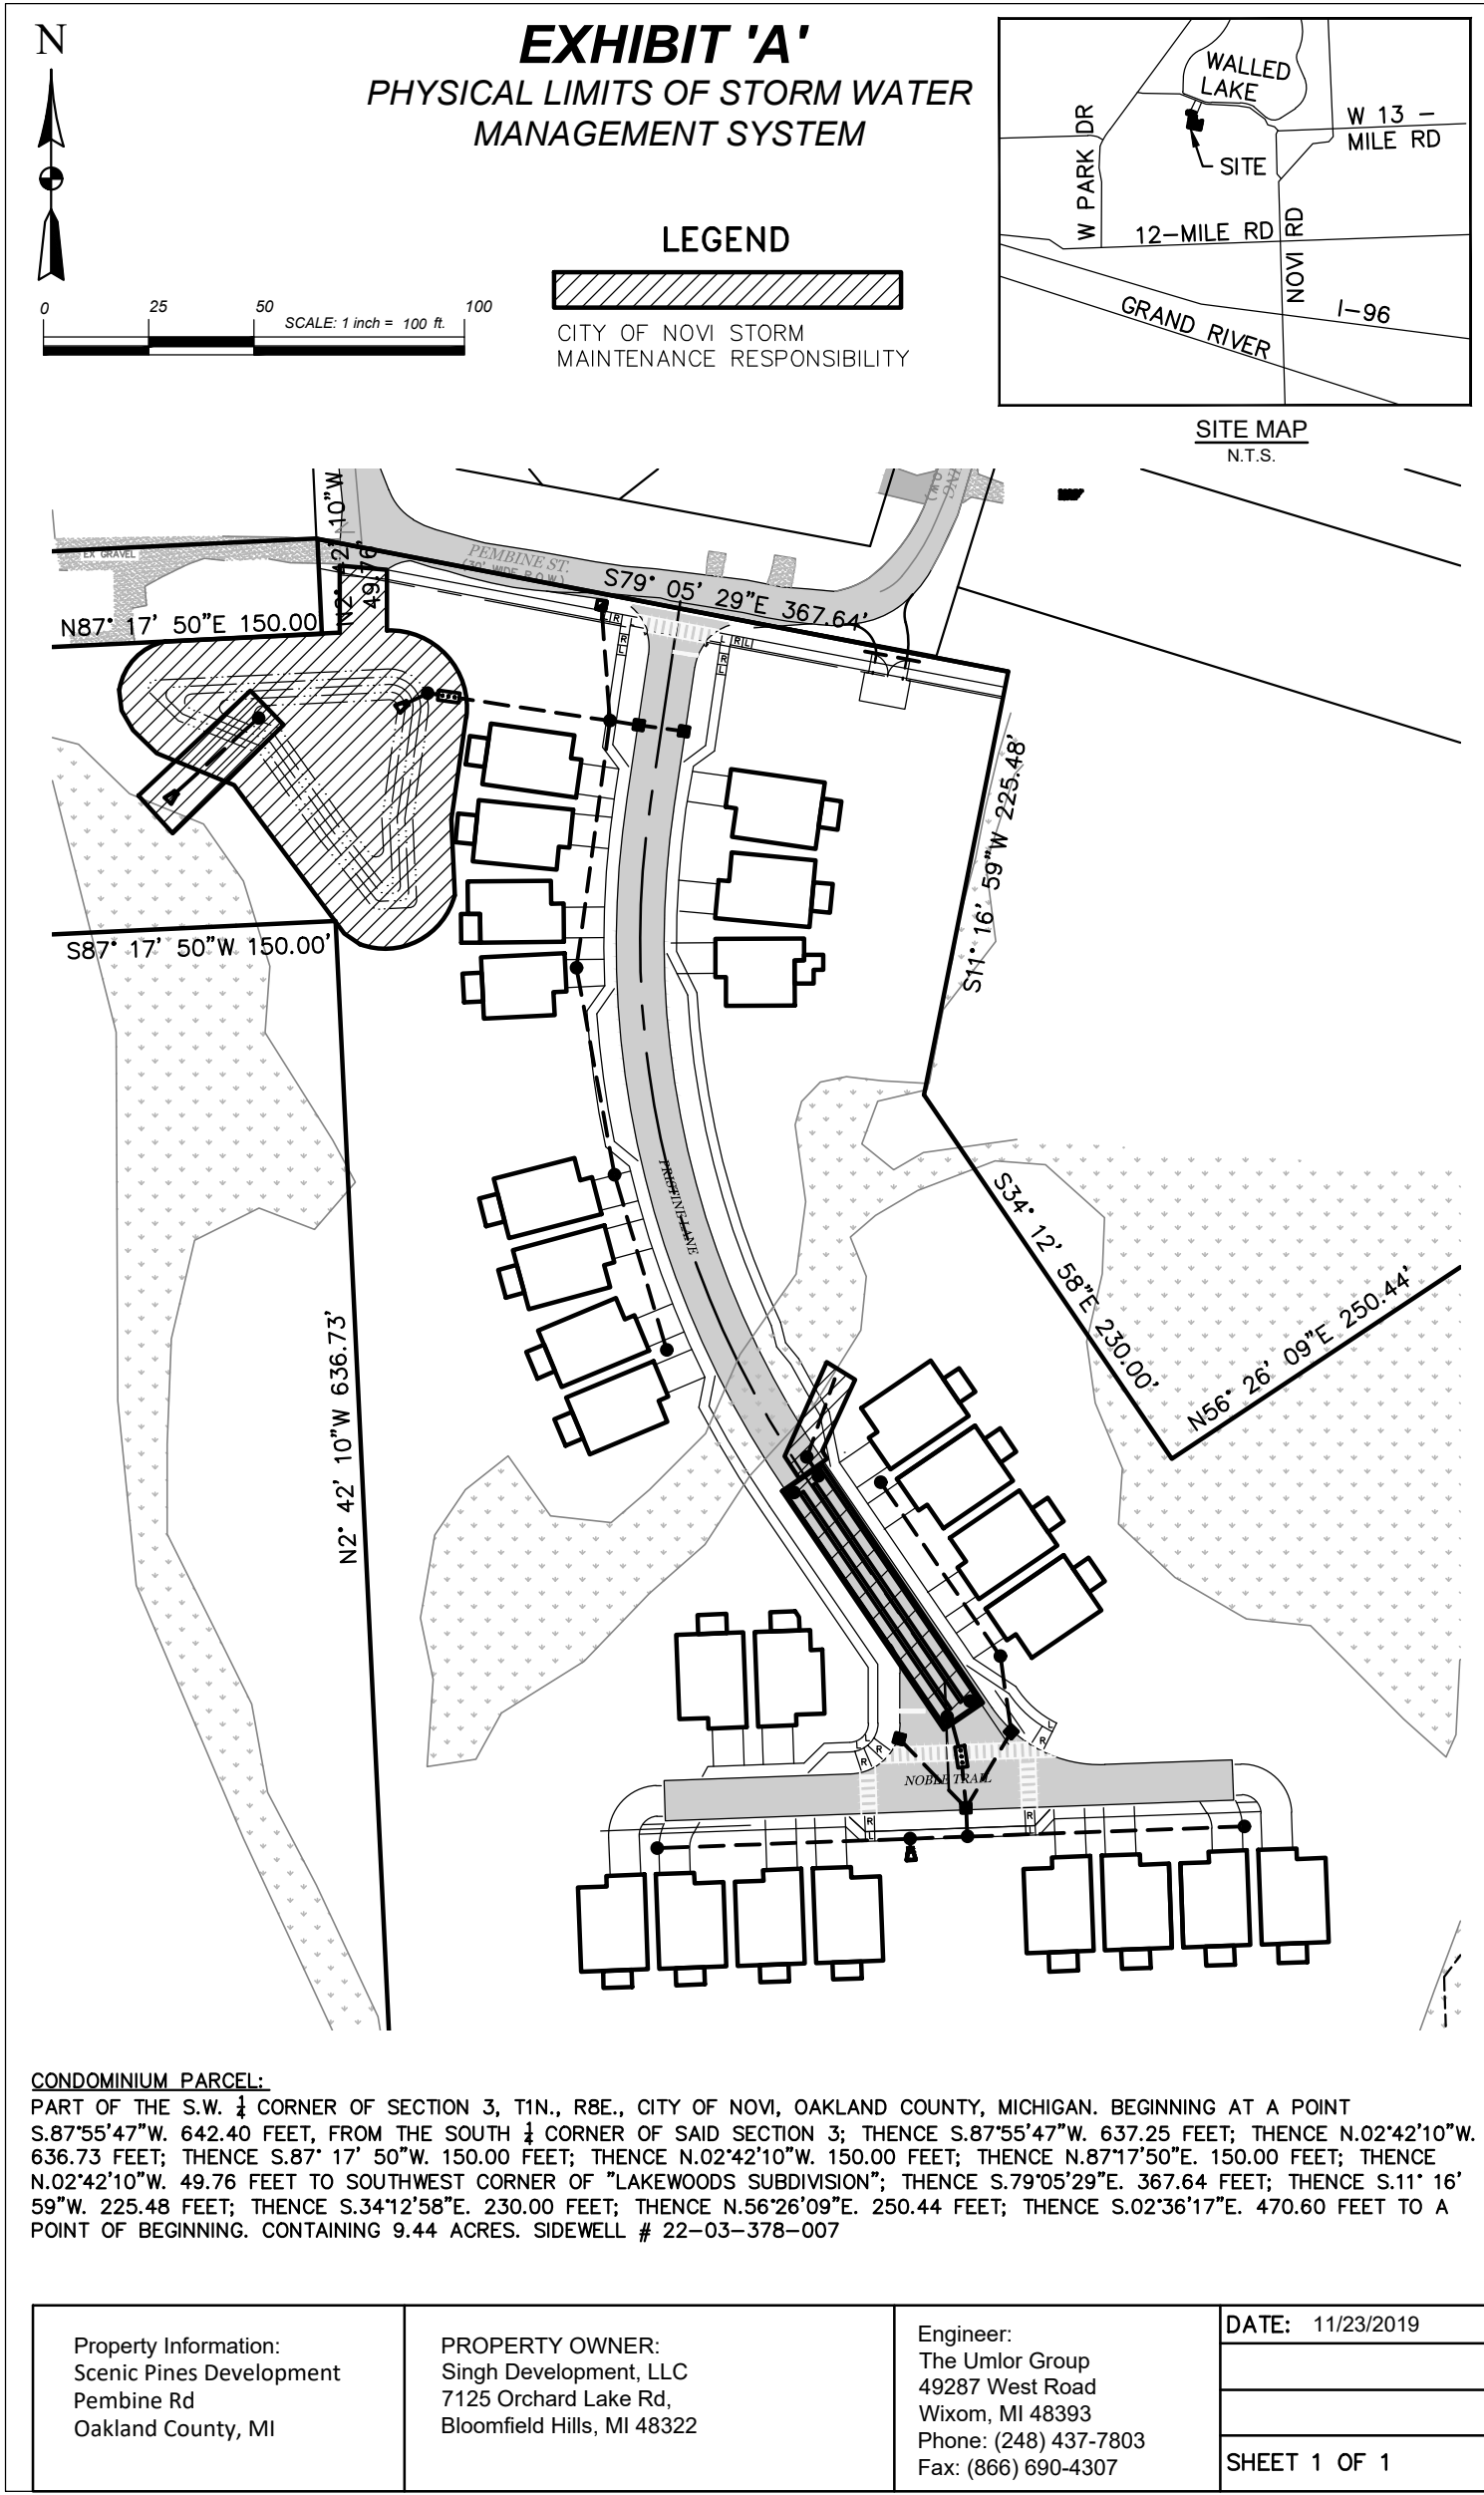


EXHIBIT B - STORM WATER MANAGEMENT SYSTEM LONG-TERM MAINTENANCE PLAN

- CITY OF NOVI DPS PERMIT NO.:
CITY OF NOVI DPS PLAN REVIEW NO.:
- A. Physical Limits of the Storm Water Maintenance System**
The storm water management system (SWMS) subject to this long-term maintenance plan (Plan) is depicted on Exhibit A to the permit and includes without limitation the storm sewers, catch basins, manholes, inlets, water quality structures, swales, buffer strip, spillways, forebay, detention basin, subsurface detention, outlet control structure and the outlet pipe that conveys flow from the detention basin to the natural drainage course to the XXXX. For the purposes of this plan, this storm water management system (SWMS) and all of its components as shown in Exhibit A is referred to as "Scenic Pines Final Planned Development", Pembine Road, City of Novi, Oakland County MI.
- B. Time Frame for Long-Term Maintenance Responsibility**
Singh Development, LLC is responsible for maintaining the "Scenic Pines Final Planned Development", Pembine Road, City of Novi, Oakland County MI., including complying with applicable requirements of the local or City of Novi soil erosion and sedimentation control program until City of Novi releases the construction permit. Long-term maintenance responsibility for the "Scenic Pines Final Planned Development", Pembine Road, City of Novi, Oakland County MI., commences when defined by the maintenance permit issued by the County. Long-term maintenance continues in perpetuity.
- C. Manner of Insuring Maintenance Responsibility**
City of Novi has assumed responsibility for long-term maintenance of "Scenic Pines Final Planned Development", Pembine Road, City of Novi, Oakland County MI. The resolution by which the City of Novi has assumed maintenance responsibility is attached to the permit as Exhibit C. Singh Development, LLC through a maintenance agreement with Canton Township, has agreed to perform the maintenance activities required by this plan. City of Novi retains the right to enter the property and perform the necessary maintenance of the "Scenic Pines Final Planned Development", Pembine Road, City of Novi, Oakland County MI. If Singh Development, LLC fails to perform the required maintenance activities. To ensure that the "Scenic Pines Final Planned Development", Pembine Road, City of Novi, Oakland County MI. is maintained in perpetuity, the map of the physical limits of the storm water management system (Exhibit A), this plan (Exhibit B), the resolution attached as Exhibit C, and the maintenance agreement between the City of Novi and the property owner(s) will be recorded with the Wayne County Register of Deeds. Upon recording, a copy of the recorded documents will be provided to the County.
- D. Long-Term Maintenance Plan and Schedule**
Table 1 identifies the maintenance activities to be performed, organized by category (monitoring/inspections, preventative maintenance and remedial actions). While performing maintenance, chemicals should not be applied to the forebay, detention basin, buffer strip or watercourses. Table 1 also identifies site-specific work needed to ensure that the storm water management system functions properly as designed.

TABLE 1 STORM WATER MANAGEMENT SYSTEM LONG-TERM MAINTENANCE SCHEDULE									
MAINTENANCE ACTIVITIES	SYSTEM COMPONENTS								FREQUENCY
	Catch basin, inlets & Storm Sewers	Channels & Vegetated Swales	Inlets to Pretreatment Systems	Subsurface Detention Basins	Open Detention Basins & Retention Basins	Flow Restrictors, Overflow Structures & Outlet Pipes	Emergency Spillways	Riprap	
Monitoring /Inspection									
Inspect for sediment accumulation **/clogging of stone filter	X	X	X	X	X	X	X	X	Annually
Inspect for floatables, dead vegetation and debris	X	X	X	X	X	X	X	X	Annually and after major events
Inspect for erosion and integrity of bank and berms	X	X	X	X	X	X	X	X	Annually and after major events
Inspect all components during wet weather and compare to as-built plans	X	X	X	X	X	X	X	X	Annually
Monitoring planting/vegetation	X	X	X	X	X	X	X	X	2 times per year
Ensure means of access for maintenance remain clear/open	X	X	X	X	X	X	X	X	Annually
Preventative Maintenance									
Mowing		X	X	X	X	X			Up to 2 times/year, select areas only*
Remove accumulated sediment	X	X	X	X	X	X	X	X	As needed**
Remove floatables, dead vegetation and debris	X	X	X	X	X	X	X	X	As needed
Replace or wash/reuse stone riser filters					X	X	X		Every 3 years; more frequently as needed***
Remove invasive plant species	X	X	X	X				X	Annually
As Specified (e.g. recommendations by Manufacture)								X	As needed
Remedial Actions									
Repair/stabilize areas of erosion		X	X	X	X	X	X	X	As needed
Replaced dead plantings, bushes, trees		X	X	X	X				As needed
Reseed bare areas		X	X	X	X	X			As needed
Structural repairs	X	X	X	X	X	X	X	X	As needed
Make adjustments/repairs to ensure proper functioning	X	X	X	X	X	X	X	X	As needed

Notes:
*Not to exceed the length allowed by local community ordinance.
**Forebays, open detention basins, and retention basin to be cleaned whenever sediment accumulates to a depth of 6-12 inches or if sediment resuspension is observed.
***Replace stone if it cannot be adequately cleaned.

Property Information: Scenic Pines Development Pembine Rd Oakland County, MI	PROPERTY OWNER: Singh Development, LLC 7125 Orchard Lake Rd. Bloomfield Hills, MI 48322	Engineer: The Umlor Group 49287 West Road Wixom, MI 48393 Phone: (248) 437-7803 Fax: (866) 690-4307	DATE: 11/23/2019
			SHEET 1 OF 1

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CITY OF NOVI
OAKLAND COUNTY, MICHIGAN

SCENIC PINES
SINGH DEVELOPMENT, LLC.
7125 ORCHARD LAKE ROAD
BLOOMFIELD HILLS, MICHIGAN 48322
STORM WATER MAINTENANCE EXHIBIT


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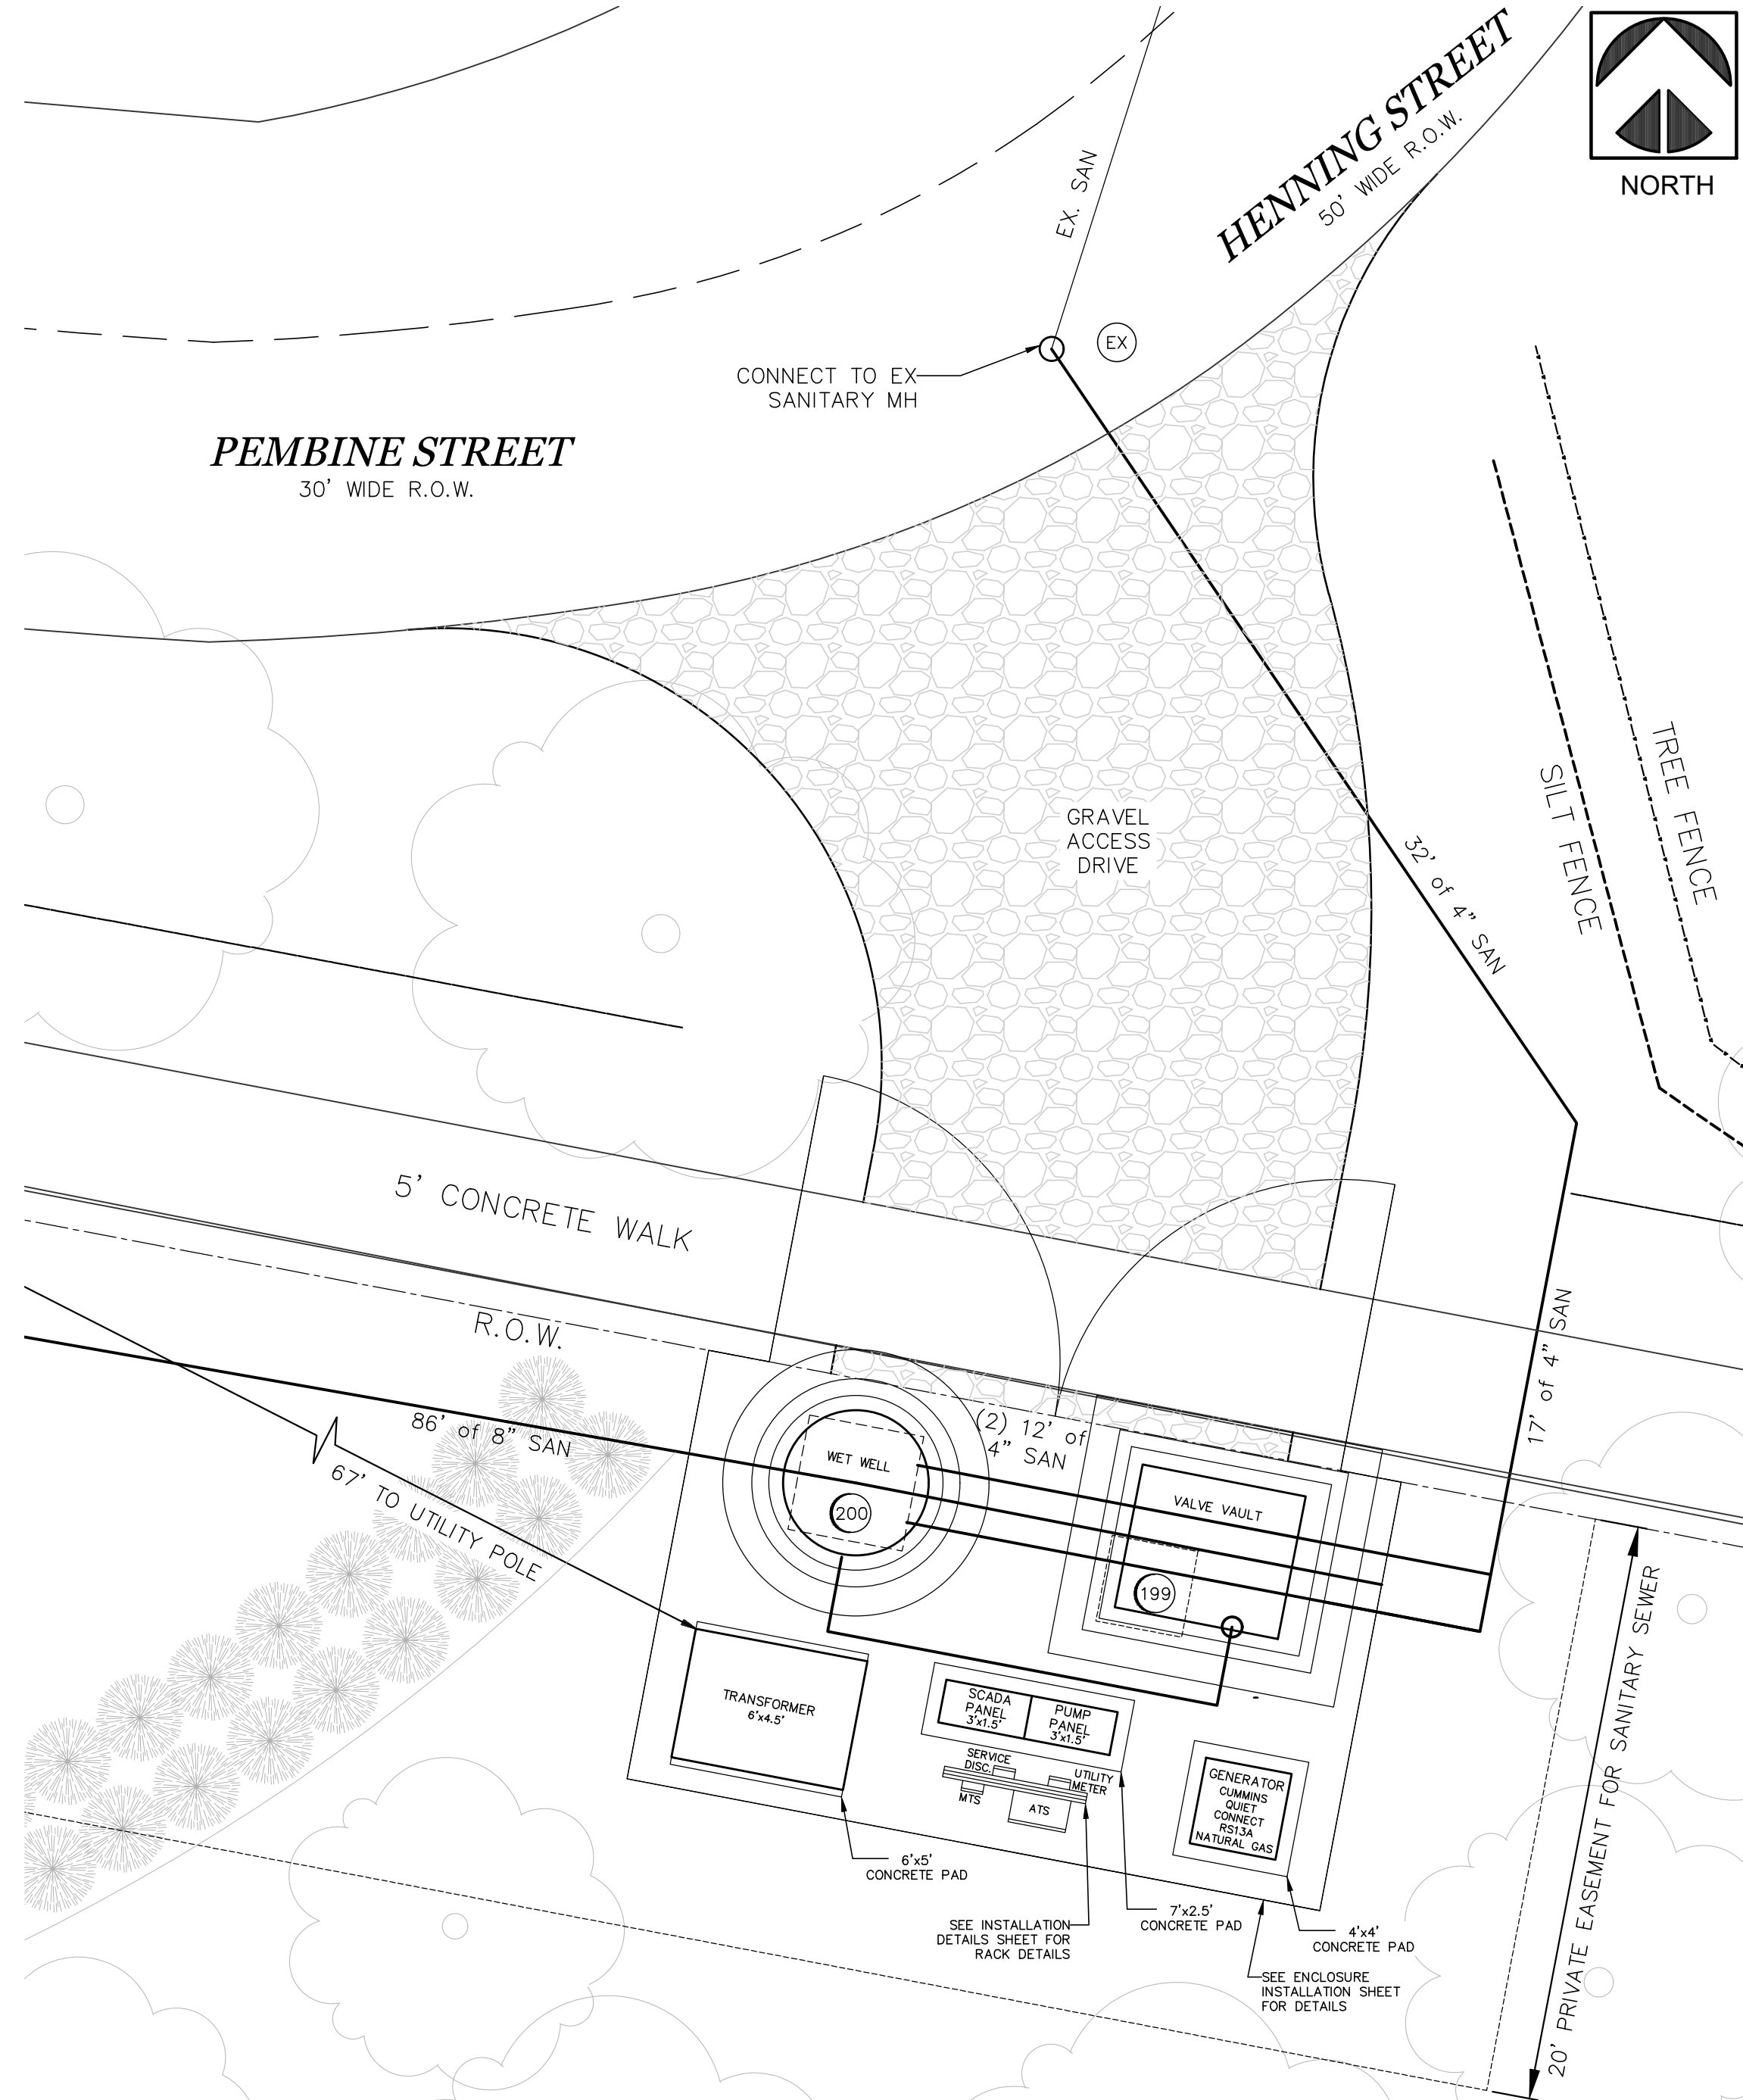
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PLAN VIEW
BASE ELEVATION

DIMENSIONAL SCHEDULE		
Ø DISCHARGE PIPE TO Ø OF WET WELL	A	12"
CLEAR OPENING OF WET WELL HATCH	B	38"
CLEAR OPENING OF VALVE VAULT HATCH	C	36"x36"
Ø DISCHARGE PIPE TO INSIDE FACE OF SUMP PUMP SIDE OF VALVE VAULT	D	30"
Ø TO Ø DISCHARGE PIPES IN VALVE VAULT	E	24"
Ø DISCHARGE PIPE TO INSIDE FACE OF OPPOSITE SIDE OF VALVE VAULT	F	18"
CLEAR OPENING OF WETWELL HATCH WIDTH (FRAME OPENING WIDTH - 7")	G	41"

PLAN VIEW
GRADE ELEVATION



SITE PLAN OF PROPOSED
SANITARY PUMP STATION
SCALE: 1" = 5'

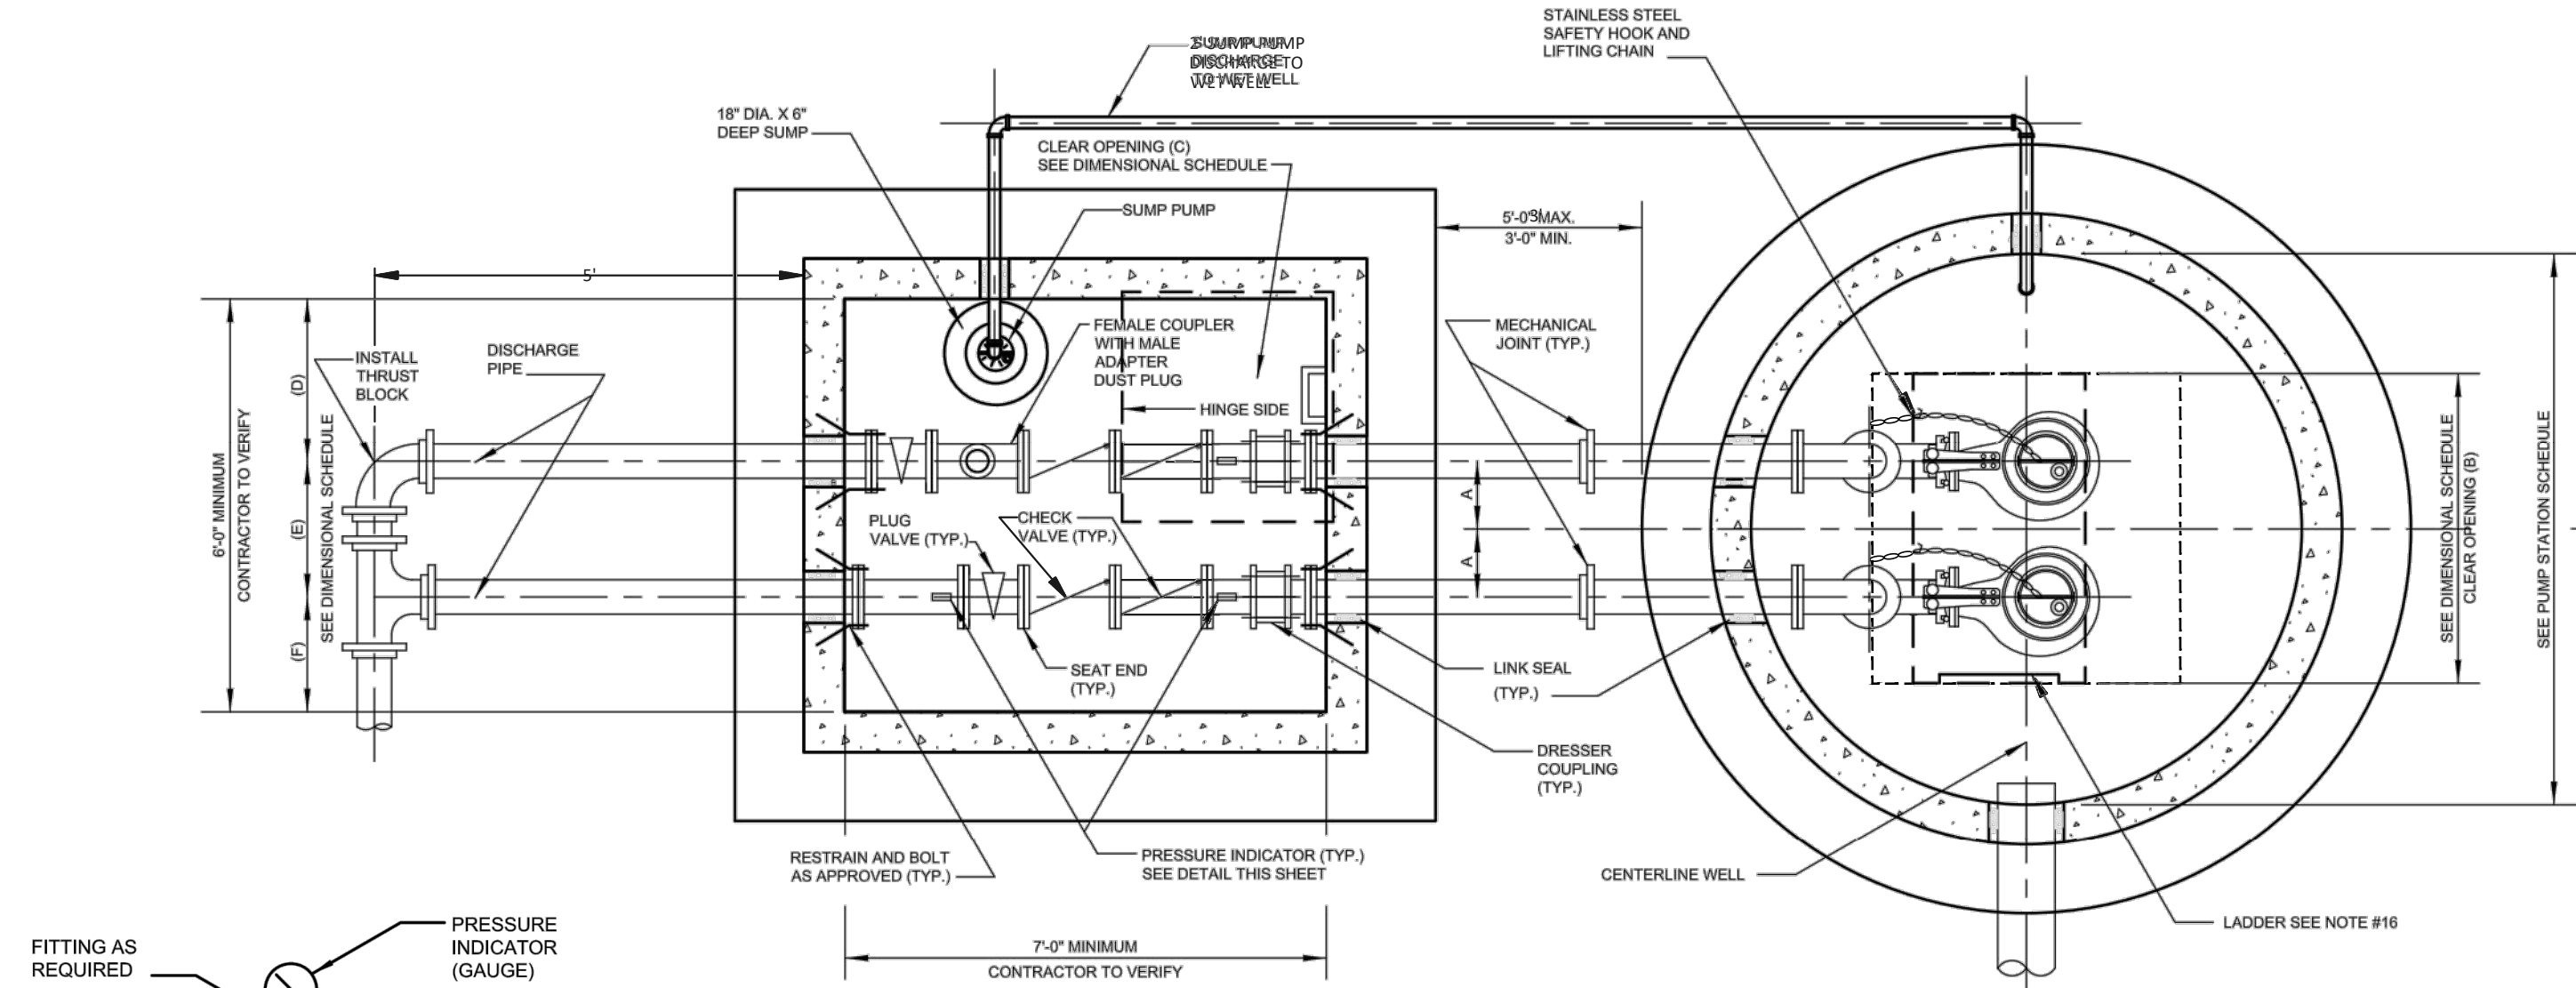* SEE SHEETS 30 THROUGH 32 FOR PUMP AND SCADA CONTROL PANEL DETAILS.
* SHOP DRAWINGS SHALL PROVIDE CONDUIT ROUTING AS REQUIRED.

SANITARY BASIS OF DESIGN

Connection to existing 8" PVC sanitary sewer along Henning St.

NUMBER OF UNITS
= 25 UNITS TOTAL

POPULATION
= 2.38 PEOPLE/UNIT X 25
= 59.5 PEOPLE

AVERAGE FLOW
= 60 PEOPLE X 100 GAL/CAP/DAY
= 5950 GAL/DAY
= 0.00893 CFS

PEAK FACTOR
= 18+(SQRT(P/1000))/(4+SQRT(P/1000))
= 4

PEAK FLOW
= 0.036 cfs
PEAK FACTOR x AVERAGE FLOW

(CAPACITY OF A 8" PIPE @ 0.40% IS 0.76 CFS)
THEREFORE PIPE CAPACITY IS SUFFICIENT

SITES=25 UNITS X 350 G.P.D. = 8750 G.P.D.
=G.P.D. / 1440 = 6.08 G.P.M.x Peaking factor =
USE 26 G.P.M PUMP

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The Umlor Group
LAND DEVELOPMENT SERVICES

SECTION 3
TOWN 1 NORTH, RANGE 8 EAST
CITY OF NOVI
OAKLAND COUNTY, MICHIGAN

SCENIC PINES
SINGH DEVELOPMENT, LLC.
7125 ORCHARD LAKE ROAD
BLOOMFIELD HILLS, MICHIGAN 48322

CLIENT:
SANITARY PUMP STATION PLAN & DETAILS


DATE: 11-27-2019

REVISIONS
PER CITY 03-24-2020
PER CITY 01-18-2021
PER CITY 10-06-2021

DR BY: SDT
CK BY: SDT/MY
P.M. SA
SCALE 0
AS NOTED
JOB NO. 180905
SHEET NO. 28
SHEET 28 OF 38

PRESSURE INDICATOR POST

- NOTES:
- GAUGE PROTECTOR: ELASTOMERIC
 - PIPING $\frac{1}{2}$ EXCEPT AS APPROVED

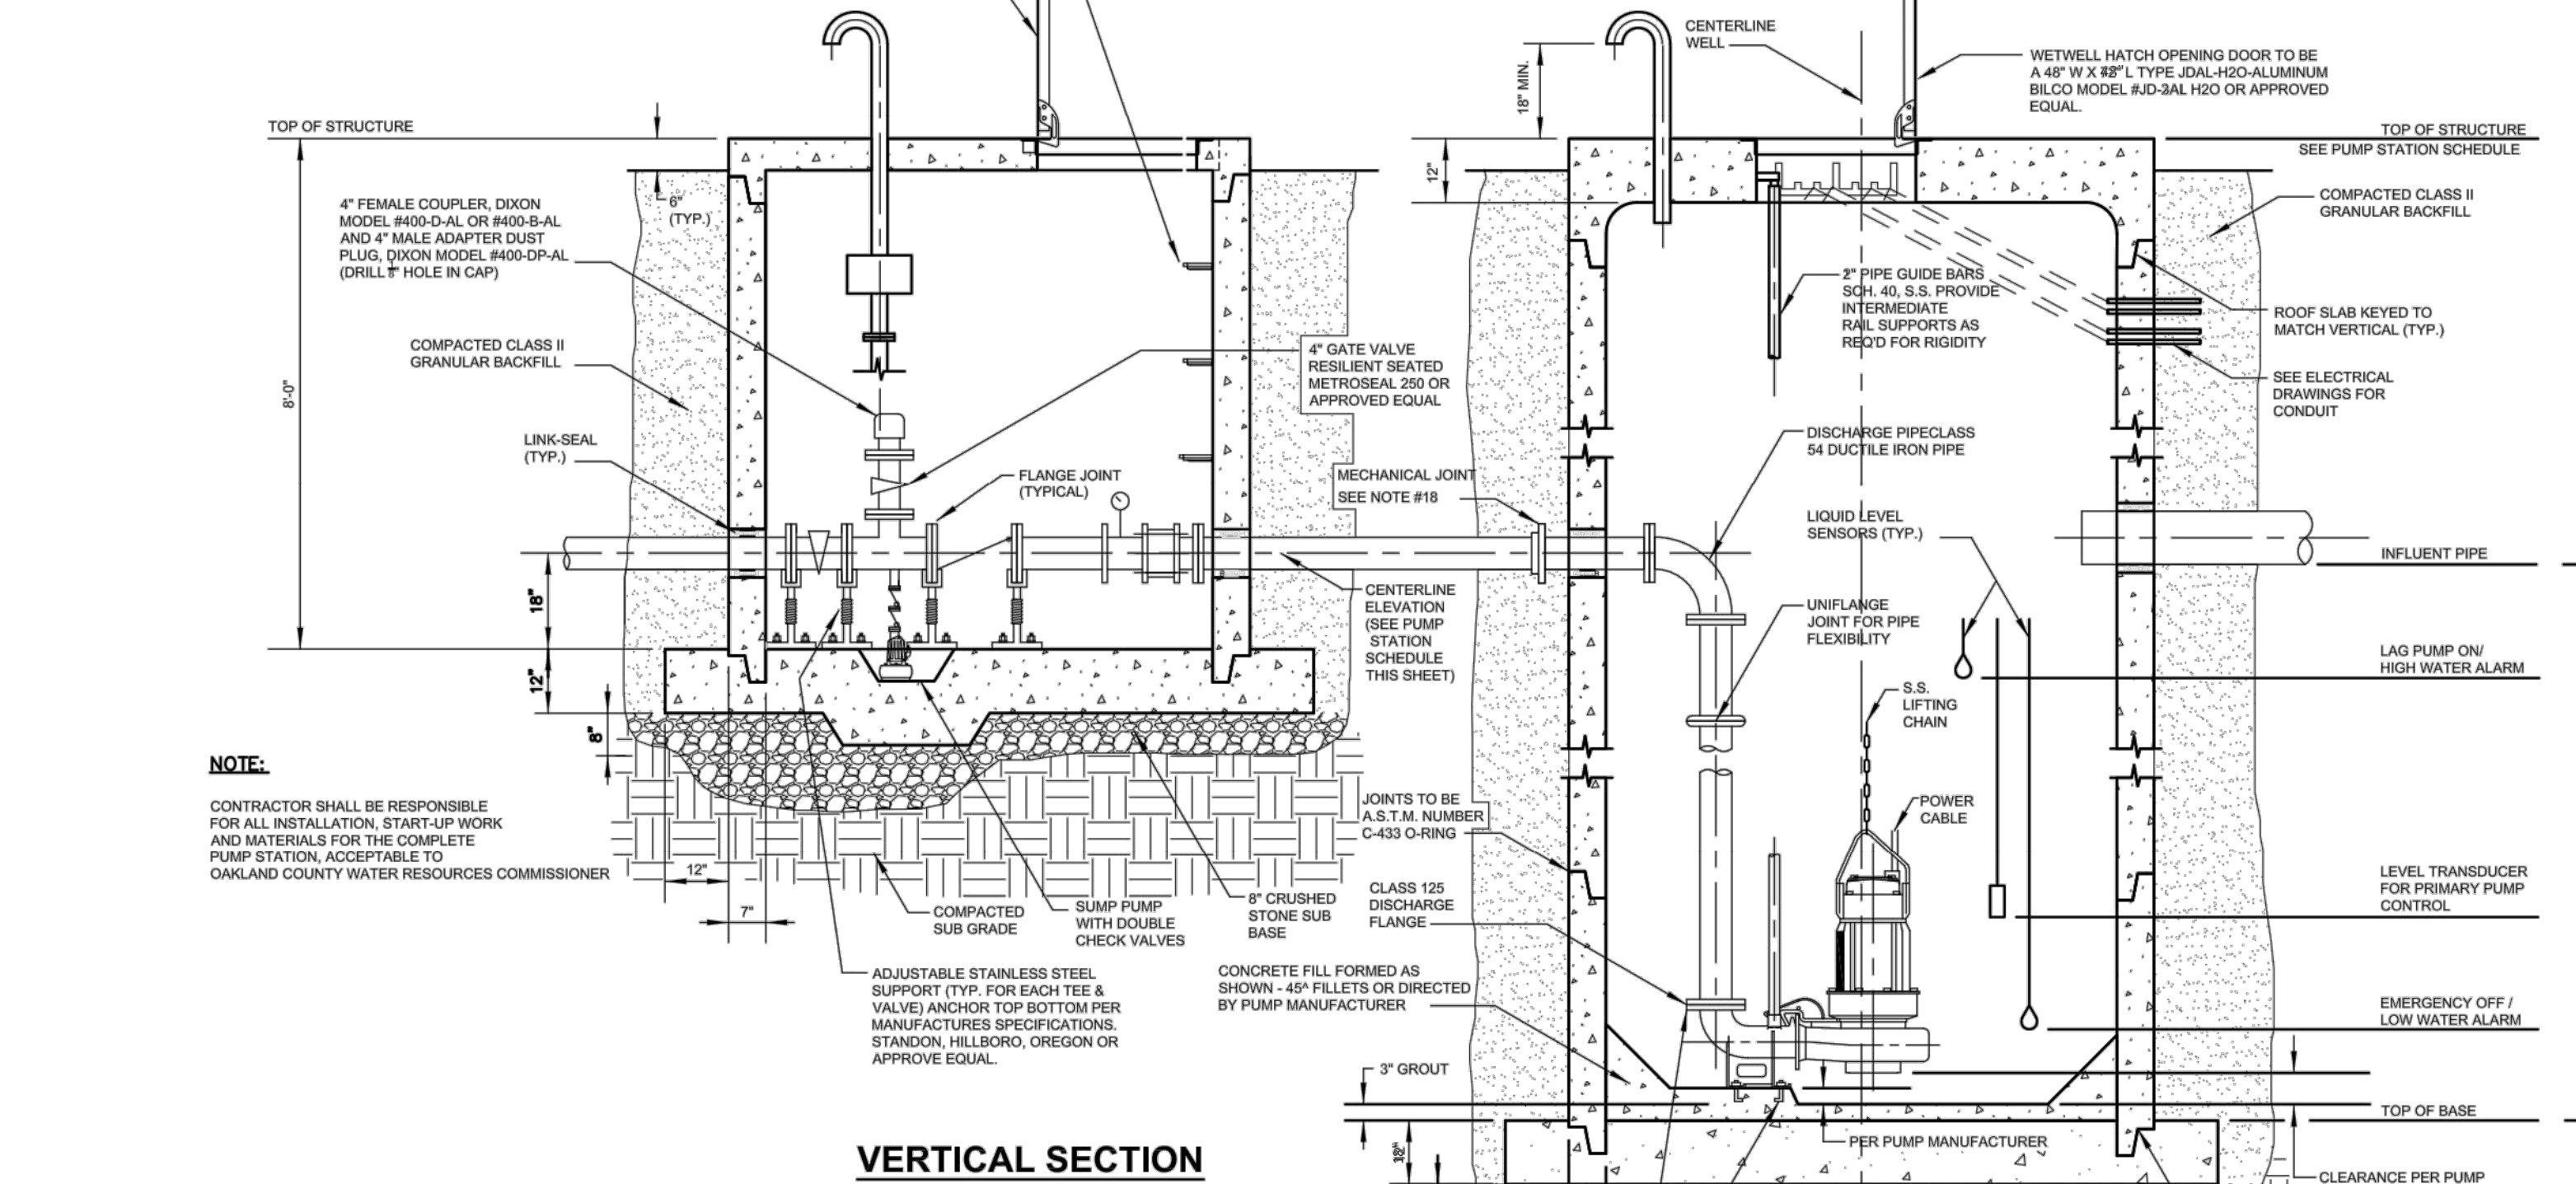


VERTICAL SECTION

DETAIL OF WET WELL AND VALVE VAULT SECTION
NO SCALE


GENERAL NOTES:

- CONTRACTOR SHALL FURNISH LOCKS (WHICH MEET OAKLAND COUNTY WATER RESOURCES COMMISSIONER REQUIREMENTS) WITH ONE MASTER KEY FOR THE EQUIPMENT ENCLOSURE, SAFETY SWITCHES AND HATCHES (INCLUDE GENERATOR).
- SHOP DRAWINGS SHALL BE SUBMITTED FOR APPROVAL BEFORE FABRICATION OF EQUIPMENT AND STRUCTURES.
- ACCESS COVER, ANCHOR BOLTS, AND PUMP LOCATION IN WET WELL SHALL BE CONFIRMED WITH APPROVED SHOP DRAWINGS PRIOR TO CONSTRUCTION.
- PIPING SHALL BE PAINTED PER OAKLAND COUNTY WATER RESOURCES COMMISSIONER SPECIFICATIONS. (EPOXY COATED PIPE AND PVC PIPE SHALL NOT BE PAINTED)
- SEAL ALL PIPE AND CONDUIT OPENINGS WITH NON-SHRINK GROUT UNLESS OTHERWISE SHOWN OR SPECIFIED.
- DO NOT LOCATE LIQUID LEVEL SENSORS OR EMERGENCY FLOATS NEAR INFLUENT STREAM.
- POWER METER ENCLOSURE SHALL BE FURNISHED BY DETROIT EDISON CO. AND INSTALLED BY CONTRACTOR.
- PRECAST VALVE VAULT AND PUMP STATION WET WELL SHALL BE PROVIDED WITH REINFORCING STEEL TO MEET H-20 LIVE LOADS AND DEAD LOADS AS INDUCED BY STRUCTURE DEPTH. THE STRUCTURAL DIMENSIONS SHOWN SUCH AS WALL THICKNESS ARE FOR GUIDANCE ONLY. WET WELL SHALL BE A MINIMUM OF C76 CLASS IV CONCRETE.
- STRUCTURE MANUFACTURER'S SHOP DRAWING SUBMITTAL SHOULD INCLUDE STRUCTURAL AND BUOYANCY CALCULATIONS BY A REGISTERED PROFESSIONAL ENGINEER IN THE STATE OF MICHIGAN
- TWO INSTALLED PRESSURE INDICATORS ARE REQUIRED ON PUMP SIDE OF VALVES. IN ADDITION ONE INSTALLED PRESSURE GAUGE ON DOWNSTREAM END OF VALVE IS REQUIRED.
- CONTRACTOR SHALL SUPPLY SPARE IMPELLER AND OTHER PARTS AS INDICATED IN SPECIFICATIONS.
- CONTRACTOR SHALL PLACE WET WELL AND VALVE VAULT VENTS SUCH THAT THEY DO NOT FACE THE CONTROL PANEL.
- ALL PIPE OPENINGS IN CAST STRUCTURES ARE TO BE CAST IN PLACE OR CORED. BREAK-OUTS WITH SLEDGEHAMMERS OR JACK HAMMERS IN THE FIELD WILL NOT BE ALLOWED.
- SEE SPECIFICATIONS FOR SUMP PUMP INFORMATION:
SUMP PUMP DISCHARGE PIPING SHALL BE 2" HDPE SDR 11 AND INCLUDE TWO (2) CHECK VALVES FOLLOWED BY ONE (1) BALL VALVE.
- LADDER SPECIFICATION:
A. FIBERGLASS LADDER AS MANUFACTURED BY IMCO OR APPROVED EQUAL
B. LADDER RUNGS @16" O.C.
C. ATTACH TO WET WELL WITH STANDOFF CLIPS AS REQUIRED
- PUMPS SHALL BE EXPLOSION PROOF, SEE SPECIFICATIONS.
- THE JOINT NEEDS TO BE RESTRAINED BY ONE OF THE FOLLOWING APPROVED METHODS:
A. RESTRAIN JOINT TO WETWELL & VALVE VAULT STRUCTURE WALLS
B. USE MECHANICAL JOINT RESTRAINT OR FIELD-LOCK GASKET
- MUST INCREASE FROM A 2.5" D.I.P. TO A 4" D.I.P. AFTER THE PUMPS AND BEFORE THE WETWELL.
- FLANGE JOINTS MUST BE USED IN WET WELL AND VALVE VAULT.
- ONSITE EMERGENCY GENERATOR SHALL BE INSTALLED OF SUFFICIENT SIZE TO OPERATE ALL COMPONENTS OF PUMP STATION.
- DETAILS AND INSTALLATION OF PUMP AND PLUMBING WITHIN THE WET WELL WELL BE AS REQUIRED PER THE PUMP MANUFACTURERS SPECIFICATIONS OR AS REQUIRED BY OCWRC.
- CONTRACTOR SHALL FURNISH SHOP DRAWINGS OF THE COMPLETE PUMP FOR APPROVAL.
- LIQUID LEVEL SENSORS SHALL BE ON OPPOSITE SIDE OF INFLUENT PIPE, NOT TO BE IMPACTED BY INFLUENT WASTEWATER.
- CONTRACTOR IS RESPONSIBLE FOR INSTALLATION OF SCADA PANEL. WRC INTEGRATOR WILL TIE INTO WRC SCADA SYSTEM AND PERFORM PLC PROGRAMMING.
- CONTROLS AND ELECTRICAL EQUIPMENT SHALL MEET WRC STANDARDS AND SPECIFICATIONS.

Performance Curve
GRP10/3FM

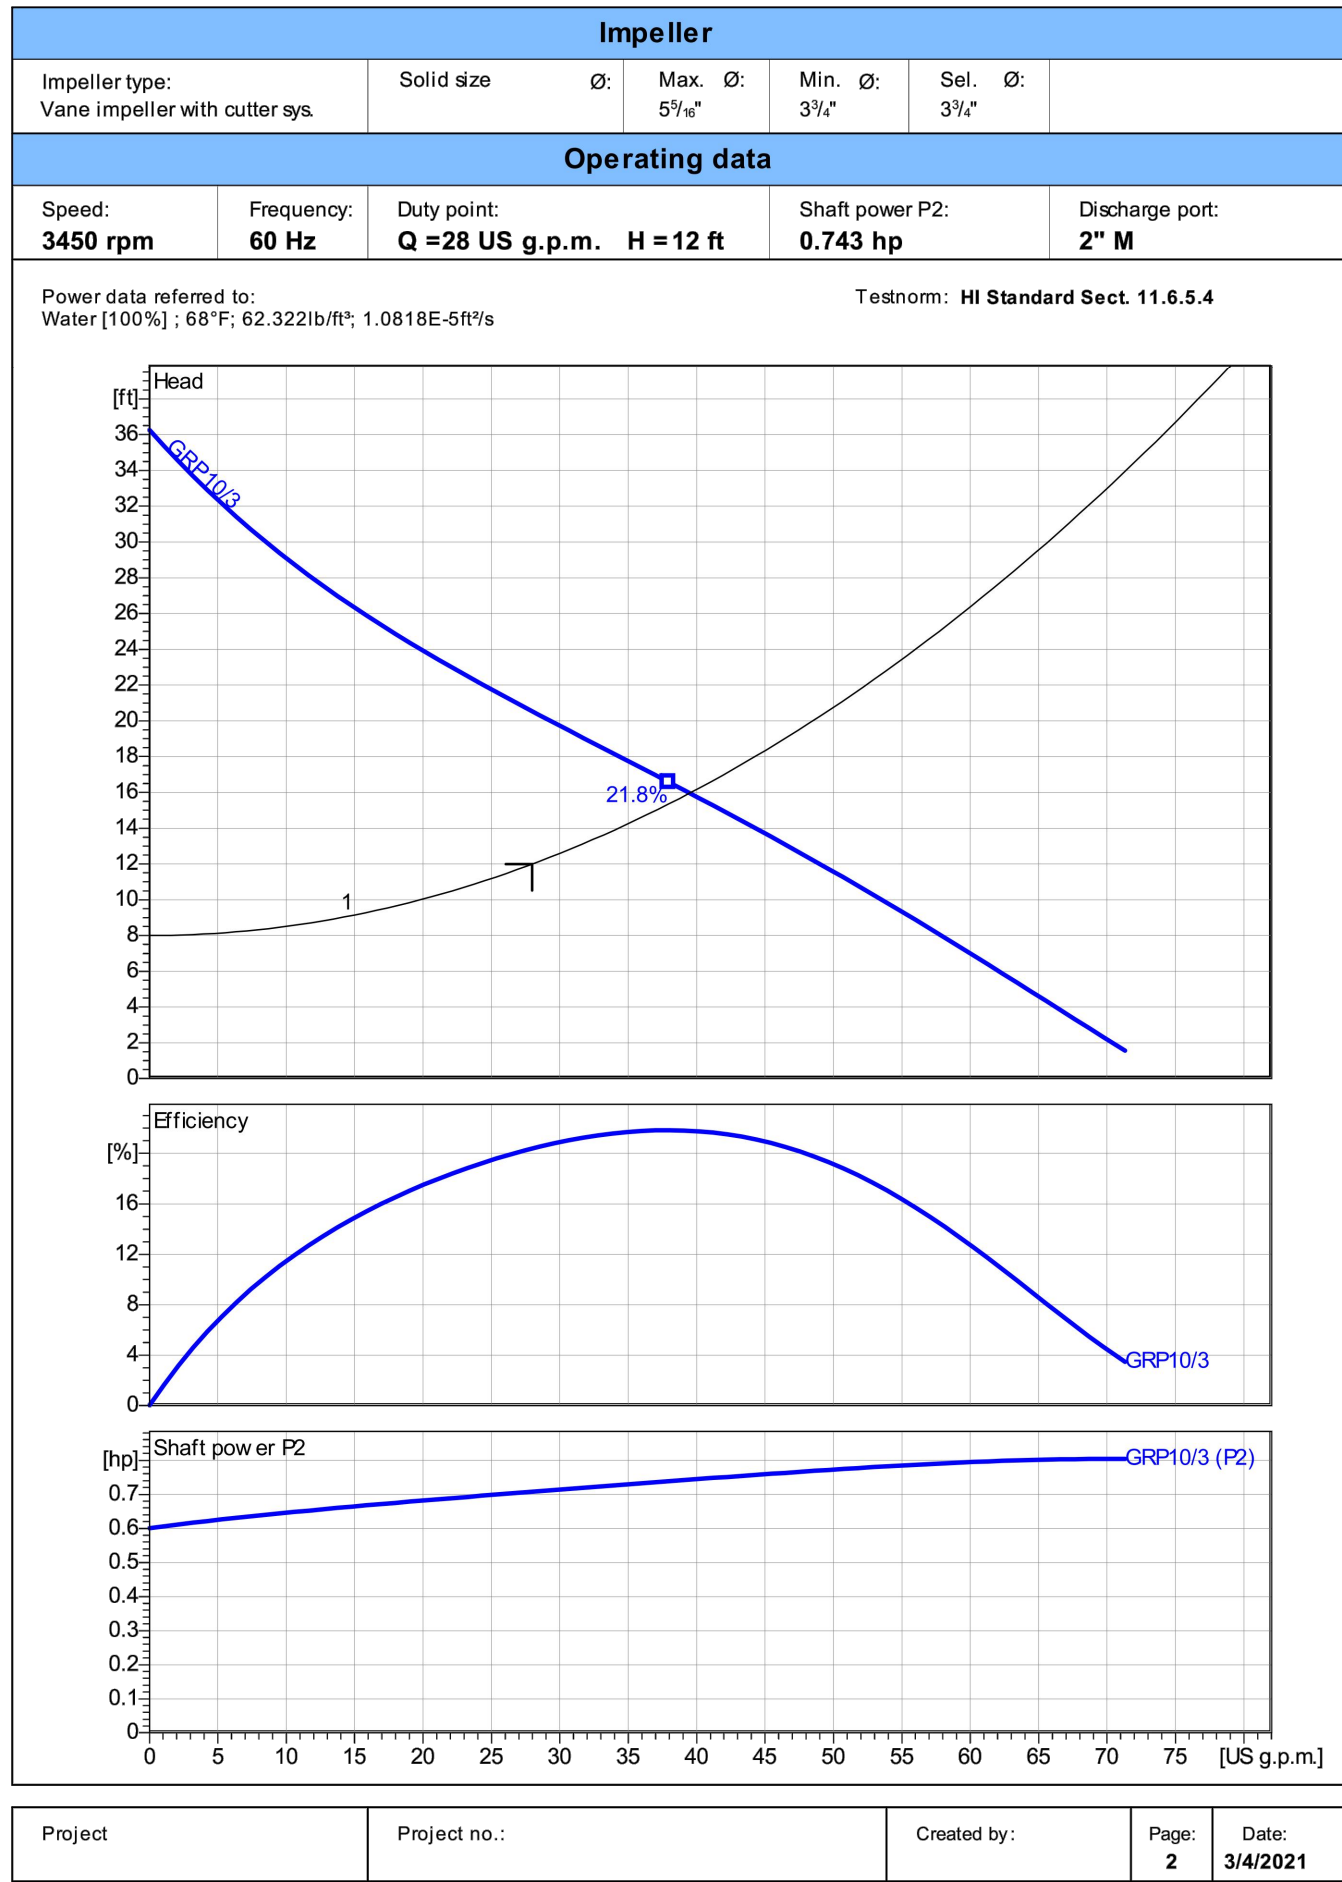

Dimensions
GRP10/3FM

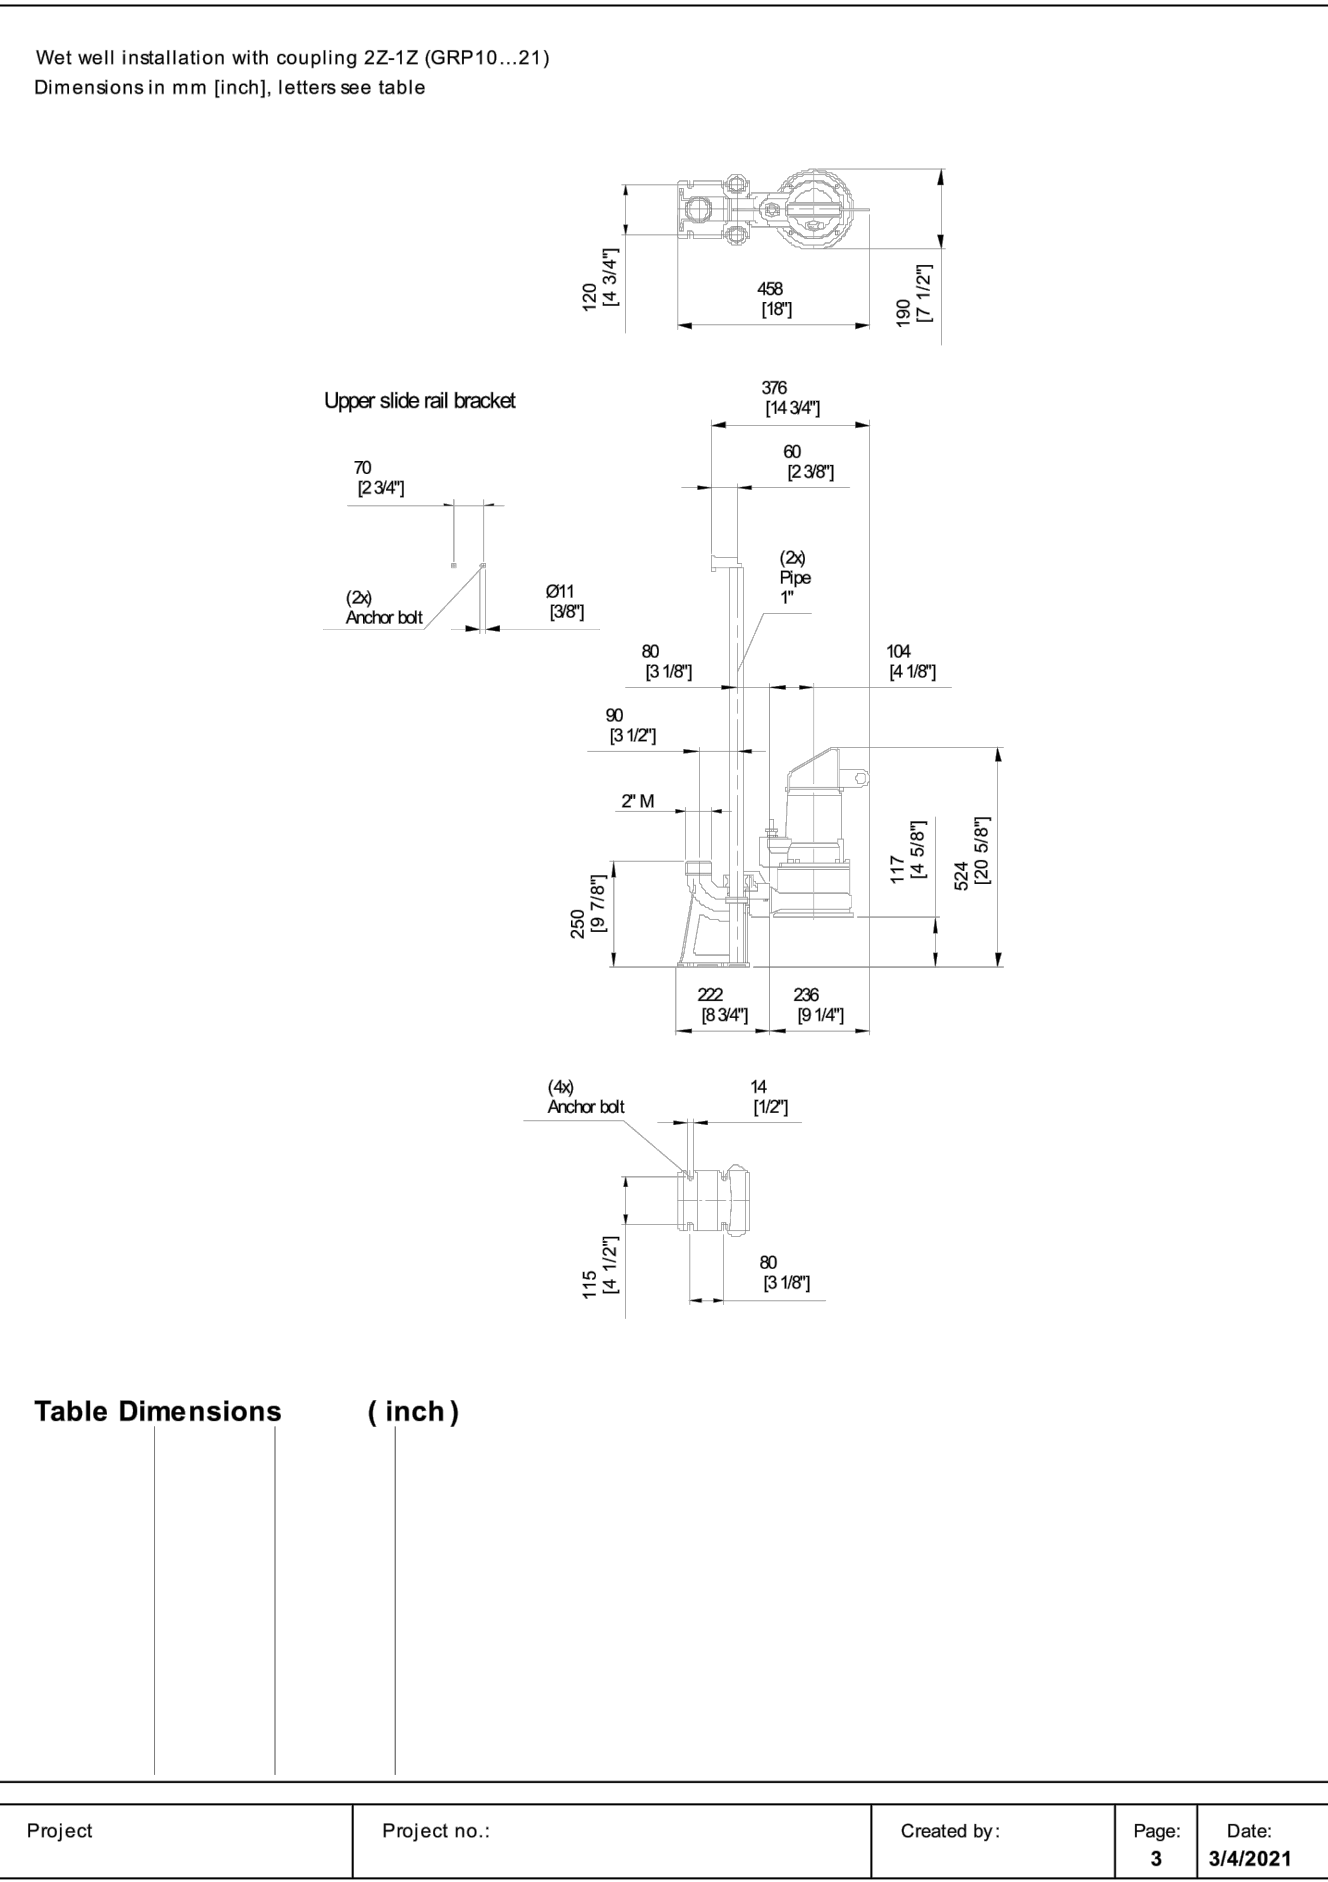

Technical Data
GRP10/3FM



Operating data			
Flow	28 US g.p.m./US g.p.m.	Head	12 ft
Shaft power P2	0.7 hp	Static head	8 ft
Pump efficiency	21.8 %	Required pump NPSH	ft
Pumps type	Single pump	No. of pumps	1
Fluid	Wastewater	Temperature	68 °F
Density	62.31 lb/ft³	Kin. viscosity	1.077E-5 ft²/s

Pump			
Pump Code	GRP10/3FM	Speed	3450 rpm
Suction port		Head	Max. 36.3 ft
Discharge port	2" M	Min.	1.6 ft
Impeller type	Vane impeller with cutter sys.	Flow	Max. 71.3 US g.p.m.
Solid size		Pump efficiency max.	21.8 %
Impeller Ø	3.74 inch	Required rated power max. P2	0.8 hp

Motor			
Motor design	Submersible motor	Insulation class	H
Motor name	AM120TM 1.6/2/3	Degree of protection	IP 68
Frequency	60 Hz	Temperature class	T4
Rated power P1	1.1 hp	NEMA code	F
Rated power P2	0.8 hp	Explosion protection	Class 1, Div. 1, Grp. C&D
Rated speed	3450 rpm	Efficiency	100% 75.0 %
Rated voltage	230 / 460 V 3~	at % rated power	75% 50% %
Rated current	3.2 / 1.6 A		
Starting current, direct starting	25.0 / 12.5 A	cos phi	100% 0.64
Starting current, stand-still	A	at % rated power	75% 50% %
Starting mode	Directly		
Power cable	7X1.5	Control cable	
Type of power cable	NSSHOU-J	Type of control cable	
Cable length	32.809 ft	Service factor	1.15
Shaft seal	Mechanical seal on medium side	SIC / SIC	
Shaft seal (motor side)		Nitrile Rubber	
Bearing	Lower Bearing	Double row angular ball bearing	
Upper Bearing		Deep Groove Ball Bearing	
Remarks			

Materials / Weight			
Motor housing	Cast Iron ASTM A48/CI 40B	Motor shaft	AISI 430 F Stainless Steel
Pump housing	Cast Iron ASTM A48/CI 40B	Bolts	AISI 304 Stainless Steel
Motor bearing cover	Cast Iron ASTM A48/CI 40B	O-Rings	Nitrile Rubber
Impeller	Cast Iron ASTM A48/CI 40B		
Cutting system	Hardened Stainless Steel HRC55		
Weight aggregat	55.115 lb		

Project: _____	Project no.: _____	Created by: _____	Page: 4	Date: 3/4/2021
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DETAIL OF DUPLEX GRINDER PUMP CURVE DATA
NO SCALE

DETAIL OF DUPLEX GRINDER PUMP
NO SCALE

DETAIL OF DUPLEX GRINDER PUMP TECHNICAL DATA
NO SCALE

H_x - Elevation @ Pump OFF

Elevation @ Pump OFF(H_x) = D(1+2.3F_D)

D=Inlet Diameter (ft) = 0.67 ft

g=gravity = 32.2 ft/s²

V=Velocity (ft/s) = 2.57 ft/s

F_D=Hydraulic Froude Number = V/(gD^{0.5})

F_D = 0.097751376

H_x = 0.82 ft

H_x(DESIGN VALUE) = 2.25 ft

H_{Min} - Elevation @ Lead Pump ON

Elevation @ Pump ON(H_{min}) = V_{min}/A

V_{min}=Minimum storage volume = T_{min}*Q out/4 gallons

A=Cross section area of wet well = 28.27 ft²

D=Diameter of wet well (ft) = 6 ft

T_{min}=Min cycle time btw pump starts = 2 min

Q out = 28 gpm

V_{min} = 14 gallons

H_m = 0.5 ft

H_{Lag} - Elevation @ Lag Pump ON

Min Elevation @ Second Pump ON(H_{Lag}) = 8 in

Elevation @ Second Pump ON(H_{Lag}) = 0.75 ft

H_{Alt} - High Water Level Alarm

Elevation @ high level alarm ON(H_{Alt}) = 9 in

Elevation @ high level alarm ON(H_{Alt}) = 0.75 ft

AVERAGE FLOW TOTAL = 4.13 G.P.M

PEAK FLOW TOTAL = 23073.45 G.P.D OR 16.02 G.P.M

WET WELL SIZE (SEC. 42.62 OF TEN STATE STANDARDS)

FILL TIME NOT TO EXCEED 30 MIN. BASED ON AVERAGE FLOW (30 MIN. X 16.02 G.P.M = 480.6 G.P.M OR 64.25 CFT)

Radius (r) = 3 ft

Min Volume Required (V) = 64.25 cft

WET WELL SIZING: (r)² (3.14) h = V

solve for height (h) = 2.27 , use 2.5 ft

Total Dynamic Head(TDH)

Force Main Length(ft) (L) = 68 ft

Quantity of flow (Q) = 28 G.P.M

Diameter of outlet pipe (D) = 4 in.

C=Hazen Williams friction coefficient = 80

Head loss due to friction(h_f) = 0.12 ft

h_f = L*10.5*(Q/C)^{1.85}*(D)^{-4.87}

K = K coefficient (unitless) = 4.3

v = velocity of fluid in pipe (ft/s)=(Q/A) = 2.57 ft/s

g = gravity = 32.2 ft/s²

h_m = minor headloss (ft) = 0.44 ft

h_m = Sum(K) * (V² / 2g)

Static head=(H) = 11 ft

TDH = Total Dynamic Head (ft) = H+h_m+h_f = 11.56 ft

TDH = Total Dynamic Head (ft) ~ 12.00 ft

Submersible Drainage/ Sump Utility Pump

- Stainless Steel, Cast Iron and Plastic Construction
- Built-in Thermal Protection
- Triplex Seal System; Double Mechanical Seals Plus Shaft Seal
- Automatic Mercury Free Float Switch Included (Except Stainless Steel Model 5780-98)
- UL/CSA Listed
- 1/2 HP, 115 VAC UL/SJT Cord with 3 Prong Plug
- 1-1/2" to 2" NPT Port Sizes
- Clog Resistant Impellers
- Solids Handling and Dirty Water Design
- Oil Filled, Quiet Run Motor Design

Model 5792-95

AMT Submersible Sump pumps are designed for many applications including sump pits, drainage pits, overflow tanks, basements, dewatering, excavation, grain elevators, construction drainage, cooling towers and other applications requiring clear water removal. AMT Submersible pumps include suction screen and automatic float switch (except stainless steel model 5780-98).

Performance of Submersible Utility Pumps

AMT Submersible Utility Pumps are designed for many applications including sump pits, drainage pits, overflow tanks, basements, dewatering, excavation, grain elevators, construction drainage, cooling towers and other applications requiring clear water removal. AMT Submersible pumps include suction screen and automatic float switch (except stainless steel model 5780-98).

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Submersible Utility Pumps

Pump Dimensional & Specification Data

Model	Curve	HP	DIS"	Construction Materials	Type	Voltage @ 60 Hz	Full Load Amps	Cord Length (ft.)	Ship Wt. (lbs.)
5811-09	A	1/2	1.5"	Plastic	Vortex	115	5	12	15
5780-98	B	1/2	2"	Stainless Steel	Drainage	115	5	20	26
5792-95	C	1/2	2"	Cast Iron	Drainage	115	7	20	42

(1) Standard NPT (Female) pipe thread
(2) NOTE: Electric Supply for ALL motors must be within ± 10% of nameplate voltage (for 230V = 207 to 252V)

Standard Features

- UL/CSA Listed
- Automatic Float Switch (except Stainless Steel Model 5780-98)
- Double Mechanical Seal Construction
- Model 5811-09: Plastic Submersible Includes Hose Adapter
- Maximum Temperature 104° F
- Suction Screen
- 115 VAC UL/SJT Cord with 3 Prong Plug
- Carry Handle Built-In
- Thermally Protected
- Oil Filled, Quiet Run Motor Design
- QSP - Quick Ship Pumps

Manufacturer of AMT & IPT Pumps
400 Spring Street • Royersford, PA 19468 USA
www.amtpump.com • 888-amt-pump (268-7867)
The Gorman-Rupp Company reserves the right to discontinue any model or change specifications without notice without incurring any obligation.
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BASIS OF DESIGN FOR DUPLEX
LIQUID LEVEL CONTROL SETTINGS

DETAIL OF AIR RELEASE VALVE
NO SCALE

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SECTION 3
TOWN 1 NORTH, RANGE 8 EAST
CITY OF NOVI
OAKLAND COUNTY, MICHIGAN

CLIENT:
SCENIC PINES
SINGH DEVELOPMENT, LLC.
7125 ORCHARD LAKE ROAD
BLOOMFIELD HILLS, MICHIGAN 48322

PUMP DETAILS

DATE: 11-27-2019


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PER CITY 03-24-2020


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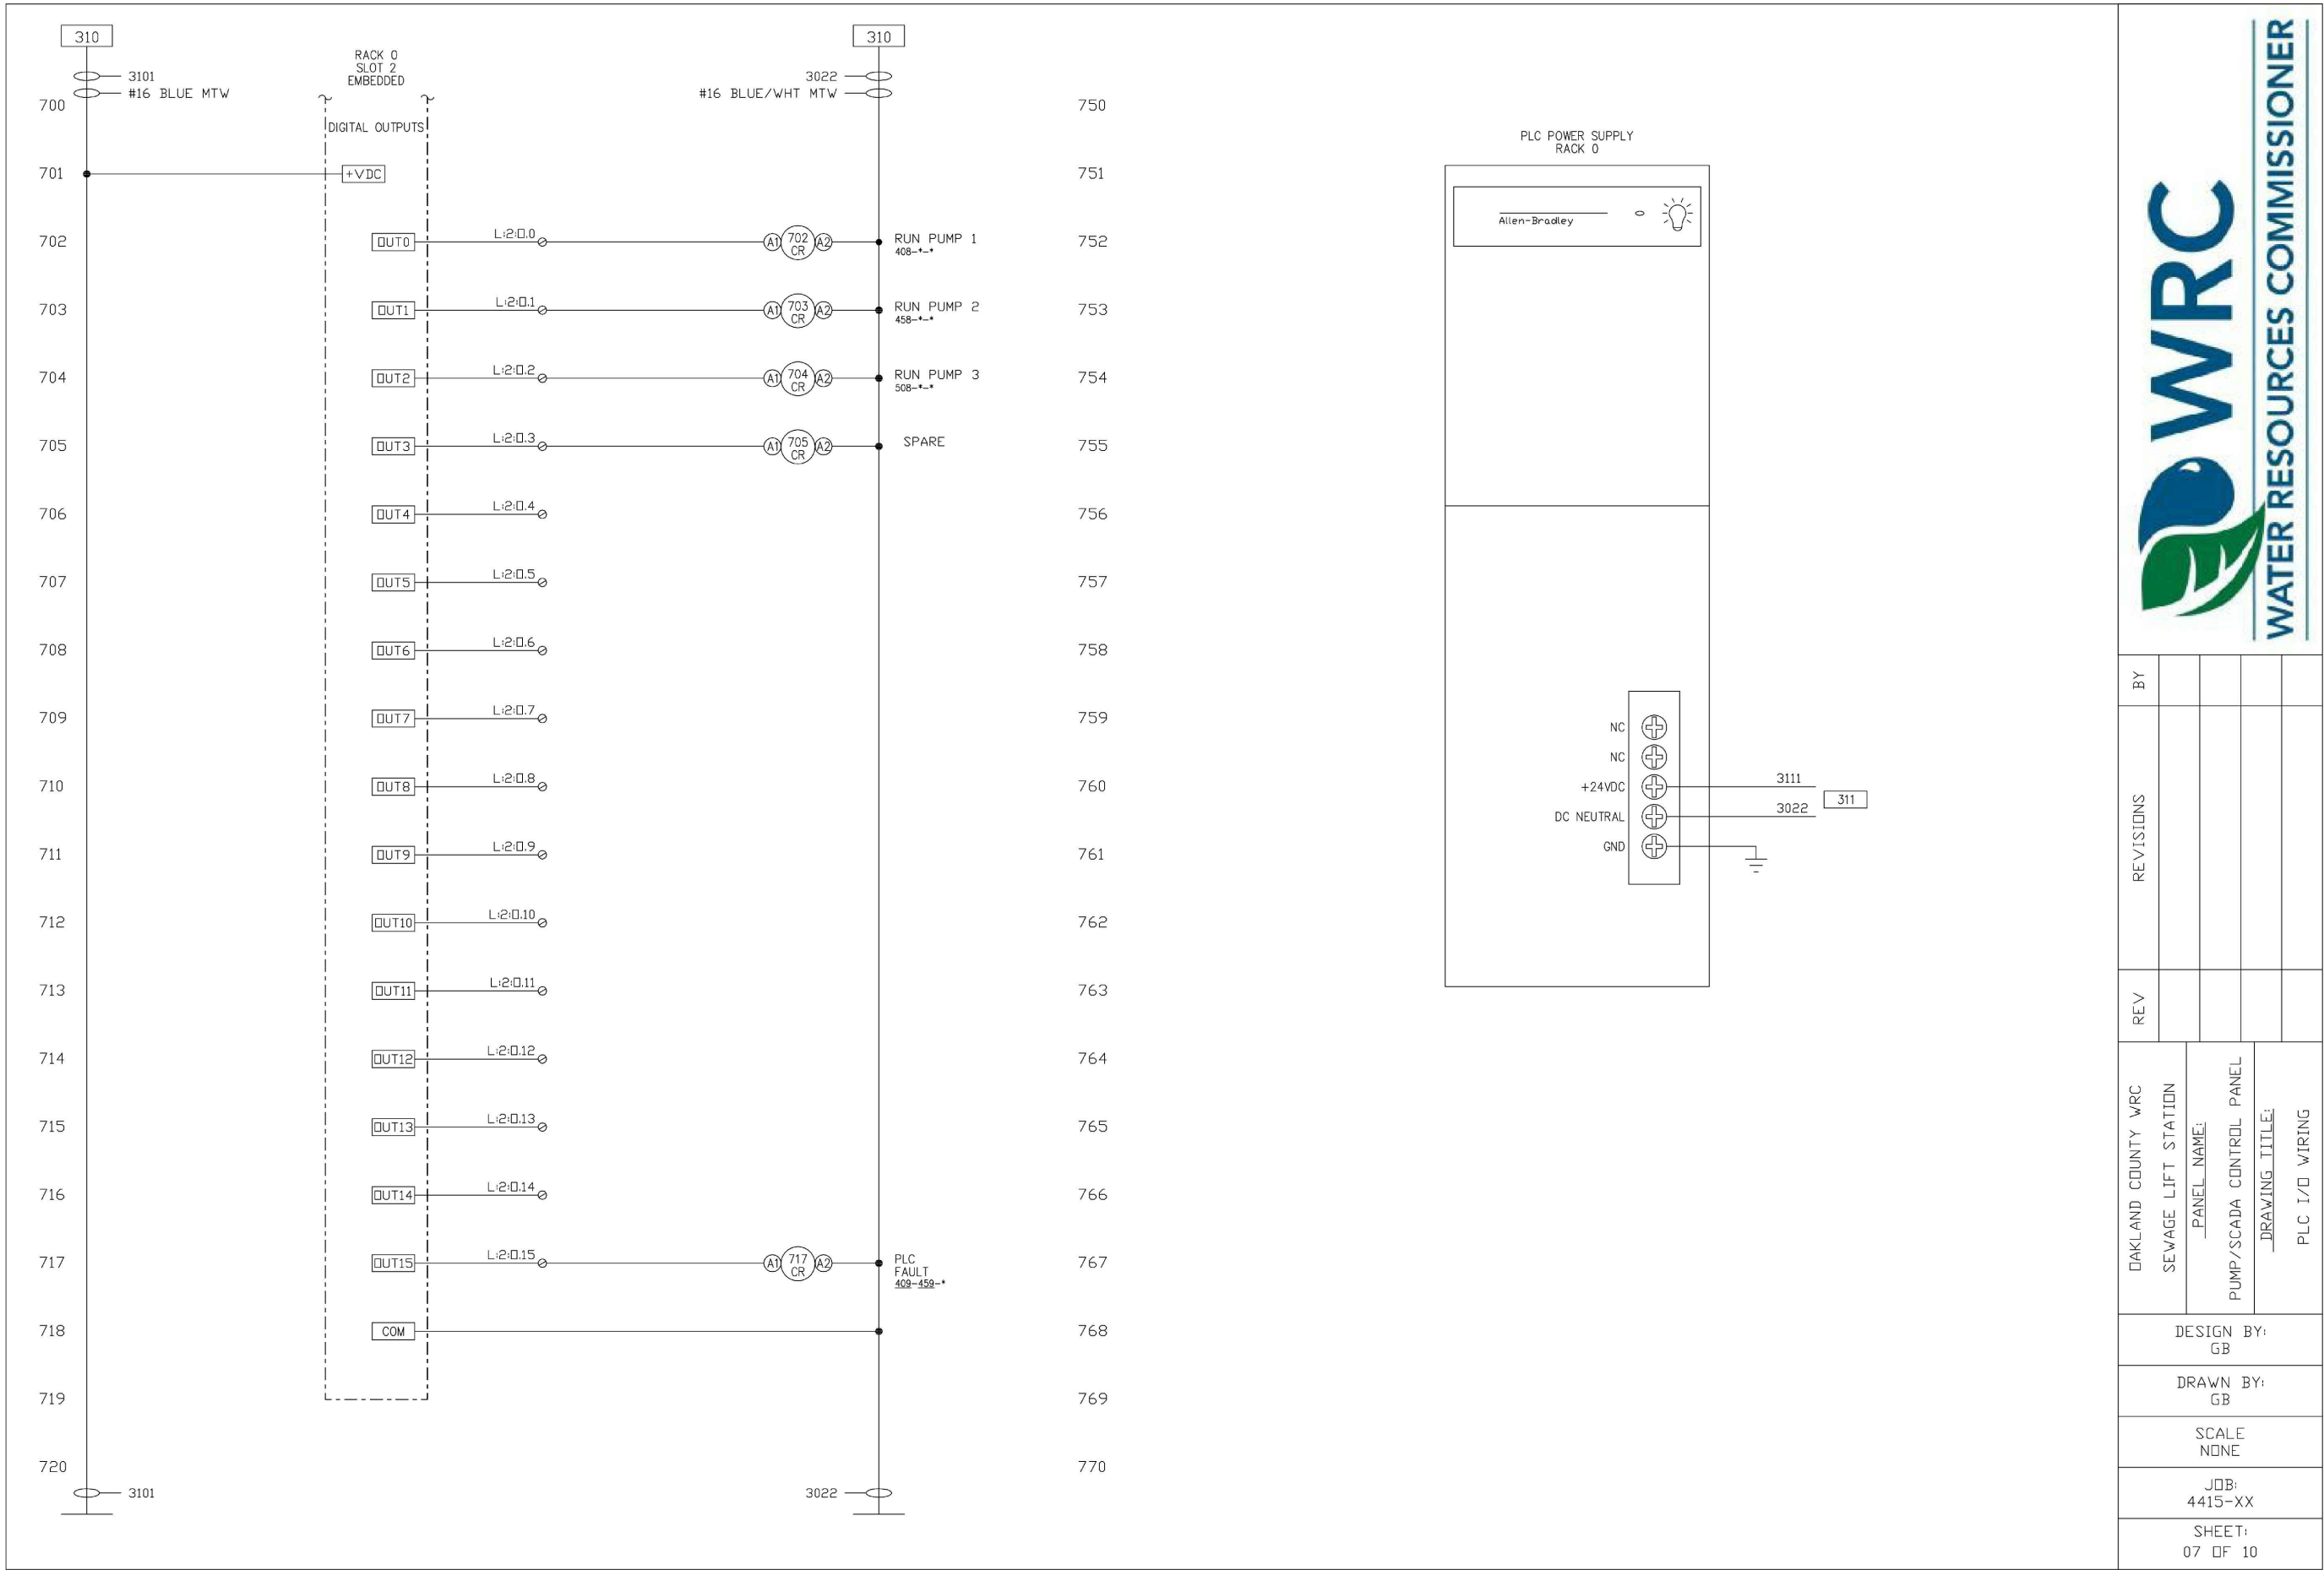
DR. BY: SDT
CK. BY: SDT/MY
P.M. SA
SCALE 0
AS NOTED
JOB NO. 180905
SHEET NO. 29
SHEET 29 OF 38




DETAIL OF 24VDC CONTROL POWER
NO SCALE

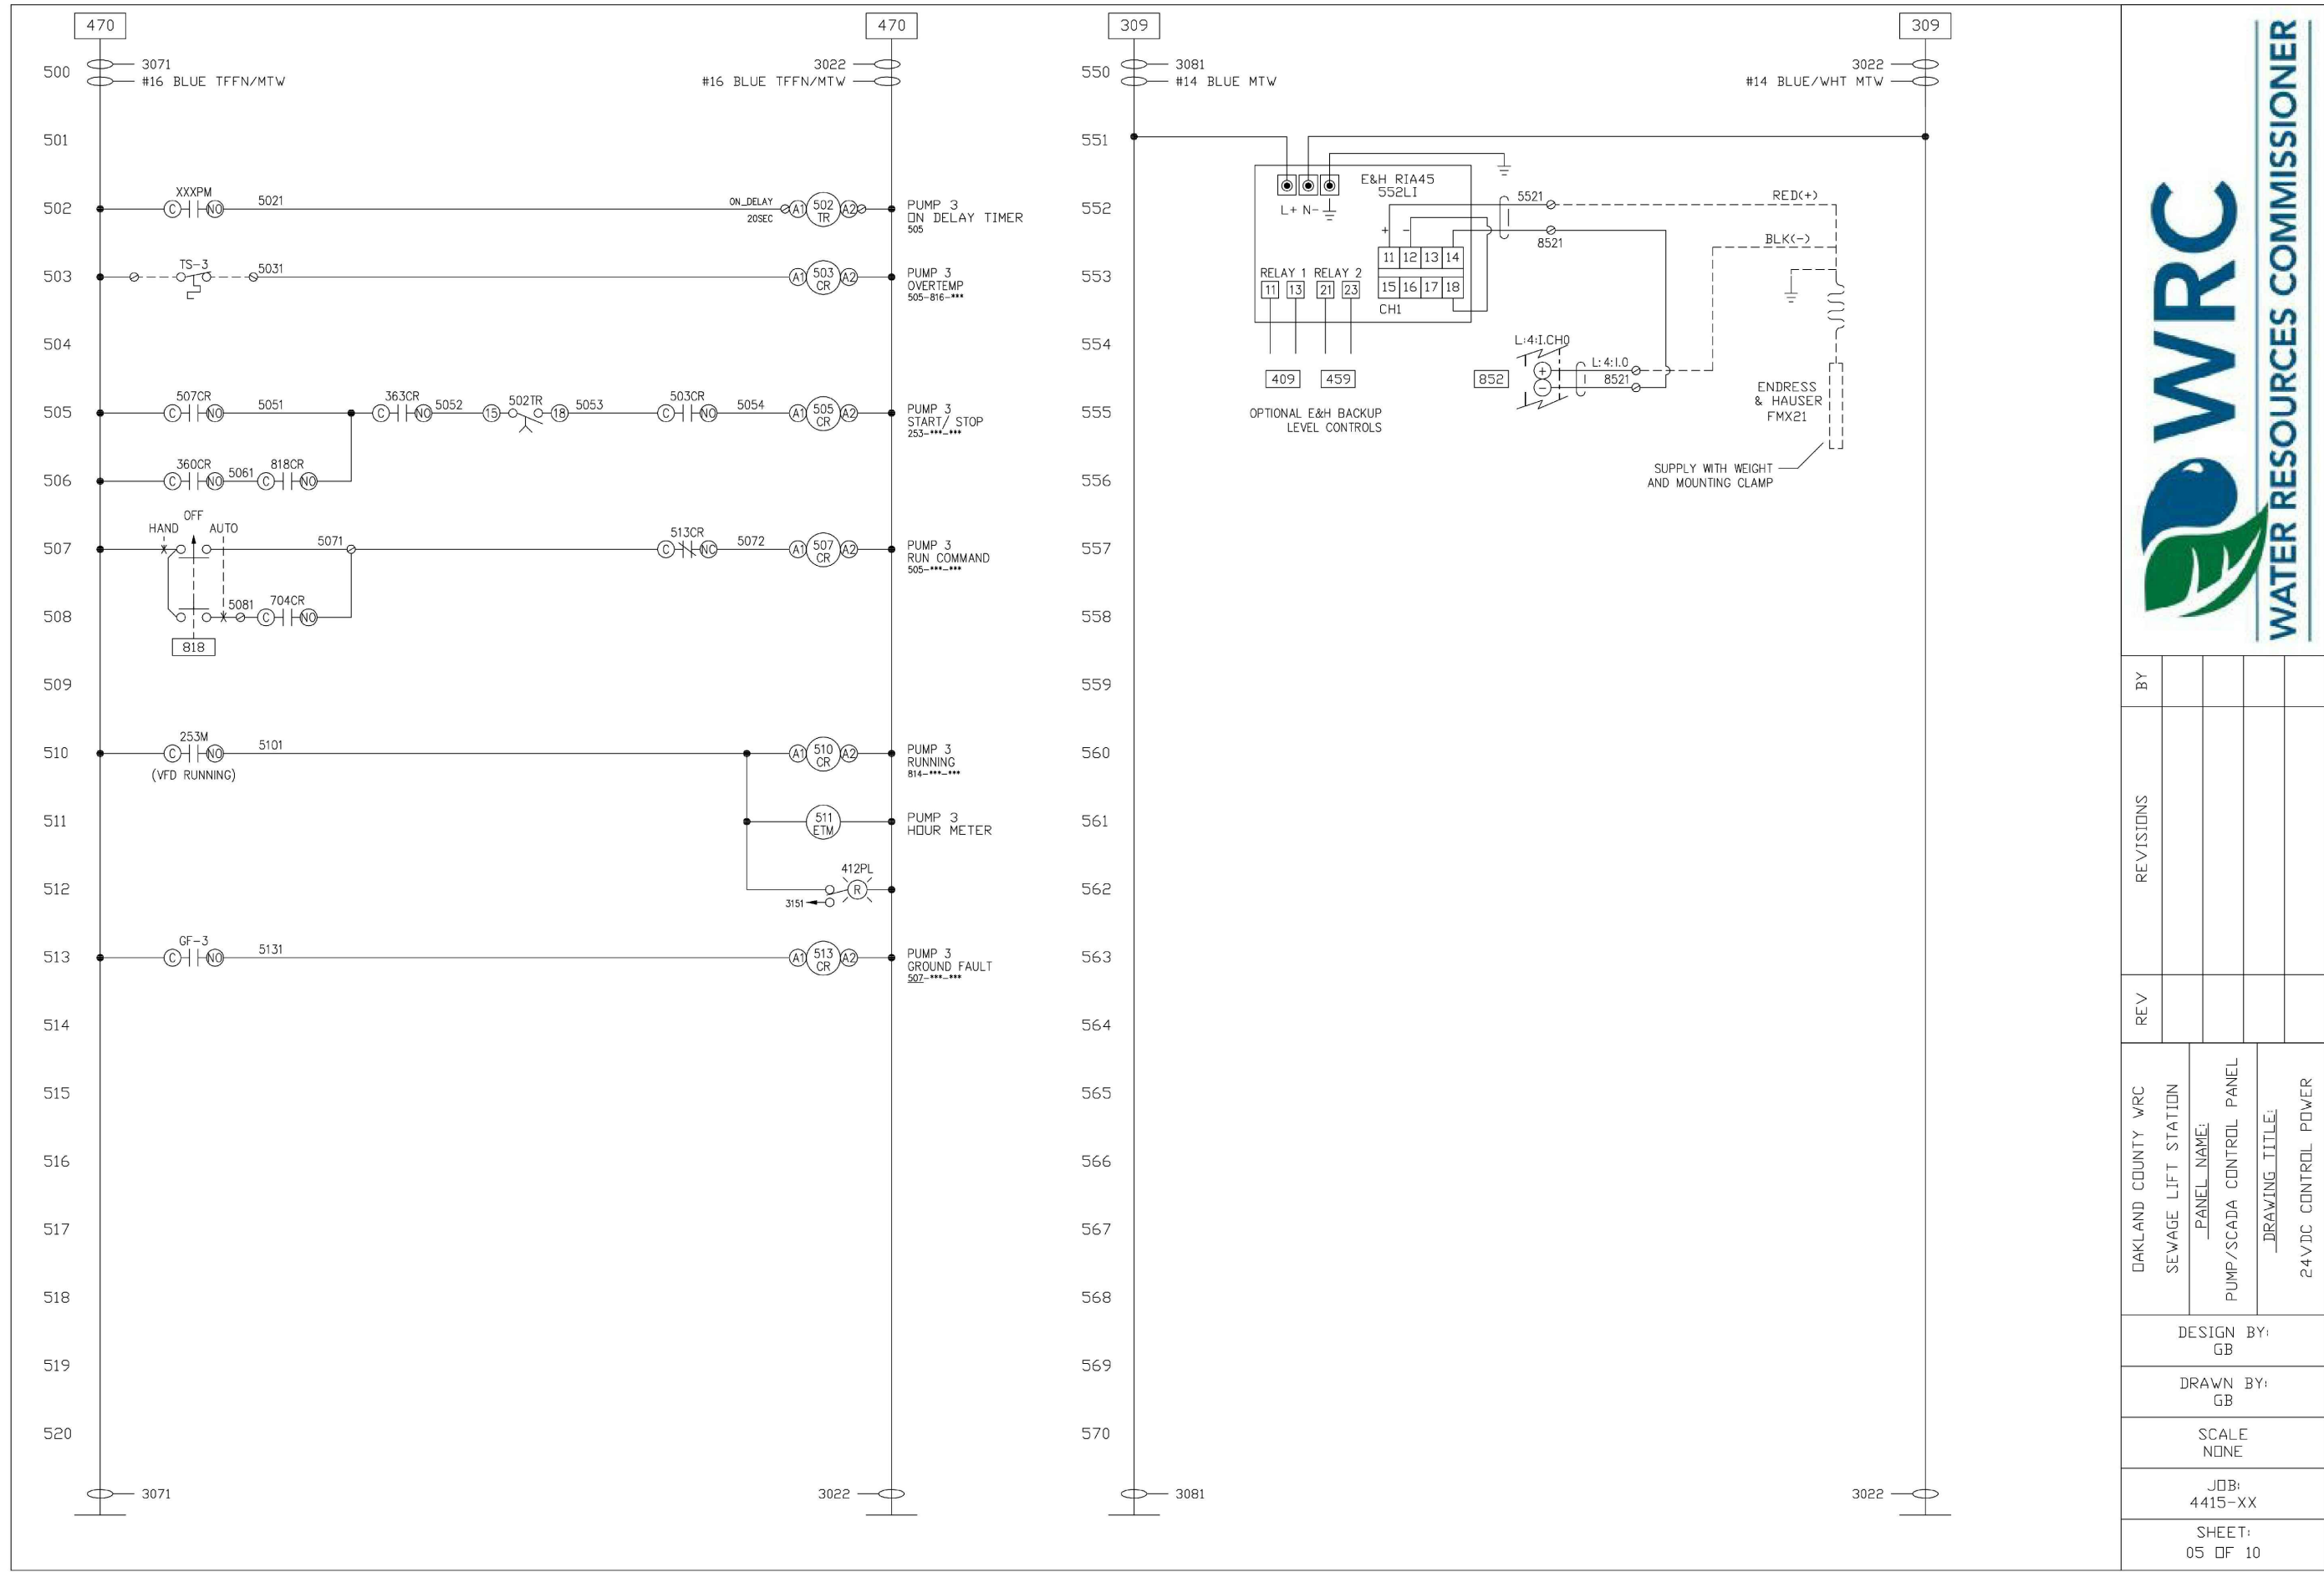

DETAIL OF PLC I/O WIRING
NO SCALE

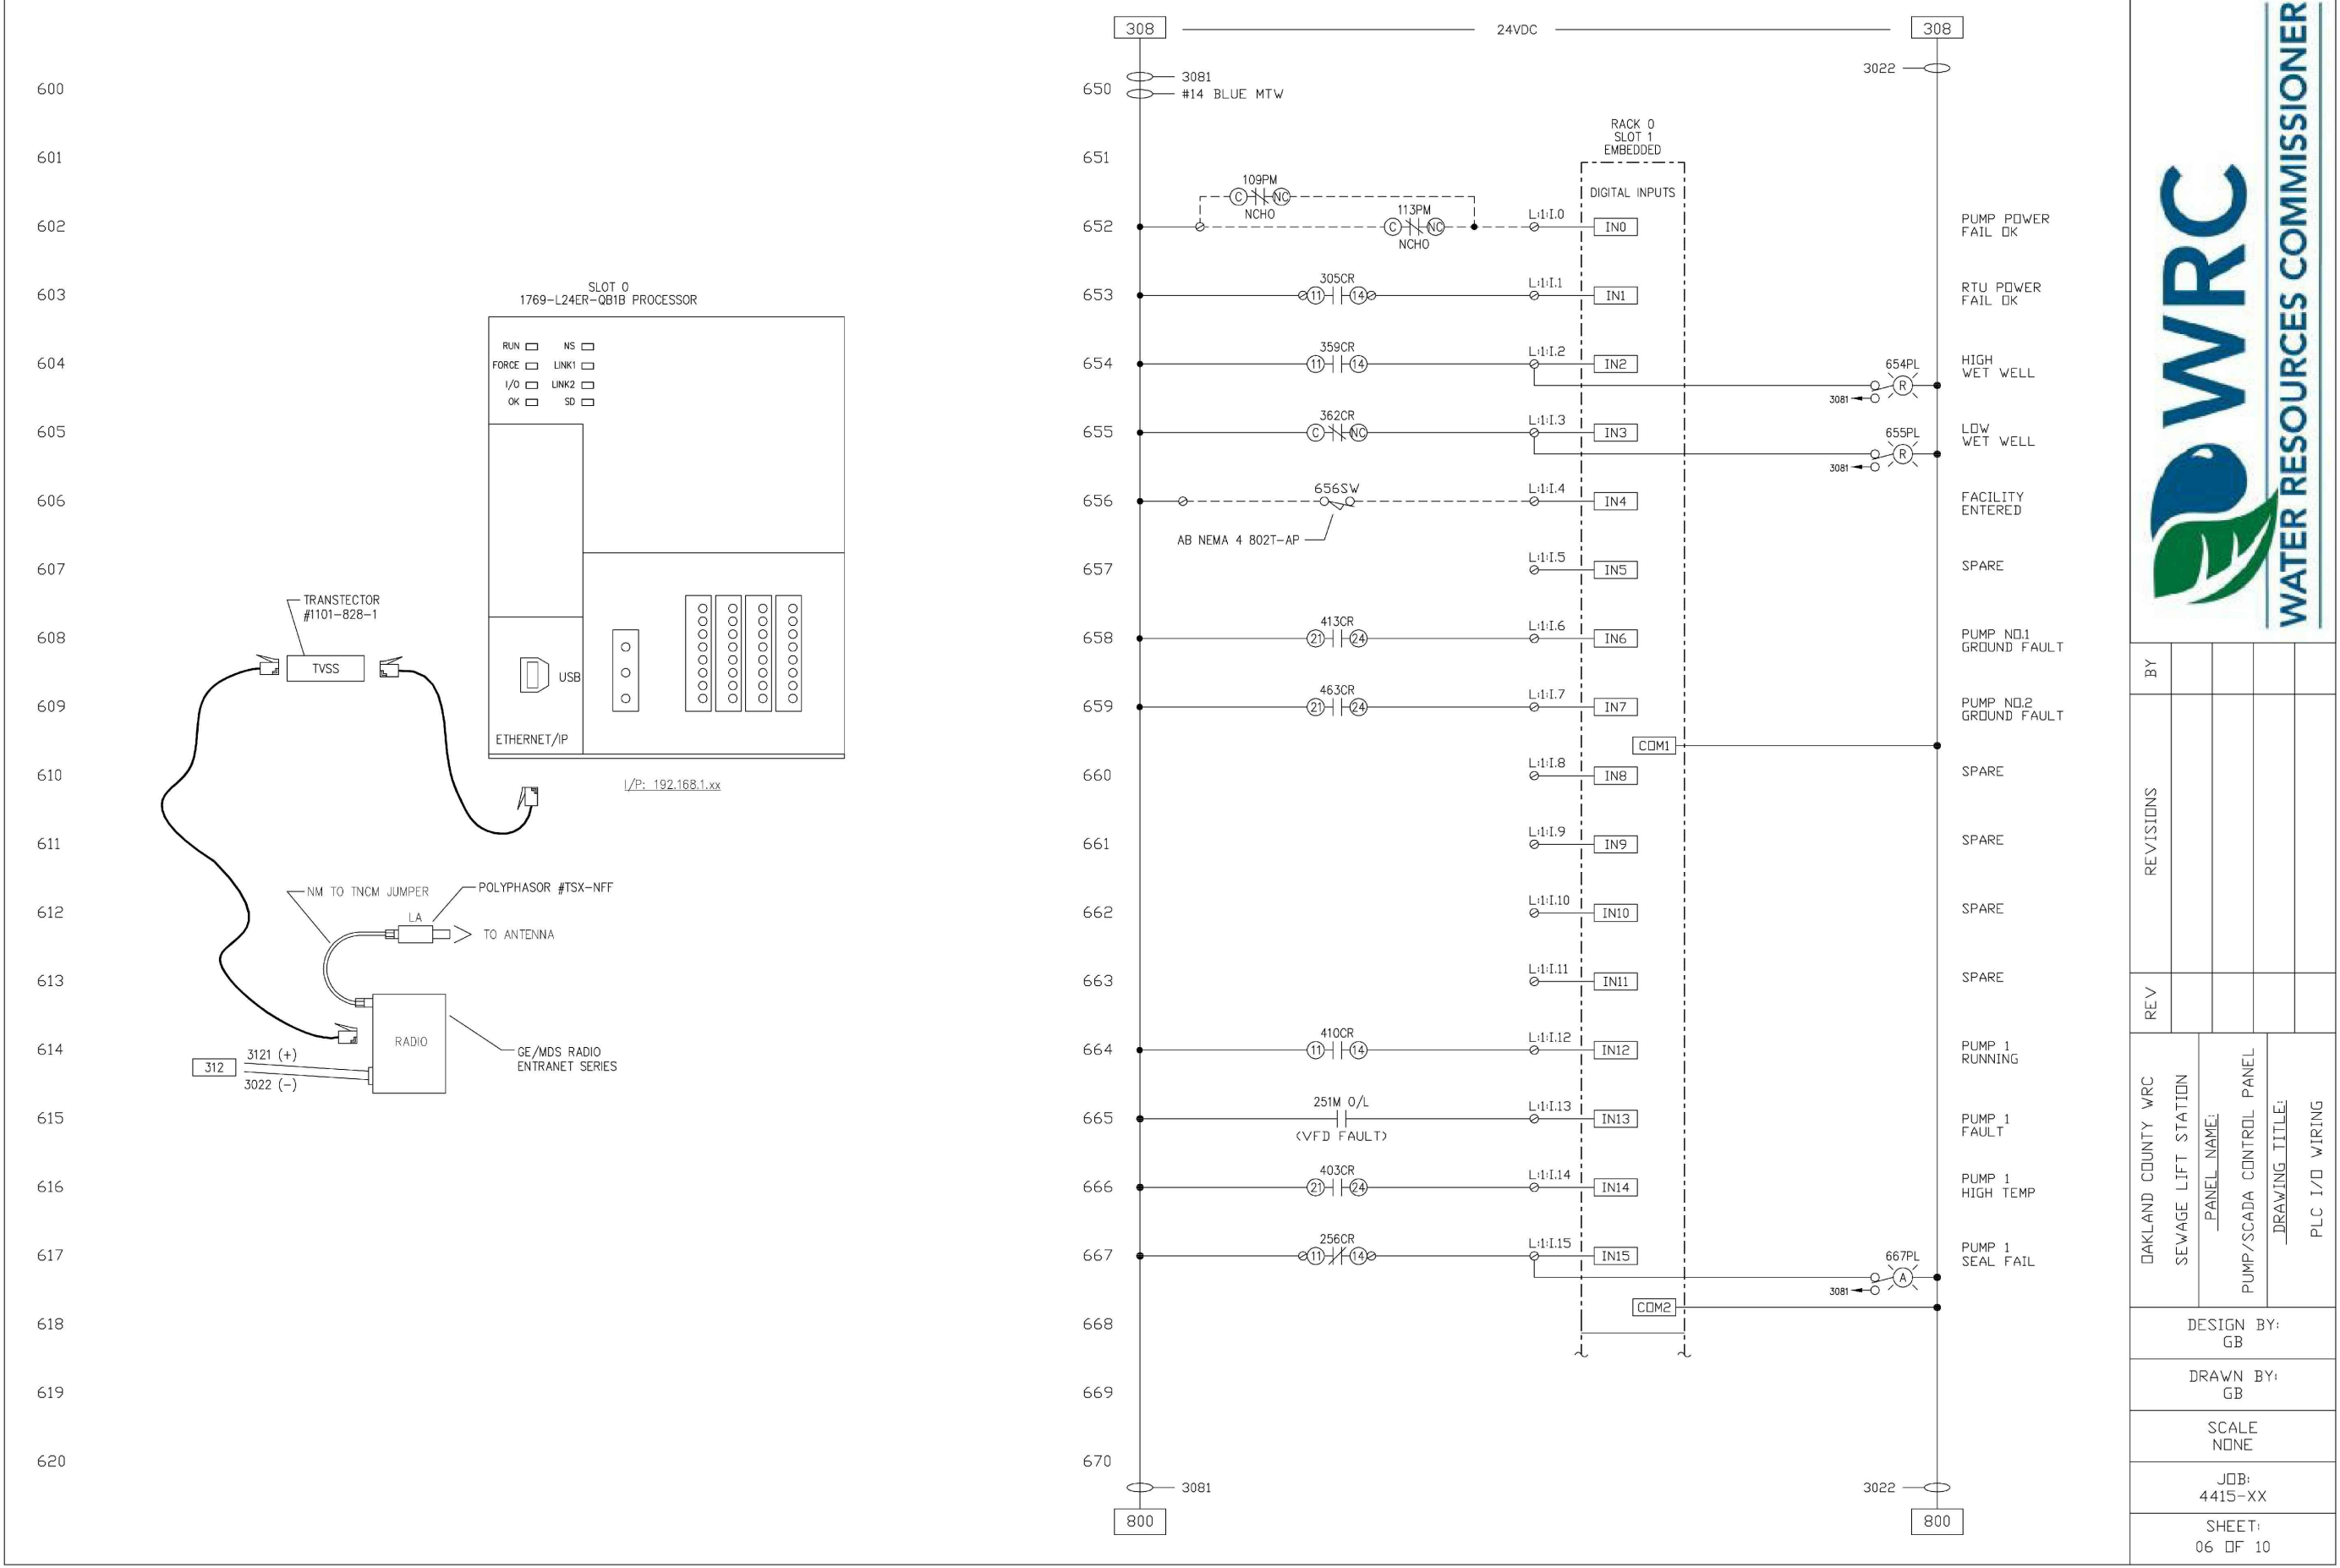

DETAIL OF PLC I/O WIRING
NO SCALE

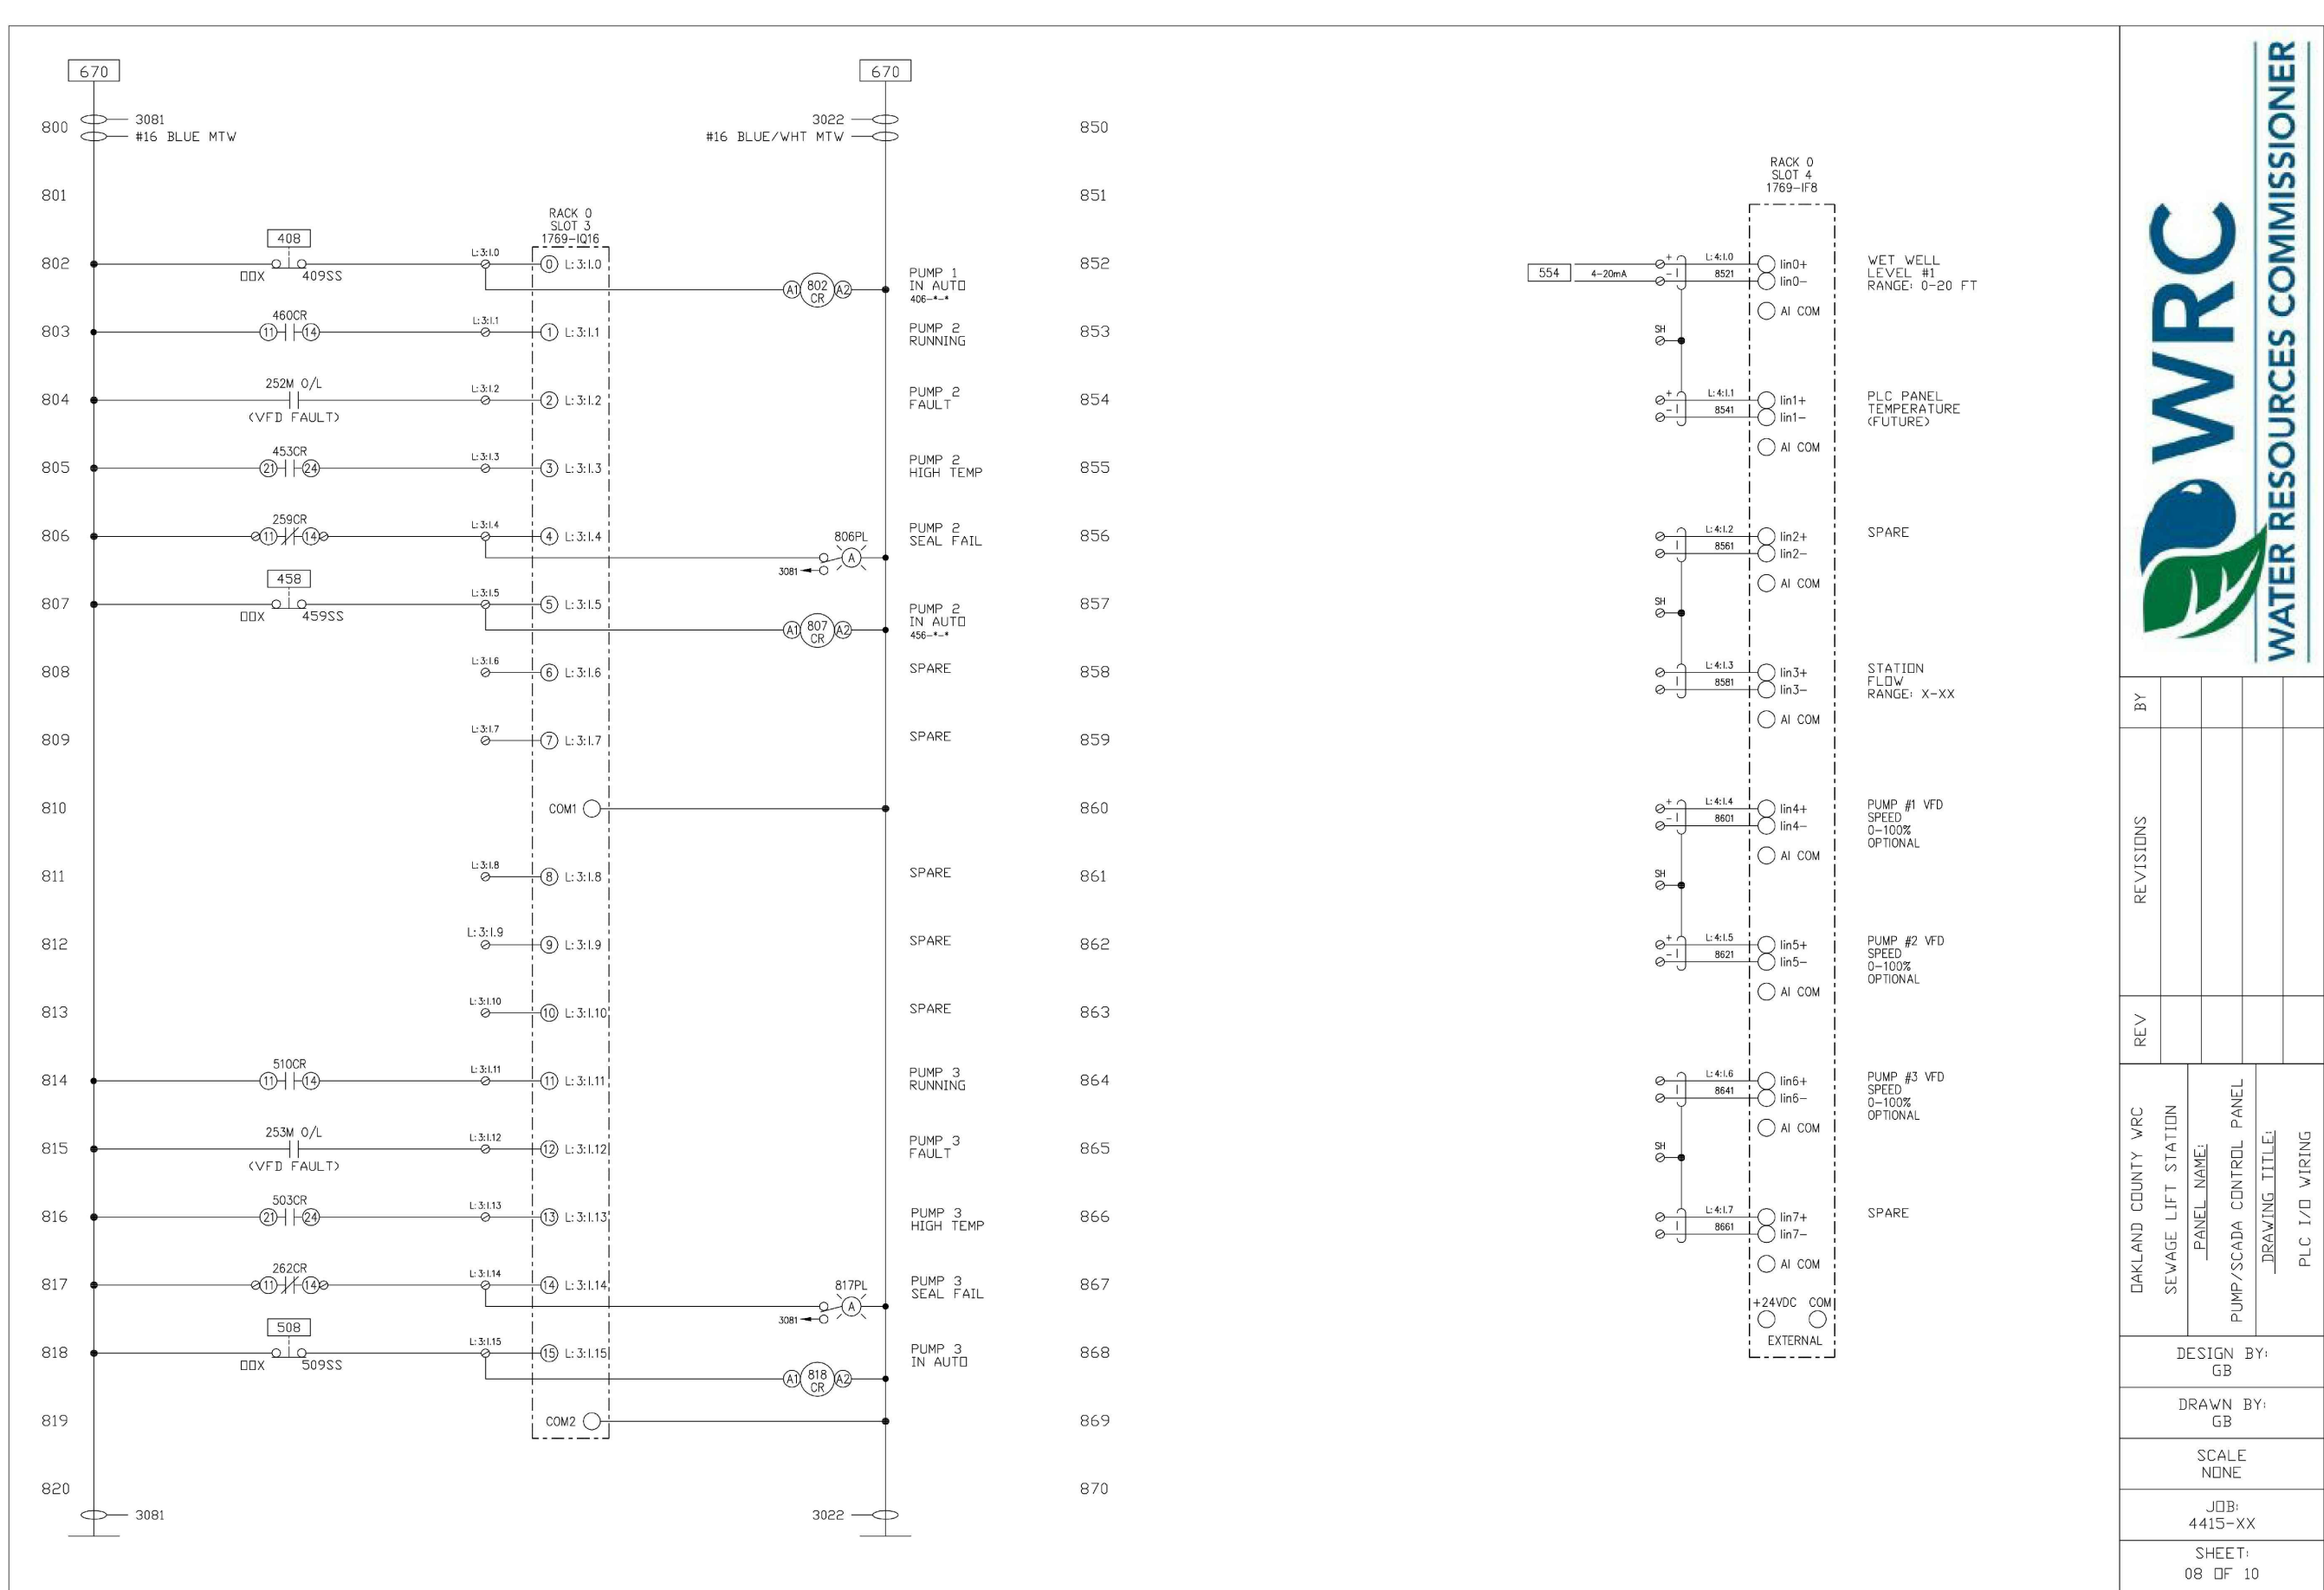

DETAIL OF PLC I/O WIRING
NO SCALE

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The UMLOR Group

LAND DEVELOPMENT SERVICES

SECTION 3

TOWN 1 NORTH, RANGE 8 EAST

CITY OF NOVI

OAKLAND COUNTY, MICHIGAN

CLIENT:

SCENIC PINES

SINGH DEVELOPMENT, LLC.

7125 ORCHARD LAKE ROAD

BLOOMFIELD HILLS, MICHIGAN 48322

WRC PUMP-SCADA CONTROL PANEL DIAGRAM-2

DATE: 11-27-2019

REVISIONS

PER CITY 03-24-2020

PER CITY 01-18-2021

PER CITY 10-06-2021

DR BY: SDT

CK BY: SDT/MY

P.M. SA

SCALE 0

AS NOTED

JOB NO. 180905

SHEET NO.

31

SHEET 31 OF 38

STATE OF MICHIGAN

WES LEE

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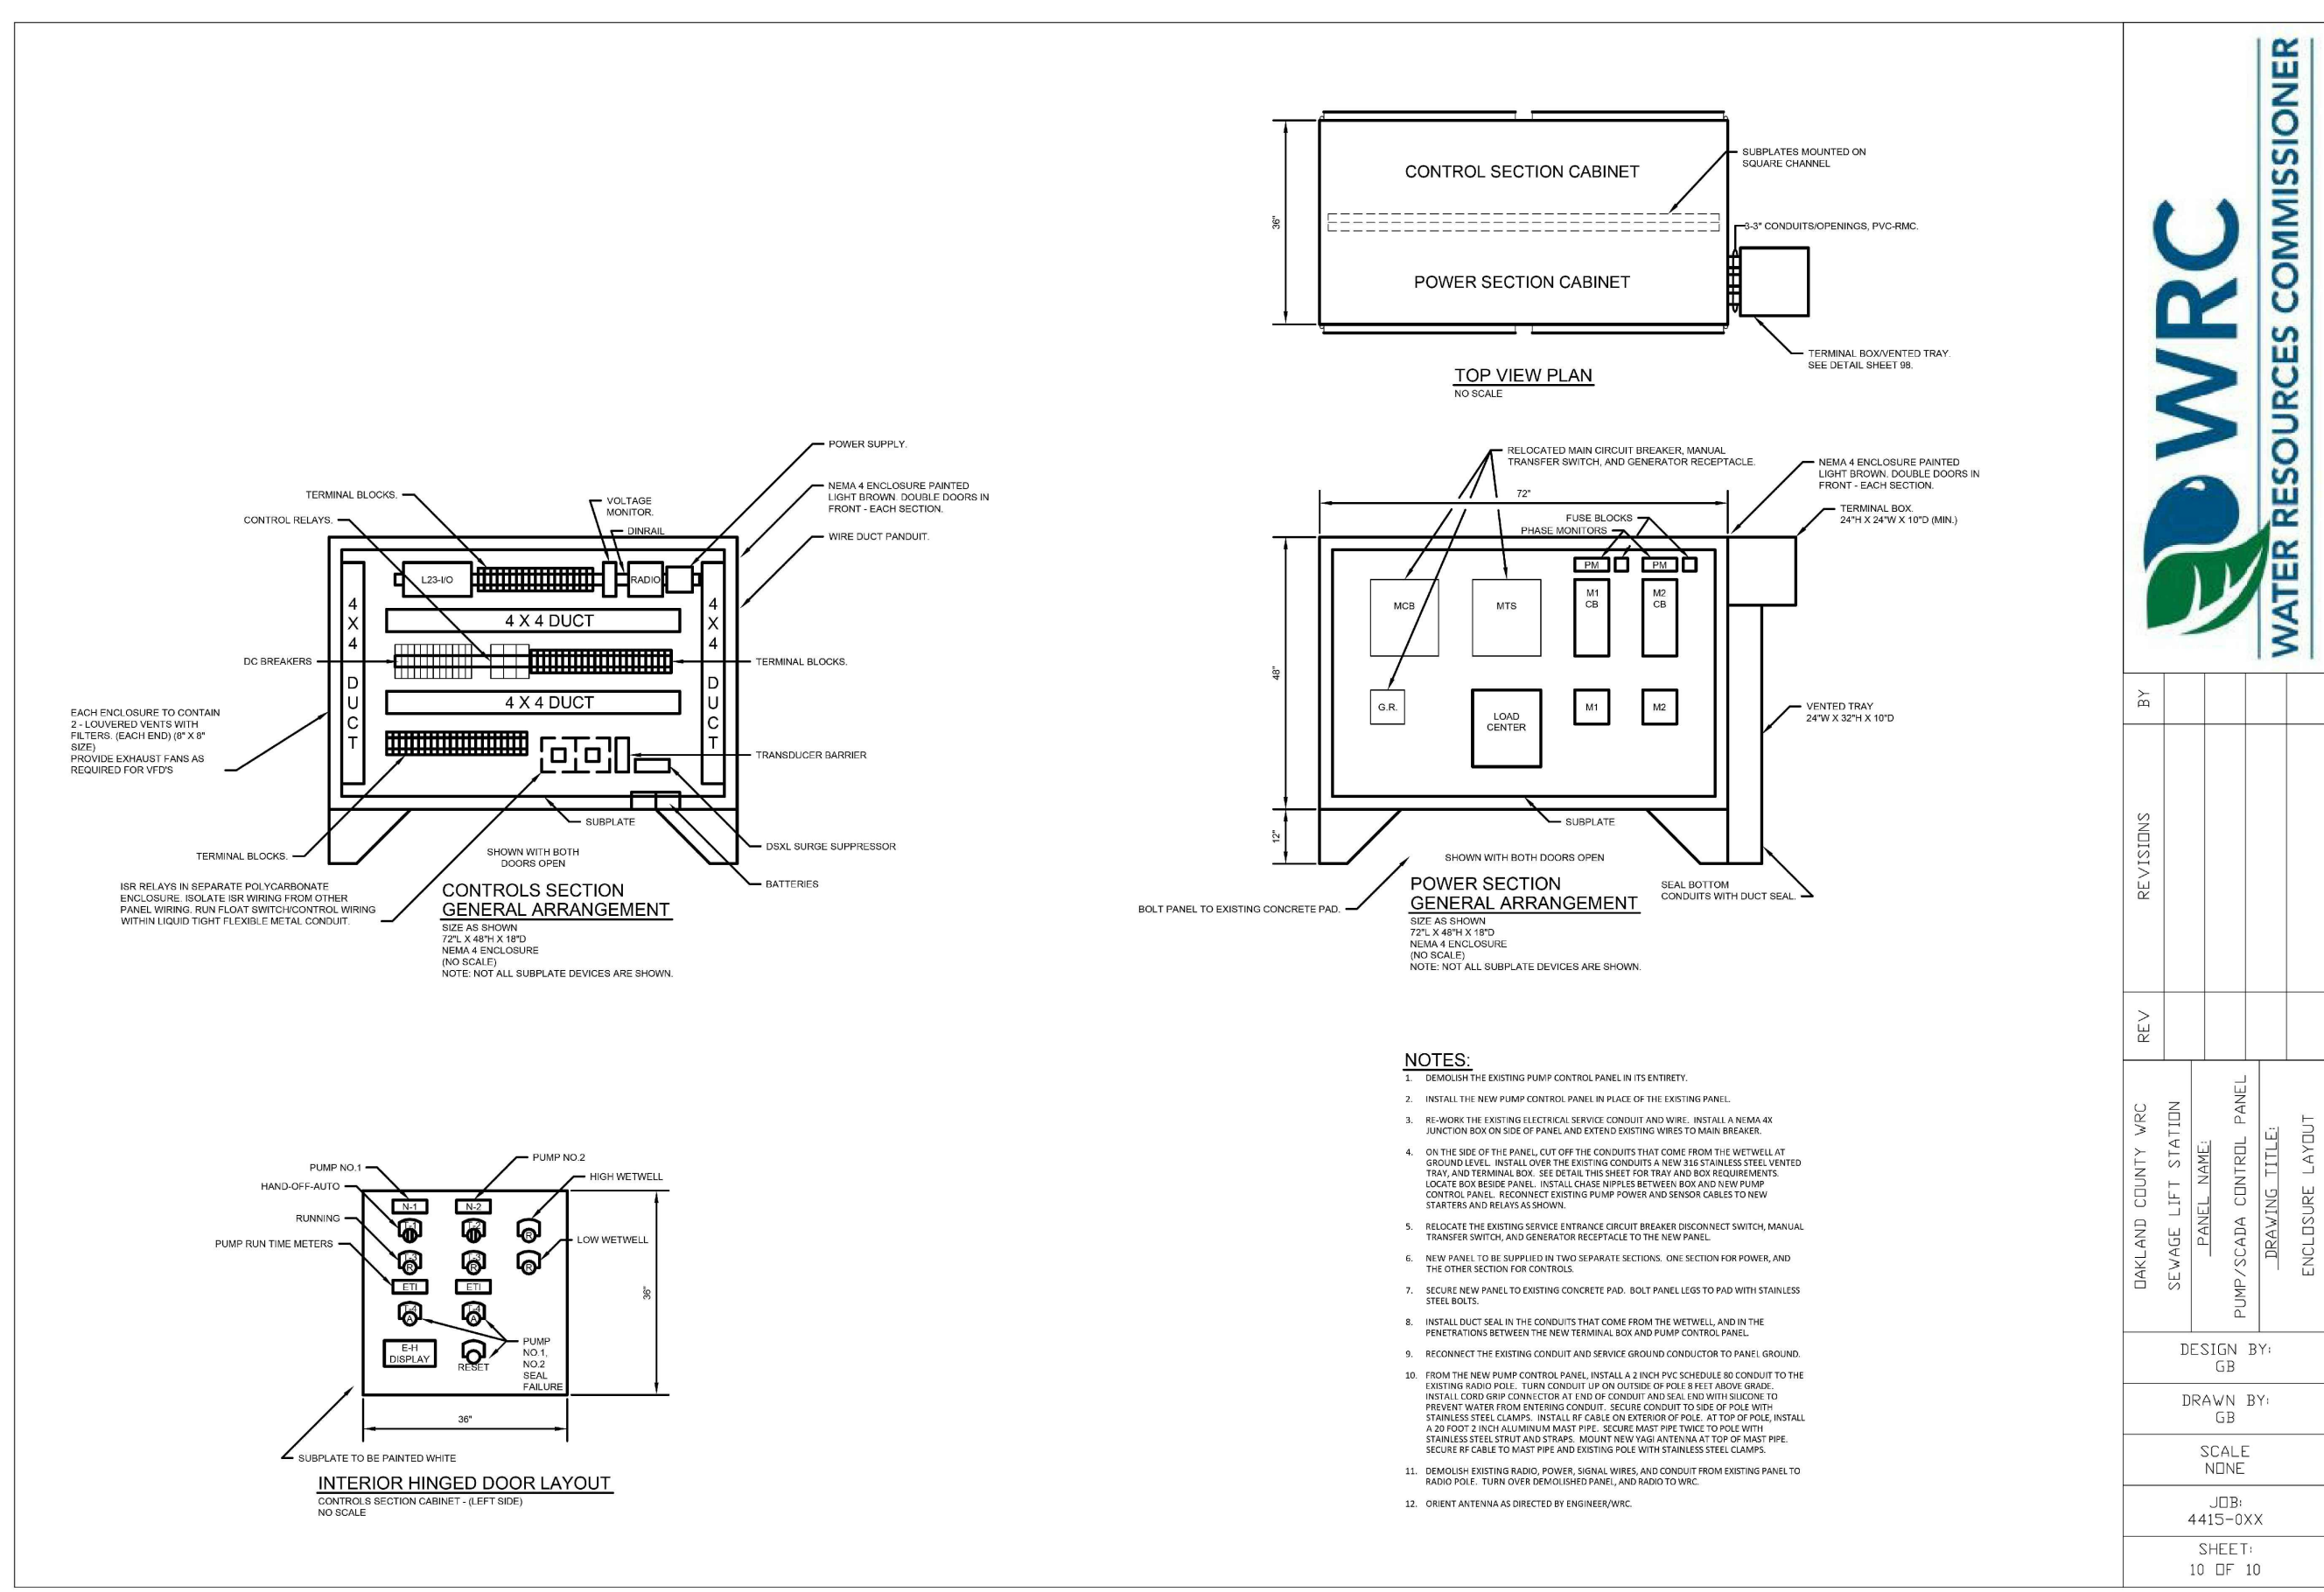
ENG/EE

2201044579

PROFESSIONAL ENGINEER

DETAIL OF ENCLOSURE LAYOUT

NO SCALE



SCENIC PINES	SECTION 3
SINGH DEVELOPMENT, LLC. 7125 ORCHARD LAKE ROAD BLOOMFIELD HILLS, MICHIGAN 48322	TOWN 1 NORTH, RANGE 8 EAST
WRC PUMP—SCADA CONTROL PANEL DIAGRAM—3	CITY OF NOVI
	OAKLAND COUNTY, MICHIGAN

32
SHEET 32 OF 38

M:\UMLOR GROUP PROJECT FOLDERS\SINGH DEVELOPMENT\180905 - SCENIC PINES\DESIGN FILES & PLAN SETS\SCENIC PINES CD\S\180905-STORM&SANITARY SCHEDULES.DWG

LOT NO	FGL	Lead inv elv @ Prprty	Lead Sta along CL of Rd	Lead inv elv @ Riser	Total Lead length	Dia of SL"	Dia of SM(Main)"	Cover b/w SL&SM(ft)	Inv elv of SL @ SM	Pr inv elv of SM@SL	Depth of Risers	Lead Slope	Dpth of Lead @ Prop
1	938.20	927.20	STA. 1+05 PRISTINE	926.34	28.00	6.00	8.00	0.13	926.34	926.21	0.00	3.08%	11
2	939.20	928.20	STA. 1+41 PRISTINE	927.64	28.00	6.00	8.00	0.13	926.48	926.35	1.16	2.00%	11
3	939.20	928.20	STA. 2+10 PRISTINE	926.86	32.00	6.00	8.00	0.13	926.85	926.72	0.01	4.20%	11
4	943.70	932.70	STA. 4+74 PRISTINE	932.18	26.00	6.00	8.00	0.13	928.08	927.95	4.10	2.00%	11
5	944.00	933.00	STA. 5+28 PRISTINE	932.48	26.00	6.00	8.00	0.13	928.30	928.17	4.18	2.00%	11
6	944.00	933.00	STA. 5+55 PRISTINE	932.48	26.00	6.00	8.00	0.13	928.41	928.28	4.07	2.00%	11
7	944.00	933.00	STA. 6+20 PRISTINE	932.48	26.00	6.00	8.00	0.13	928.66	928.53	3.82	2.00%	11
8	944.60	933.60	STA. 1+82 NOBLE RIGHT	933.04	28.00	6.00	8.00	0.13	929.56	929.42	3.48	2.00%	11
9	944.60	933.60	STA. 1+21 NOBLE RIGHT	933.02	29.00	6.00	8.00	0.13	929.31	929.18	3.71	2.00%	11
10	944.20	933.20	STA. 1+00 NOBLE RIGHT	932.62	29.00	6.00	8.00	0.13	929.23	929.10	3.39	2.00%	11
11	944.20	933.20	STA. 0+48 NOBLE RIGHT	932.62	29.00	6.00	8.00	0.13	929.18	929.05	3.44	2.00%	11
12	944.10	933.10	STA. 0+49 NOBLE LEFT	932.52	29.00	6.00	8.00	0.13	929.58	929.44	2.94	2.00%	11
13	944.20	933.20	STA. 1+06 NOBLE LEFT	932.62	29.00	6.00	8.00	0.13	929.80	929.67	2.82	2.00%	11
14	944.60	933.60	STA. 1+27 NOBLE LEFT	933.02	29.00	6.00	8.00	0.13	929.89	929.75	3.13	2.00%	11
15	944.60	933.60	STA. 1+82 NOBLE LEFT	933.02	29.00	6.00	8.00	0.13	930.10	929.97	2.92	2.00%	11
16	944.10	933.10	STA. 1+29 NOBLE LEFT	931.96	57.00	6.00	8.00	0.13	929.89	929.76	2.07	2.00%	11
17	944.10	933.10	STA. 0+77 NOBLE LEFT	931.96	57.00	6.00	8.00	0.13	929.69	929.55	2.27	2.00%	11
18	942.30	931.30	STA. 4+11 PRISTINE	930.08	61.00	6.00	8.00	0.13	927.84	927.71	2.24	2.00%	11
19	942.30	931.30	STA. 3+62 PRISTINE	930.20	55.00	6.00	8.00	0.13	927.56	927.42	2.64	2.00%	11
20	941.30	930.30	STA. 3+40 PRISTINE	929.14	58.00	6.00	8.00	0.13	927.47	927.33	1.67	2.00%	11
21	941.30	930.30	STA. 2+92 PRISTINE	929.16	57.00	6.00	8.00	0.13	927.28	927.15	1.88	2.00%	11
22	939.60	928.60	STA. 2+04 PRISTINE	926.83	57.00	6.00	8.00	0.13	926.83	926.69	0.01	3.10%	11
23	939.60	928.60	STA. 1+54 PRISTINE	926.54	60.00	6.00	8.00	0.13	926.54	926.41	0.00	3.44%	11
24	938.40	927.70	STA. 1+35 PRISTINE	926.50	60.00	6.00	8.00	0.13	926.46	926.32	0.04	2.00%	10.7
25	938.40	927.50	STA. 0+88 PRISTINE	926.28	61.00	6.00	8.00	0.13	926.27	926.13	0.01	2.00%	10.9

SANITARY LEADS TABLE
NO SCALE

SANITARY SEWER STRUCTURE TABLE									
Number	Type	Size (Dia)	RIM ELV	INV IN	INV OUT	Frame & Cover			
207	SAN MH	4	-	-	929.96	EJIW, #1040-1 ZPT FRAME WITH 1040 AGS			
206	SAN MH	4	943.20	-	929.43	EJIW, #1040-1 ZPT FRAME WITH 1040 AGS			
205	SAN MH	4	943.00	928.97	928.87	EJIW, #1040-1 ZPT FRAME WITH 1040 AGS			
204	SAN MH	4	941.60	927.57	927.47	EJIW, #1040-1 ZPT FRAME WITH 1040 AGS			
203	SAN MH	4	939.61	927.01	926.91	EJIW, #1040-1 ZPT FRAME WITH 1040 AGS			
202	SAN MH	4	938.50	926.56	926.46	EJIW, #1040-1 ZPT FRAME WITH 1040 AGS			
201	SAN MH	4	937.00	925.88	925.88	EJIW, #1040-1 ZPT FRAME WITH 1040 AGS			
200	WET WELL	4	937.70	925.02	931.00	EJIW, #1040-1 ZPT FRAME WITH 1040 AGS			
199	VALVE VAULT BOX	8" X 7"	-	931.00	931.00				

SANITARY STRUCTURE TABLE
NO SCALE

Xing No	LOT No	Lead I.E @ Prop	Lead I.E @ Storm	Lead Prp to Strm	T/P Lead	Storm Inv elev	Strm Dia	Strm B/Pipe	Clearance
1	25	927.50	927.14	18.00	927.77	932.49	8.00	932.35	4.58
2	24	927.70	927.46	12.00	928.09	932.82	8.00	932.68	4.59
3	23	928.60	928.24	18.00	928.87	933.00	8.00	932.86	3.99
4	22	928.60	928.30	15.00	928.93	933.30	8.00	933.16	4.22
5	21	930.30	929.92	19.00	930.55	933.77	8.00	933.63	3.08
6	20	930.30	929.92	19.00	930.55	934.01	8.00	933.87	3.32
7	19	931.30	930.96	17.00	931.59	934.14	8.00	934.00	2.41
8	5	933.00	932.72	14.00	933.35	938.16	8.00	938.02	4.67
9	6	933.00	932.84	8.00	933.47	938.02	8.00	937.88	4.40
10	7	933.00	932.84	8.00	933.47	937.80	8.00	937.66	4.19
11	9	933.60	933.24	18.00	933.87	938.55	8.00	938.41	4.54
12	10	933.20	932.84	18.00	933.47	938.29	8.00	938.15	4.68
13	11	933.10	932.74	18.00	933.37	937.66	8.00	937.52	4.15
14	12	933.10	932.72	19.00	933.35	937.80	8.00	937.66	4.31
15	13	933.20	932.82	19.00	933.45	938.64	8.00	938.50	5.05
16	14	933.60	933.22	19.00	933.85	938.95	8.00	938.81	4.96

SANITARY LEADS & STORM CROSSING TABLE
NO SCALE

UTILITY CROSSING TABLE:

#1 - SANITARY/STORM 8" STM B/P: 937.55 8" SAN T/P: 929.29 CLEARANCE = 8.26'	#6 - WTR/STORM 12" STM B/P: 936.45 8" WM T/P: 934.95 CLEARANCE = 1.50'
#2 - SANITARY/STORM 12" STM B/P: 936.85 8" SAN T/P: 929.89 CLEARANCE = 6.96'	#7 - WTR/STORM 18" STM B/P: 936.25 8" WM T/P: 934.75 CLEARANCE = 1.50'
#3 - WTR/SANITARY 8" WM B/P: 935.79 8" SAN T/P: 930.44 CLEARANCE = 5.35'	#8 - WTR/STORM 12" STM B/P: 936.54 8" WM T/P: 934.95 CLEARANCE = 1.59'
#4 - WTR/STORM 12" STM B/P: 936.52 8" WM T/P: 934.95 CLEARANCE = 1.57'	#9 - WTR/STORM 15" STM B/P: 932.11 8" WM T/P: 930.61 CLEARANCE = 1.50'
#5 - WTR/STORM 12" STM B/P: 936.50 8" WM T/P: 934.95 CLEARANCE = 1.55'	#10 - SAN/WTR 4" SAN B/P: 931.00 8" WM T/P: 929.50 CLEARANCE = 1.5'



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Know what's below.
Call before you dig.

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SECTION 3

TOWN 1 NORTH, RANGE 8 EAST

CITY OF NOVI

OAKLAND COUNTY, MICHIGAN

SCENIC PINES

CLIENT: SINGH DEVELOPMENT, LLC.
7125 ORCHARD LAKE ROAD
BLOOMFIELD HILLS, MICHIGAN 48322

SANITARY STRUCTURE AND LEAD SCHEDULES

DATE: 11-27-2019

REVISIONS

PER CITY 03-24-2020

PER CITY 01-18-2021

OR BY: SDT
CK BY: SDT/MY
P.M. SA
SCALE 0' = 1' AS NOTED
JOB NO. 180905
SHEET NO. 33
SHEET 33 OF 38

STORM SEWER DESIGN CALCULATIONS

NO SCALE

STORM SEWER STRUCTURE TABLE

UTILITY CROSSING PLAN
1 inch = 50ft.



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The UMLOR Group
AND DEVELOPMENT SERVICES

SECTION 3
TOWN 1 NORTH, RANGE 8 EAST
CITY OF NOVI
OAKLAND COUNTY, MICHIGAN


SCENIC PINES

SINGH DEVELOPMENT, LLC.
7125 ORCHARD LAKE ROAD
BLOOMFIELD HILLS, MICHIGAN 48322

**STORM STRUCTURE AND LEAD
SCHEDULE**

DATE: 11-27-2019
REVISIONS
PER CITY 03-24-2020
PER CITY 01-18-202



REVISIONS
PER CITY 03-24-2020
PER CITY 01-18-2020

DR BY: SDT
CK BY: SDT/MY
P.M. SA
SCALE 0  AS NOTED
JOB NO. 180905
SHEET NO. 34

SHEET NO. **34**


SHEET 34 OF 38



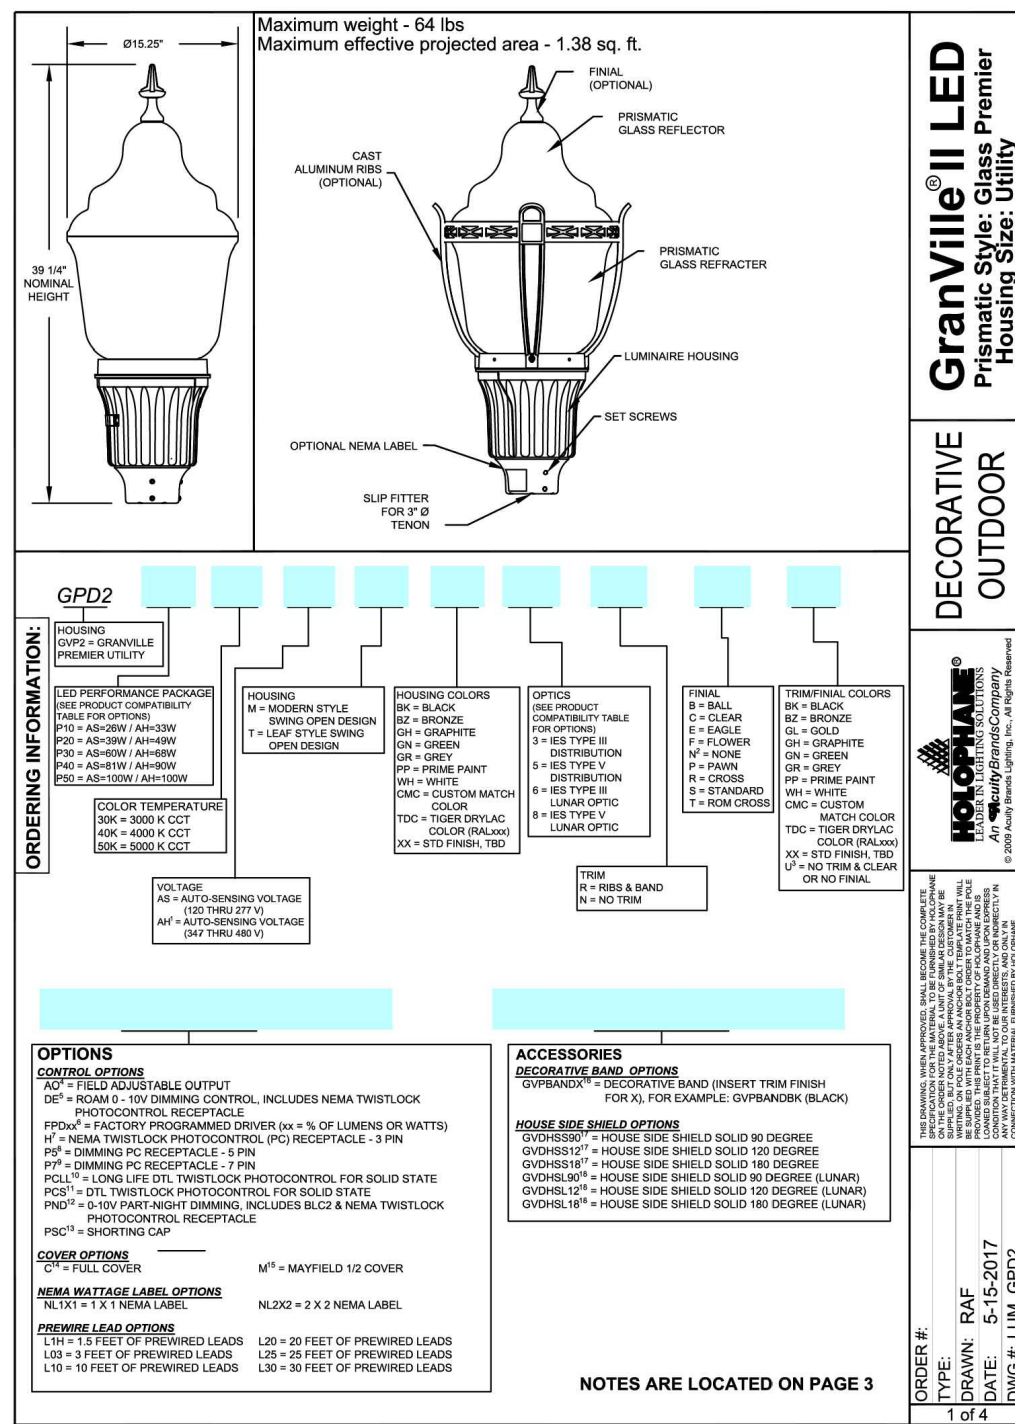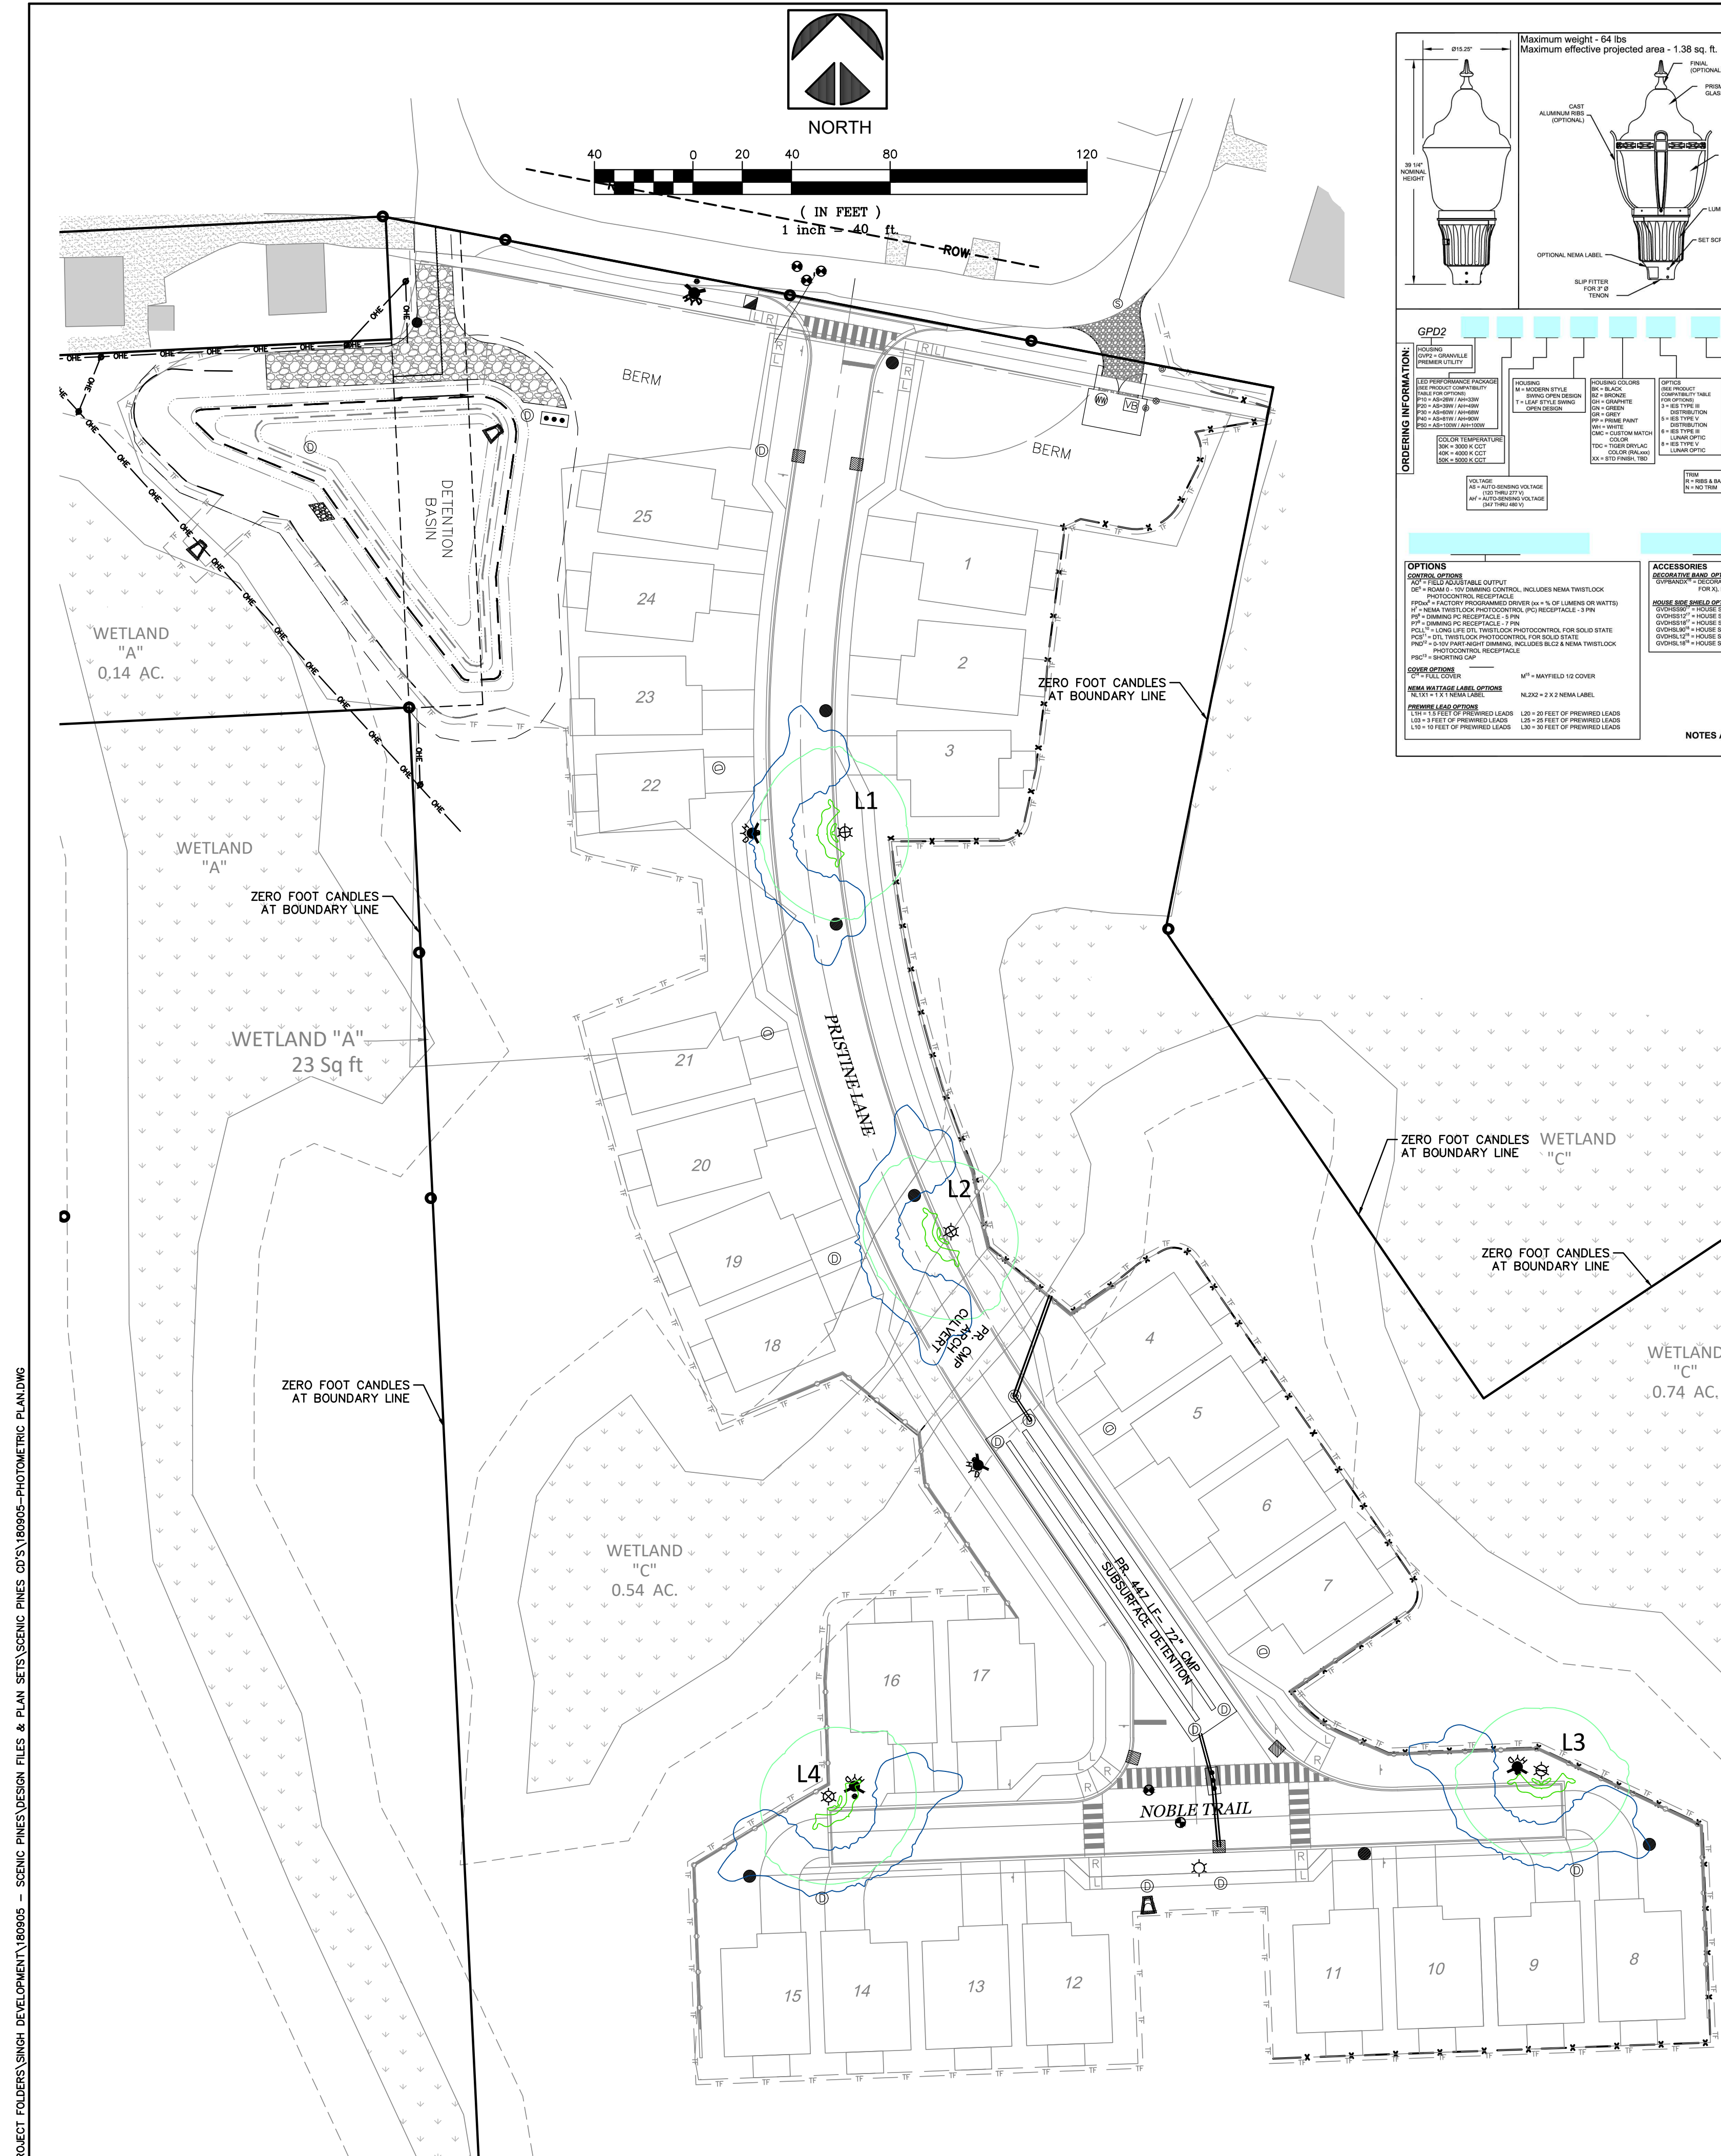

Performance Data																
AS Voltage Option Data																
		System		30K (3000V, 70°C)				40K (4000V, 70°C)				50K (5000V, 70°C)				
LT Package	Distribution	Wattage	Currents	LPW	1 U	4 U	Wattage	Currents	LPW	1 U	4 U	Wattage	Currents	LPW	1 U	4 U
P10	3	26	3.34	127	2	4	3.065	139	1	4	3.065	139	1	4	3	3
	36	3.30	127	2	4	3.065	139	2	4	3.065	139	2	4	3	3	3
P30	3	39	5.64	132	2	5	4.340	139	2	5	4.340	139	2	5	3	3
	36	5.39	128	2	4	2.340	134	3	5	5.340	134	3	4	3	3	3
P40	3	47	7.77	123	2	5	5.640	137	3	5	5.640	137	3	5	3	3
	36	7.016	127	3	5	3.737	133	3	5	7.077	133	3	5	3	3	3
P40	3	81	9.94	113	3	5	8.611	129	3	5	8.611	129	3	5	3	3
	36	8.85	8.620	105	3	5	9.724	124	3	5	9.724	124	3	5	3	3
P50	3	105	12.66	103	3	5	11.061	124	3	5	11.061	124	3	5	3	3
	36	10.50	10.20	103	4	5	10.803	120	4	5	9.784	120	4	5	3	3

AH Voltage Option Data															
LED Package	Distribution	System	30° (3000, 70-PC)				40° (4000, 70-PC)				56° (5000, 20-PC)				
			Lumens	LPW	1-4	5-9	Lumens	LPW	1-4	5-9	Lumens	LPW	1-4	5-9	
P30	F30	3	3,429	304	1	4	3,052	199	1	4	3,605	295	1	4	3
		5	3,130	350	1	4	2,679	205	2	4	3,249	265	2	4	2
		9	3,184	347	2	4	2,722	204	2	4	3,297	264	2	4	2
P30	F30	4	4,983	321	3	4	4,240	197	3	4	5,244	307	3	4	3
		8	7,771	341	4	4	7,665	112	3	4	7,645	112	3	4	3
		9	7,925	341	5	4	7,737	109	3	4	7,677	109	3	4	3
P30	F30	10	9,140	321	3	5	8,611	167	3	5	9,107	167	3	5	4
		15	9,000	382	4	5	8,274	163	3	5	8,764	163	3	5	3
		19	10,475	382	4	5	9,737	163	3	5	10,227	163	3	5	3
P30	F30	20	10,120	382	4	5	9,613	167	4	5	10,371	169	4	5	3
		25	10,120	382	4	5	9,613	167	4	5	10,371	169	4	5	3

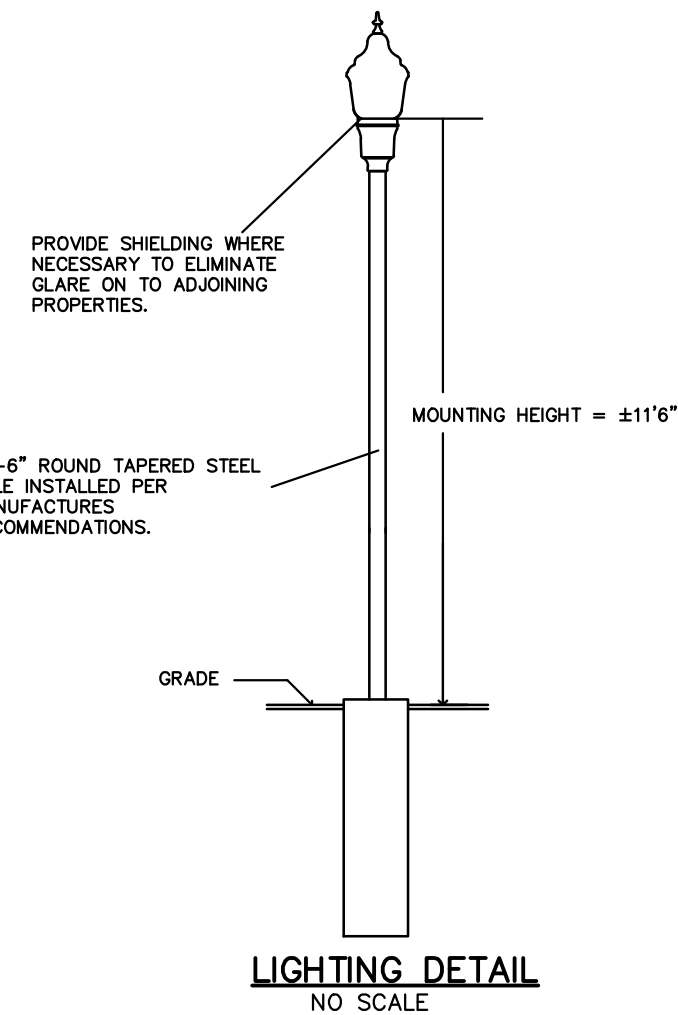[illegible]

- [illegible]

Product Compatibility Table

LUMINAIRE, HOUSING & LED PACKAGE CONFIGURATIONS			
LUMINAIRE	HOUSING	LED PACKAGE	
GP02	M Modern style - Swing open design	P10, P20, P30,	
	T Leaf style - Swing open design	P40, P50	

WATTAGE TABLE			
LED PACKAGE	AS	AN	
P10	35W	37W	
P20	50W	49W	
P30	60W	60W	
P40	80W	80W	
P50	100W	100W	

OPTICS/HOUSING/LED CONFIGURATION			
OPTICS	HOUSING	LED PACKAGE	
3	A, C, F, S, M, T	P10, P20, P30,	
5	A, C, F, S, M, T	P40, P50	
6			
8	A, C, F, S, M, T	P10, P20, P30, P40	

Lumen Average Temperature (LAT) Multipliers

Use these factors to determine relative lumen average temperature based on temperatures from 0-40°C (32-104°F).

Average Lumen Ambient Temperature (LAT)		
°C	°F	Multiplier
5	41	1.00
10	50	1.00
15	59	1.00
20	68	1.00
25	77	1.00
30	86	0.95
35	95	0.91
40	104	0.88

Projected LED Lumen Maintenance

Data references the extrapolated performance projections for the platform noted in the TM-21 report, based on 10,000 hours of LED testing tested per IESNA LM-79 and as expected per IESNA TM-21-11.

To calculate L.F.F., use the lumen maintenance factor that corresponds to the desired number of operating hours below. For other lumen maintenance values, consult factory.

Lumen Maintenance - L70 (same for all LED packages)					
Hours	0	25,000	50,000	75,000	100,000
L.F.F.	1.00	0.93	0.88	0.83	0.80


The lumen maintenance data extrapolated from the TM-21 standard:

$E = (LM \times CU) \times (L.F.F.) \times (LTD)$


LM and CU are obtained from published photometry.

NOTE:
SITE LIGHTING WILL OPERATE FROM DUSK UNTIL DAWN.

ADDITIONAL EQUIPMENT:
(4) ROUND TAPERED STEEL POLES -
MOUNTING HEIGHT = $\pm 11'-6"$
PROPOSED POLE SHALL MEET 100 MPH WINDS
RATING

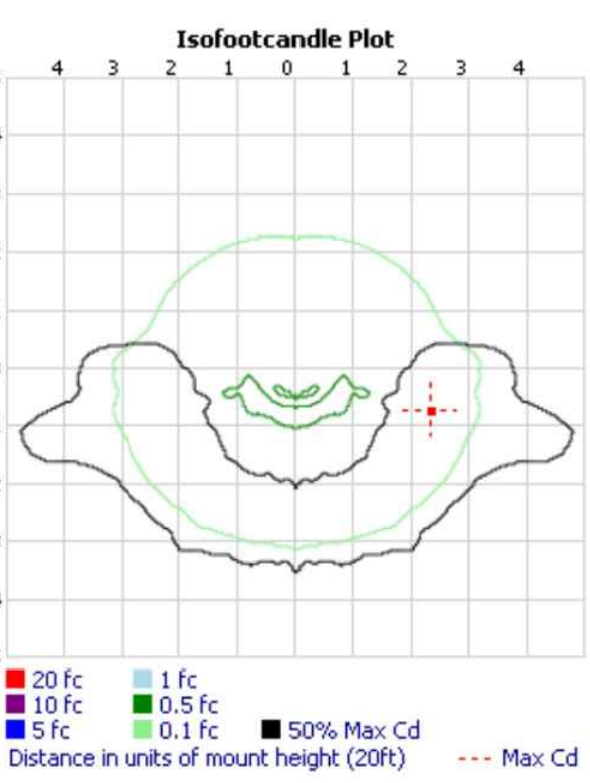

Numeric Summary					
Project: All Projects					
Label		Max	Min	Avg	Ave/Min
GRADE		3.4	0.1	1.0	1.0/0.1

Luminaire Schedule				
Project: All Projects				
Symbol	Qty	Mounting Height	Arrangement	Description
	4	11'-6"	SINGLE POLE	GDP2 P20 50K AS 6 N,LED PKG. 20, 39W, 4000K CCT, AS, M, BK, S, N, S, BK

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The UMLOR Group
LAND DEVELOPMENT SERVICES

SECTION 3
TOWN 1 NORTH, RANGE 8 EAST
CITY OF NOVI
OAKLAND COUNTY, MICHIGAN

SCENIC PINES
HIGH DEVELOPMENT, LLC.
7125 ORCHARD LAKE ROAD
OMFIELD HILLS, MICHIGAN 48322

PHOTOMETRIC PLAN

DATE: 11-27-2019
REVISIONS
PER CITY 03-24-2020
PER CITY 01-18-2021

DR BY:	SDT
CK BY:	SDT/MY
P.M.	SA
SCALE	
JOB NO.	180905
SHEET NO.	<div style="text-align: center;"> 35 </div>
SHEET 35 OF 38	





Know what's below.
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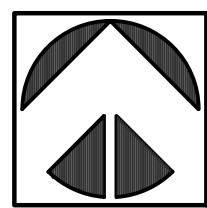
TRACY GALLOWAY
202 BUFFINGTON ST.
NOVI, MI 48377

50-22-03-376-004
ANN STRINGER SMITH
226 HENNING ST.
NOVI, MI 48377

NOVI, MI 48377

50-22-03-377-014
RICHARD GUNTHER
211 HENNING ST.
NOVI, MI 48377

50-22-03-377-011
TODD & LOIS NEFF
217 HENNING ST.
NOVI, MI 48377



NORTH



(IN FEET)
1 inch = 40' ft.

LEGEND


SYMBOL	DESCRIPTION
	PR SIGN
	PR CROSS WALK

SIGN TABLE

SIGN #	SIGN TYPE	REQUIRED
R1-1	STOP (30")	2
D3-2	STREET NAME SIGN	2
R8-3A	NO PARKING (18")	8

NOTE:

- ALL SIGNS & STRIPING WILL COMPLY WITH CURRENT 2011 MMUTCD STANDARDS
- ALL TRAFFIC CONTROL SIGNS WILL COMPLY WITH FHWA STANDARD ALPHABET SERIES.
- ALL TRAFFIC CONTROL SIGNS WILL USE HIGH INTENSITY PRISMATIC (HIP) SHEETING TO MEET FHWA RETRO-REFLECTIVITY REQUIREMENTS
- CITY OF NOVI HAS NO RESPONSIBILITY TO IMPROVE OR MAINTAIN THE PROVATE STREETS WITHIN OR PROVATE STREETS PROVIDING ACCESS TO THE PROPERTY DESCRIBED IN THIS PLAN.

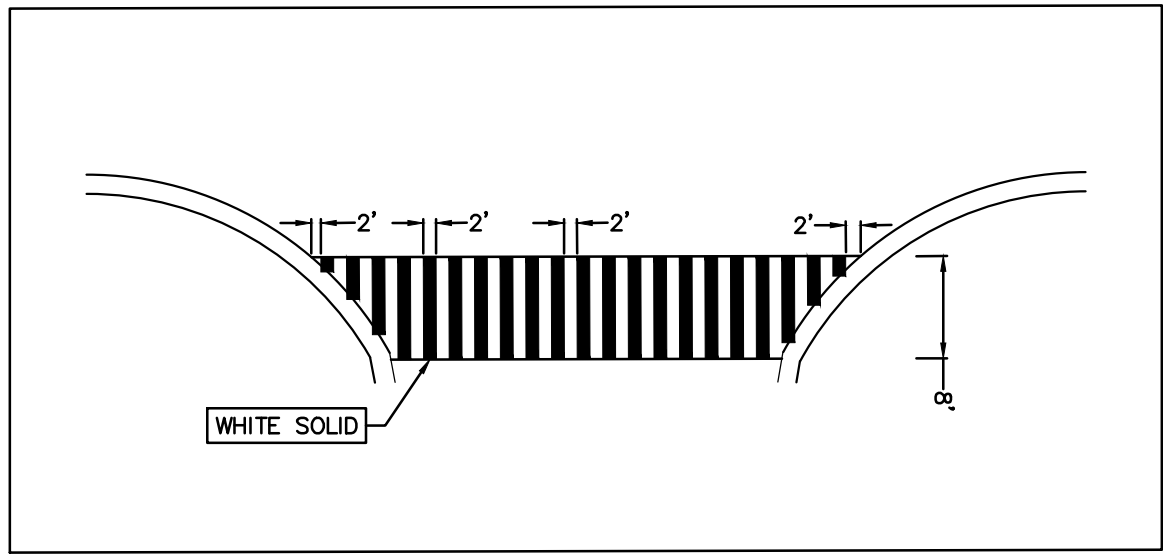

DETAIL OF CROSSWALK
NO SCALE

PROVIDE 2011
MMUTCD 12"x18"

2 LB GALVANIZED
U-CHANNEL SIGN
POST

SIGN NOTE:
MULTIPLE SIGNS AND/OR SIGNS WITH NOMINAL DIMS
GREATER THAN 12" x 18" SHALL BE MOUNTED ON GALVANIZED
3 LB. OR GREATER U-CHANNEL POSTS.

SIGN DETAIL
NO SCALE



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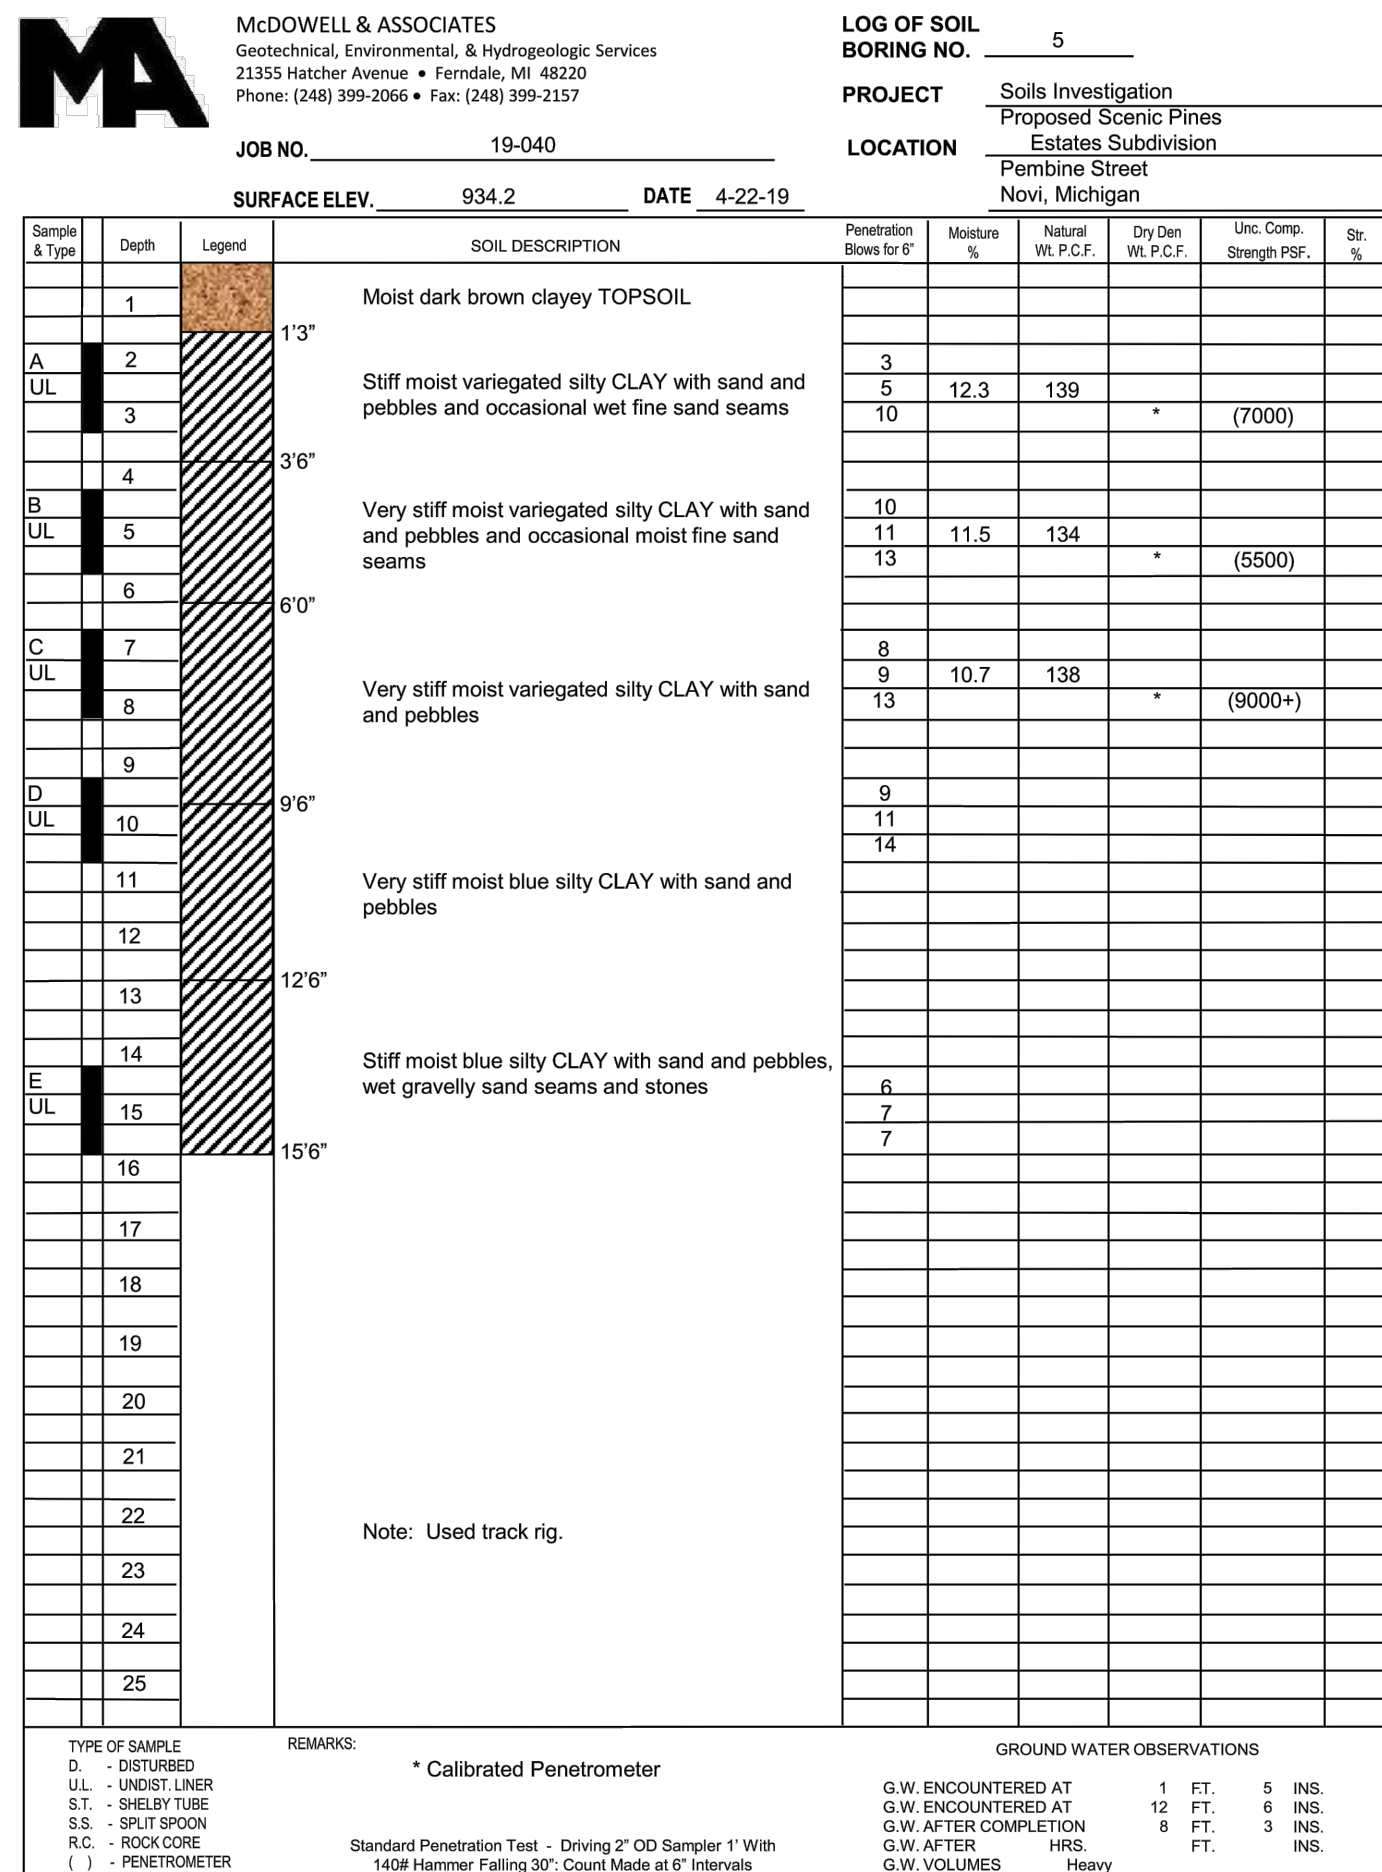
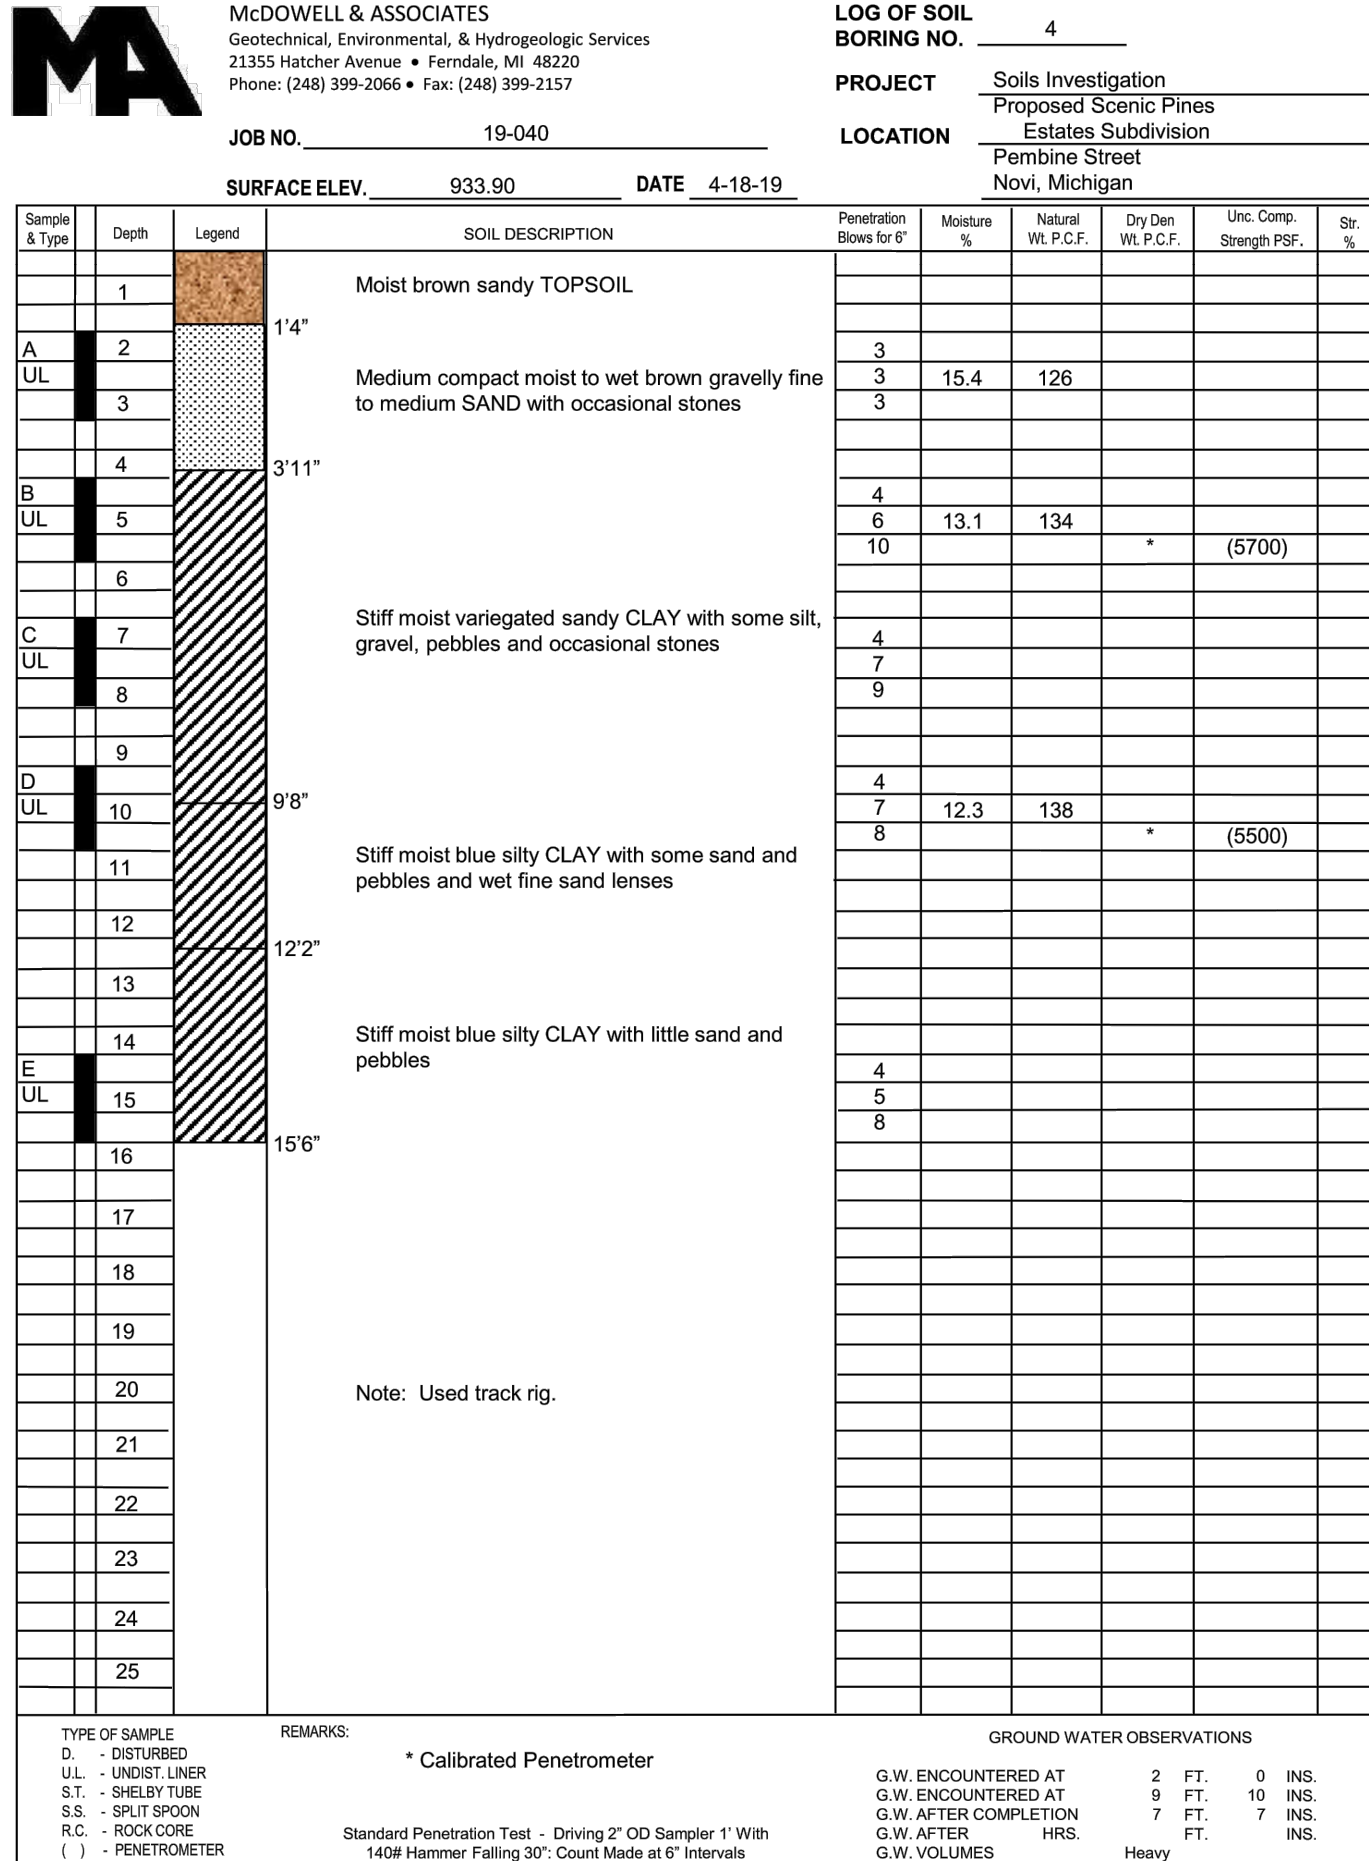
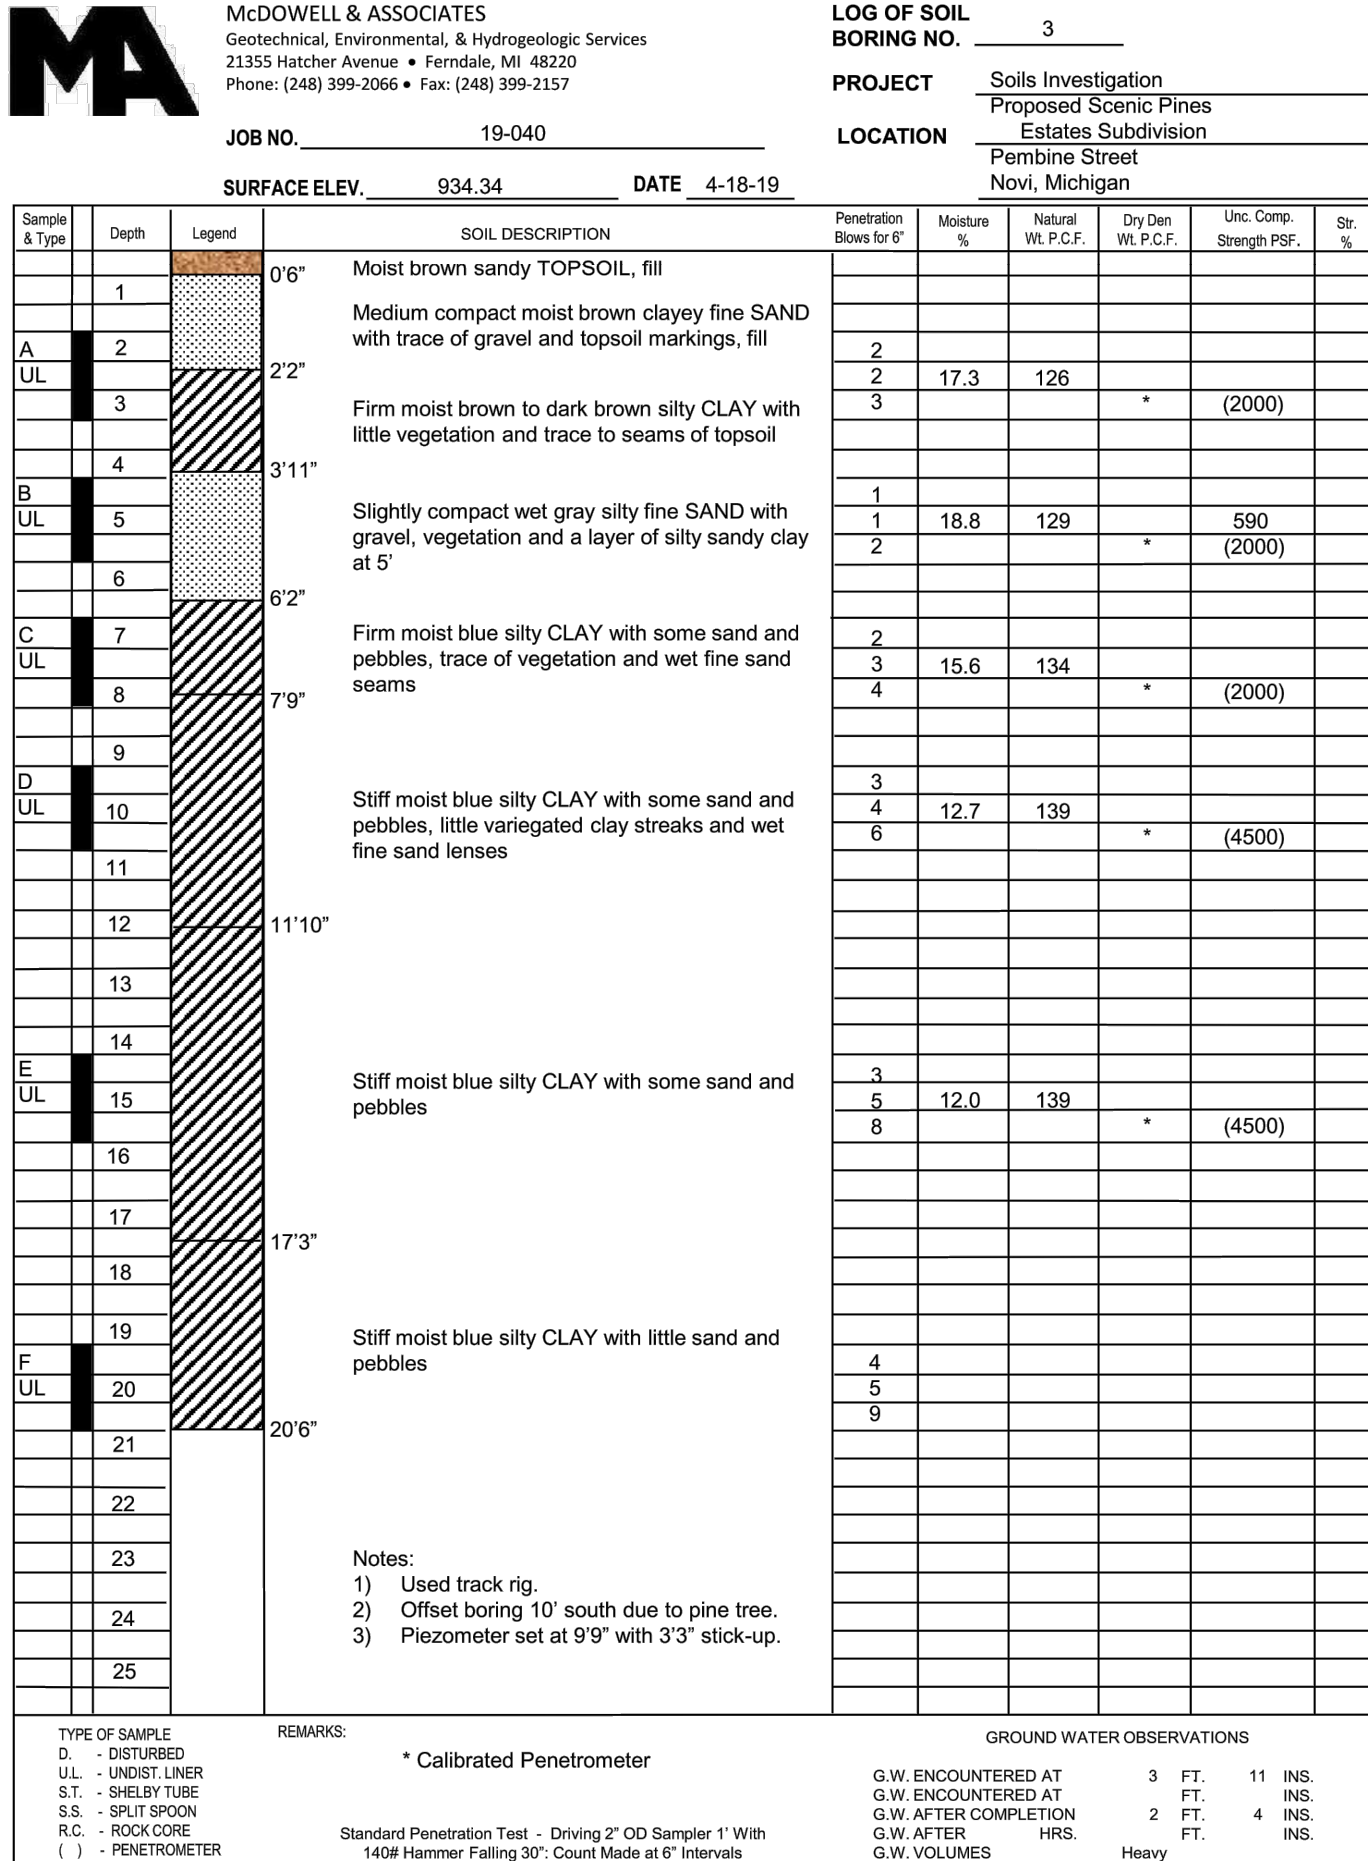
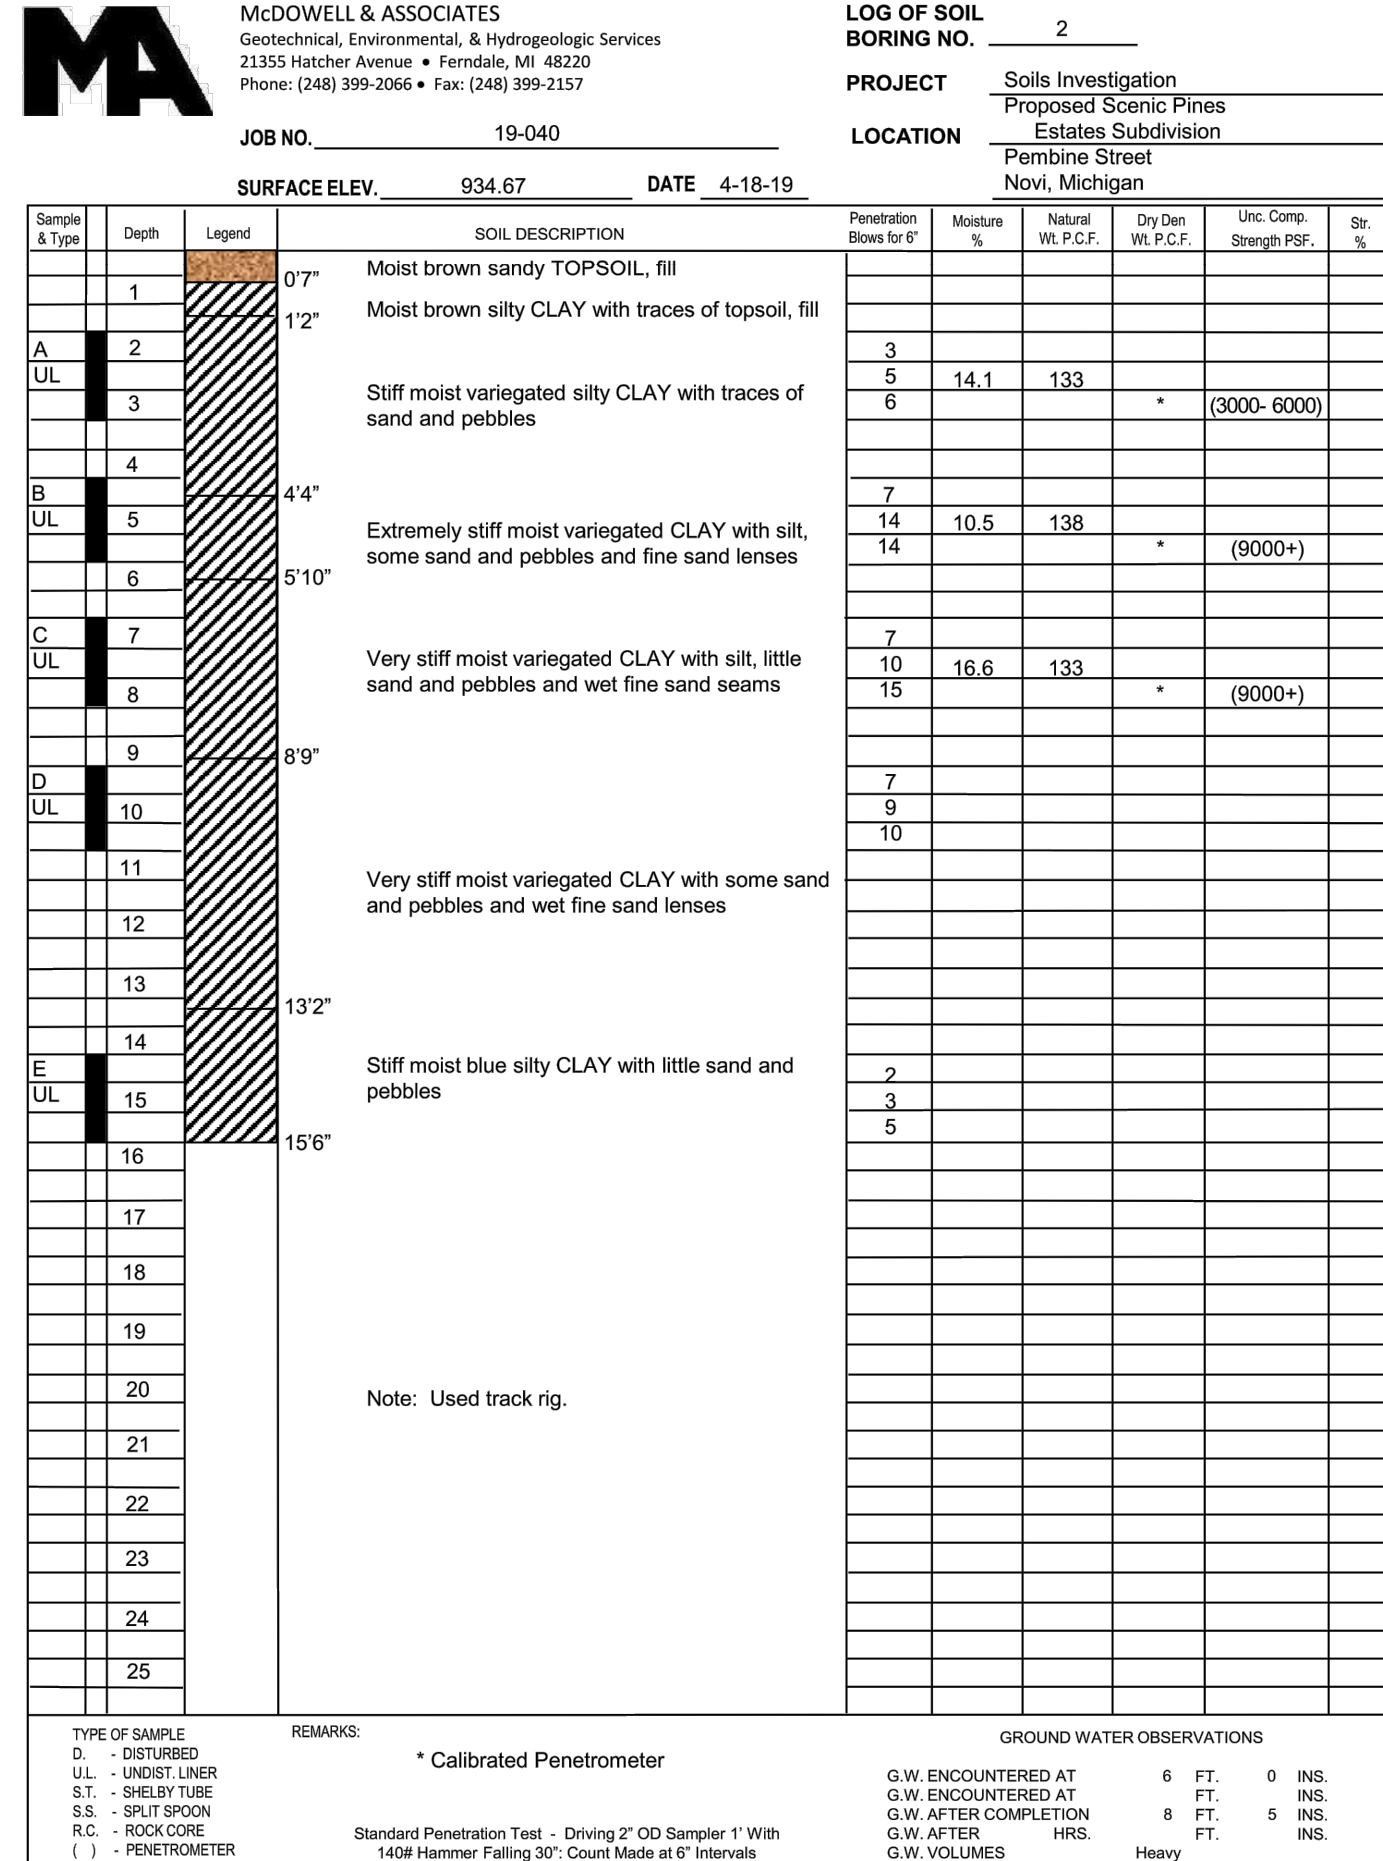
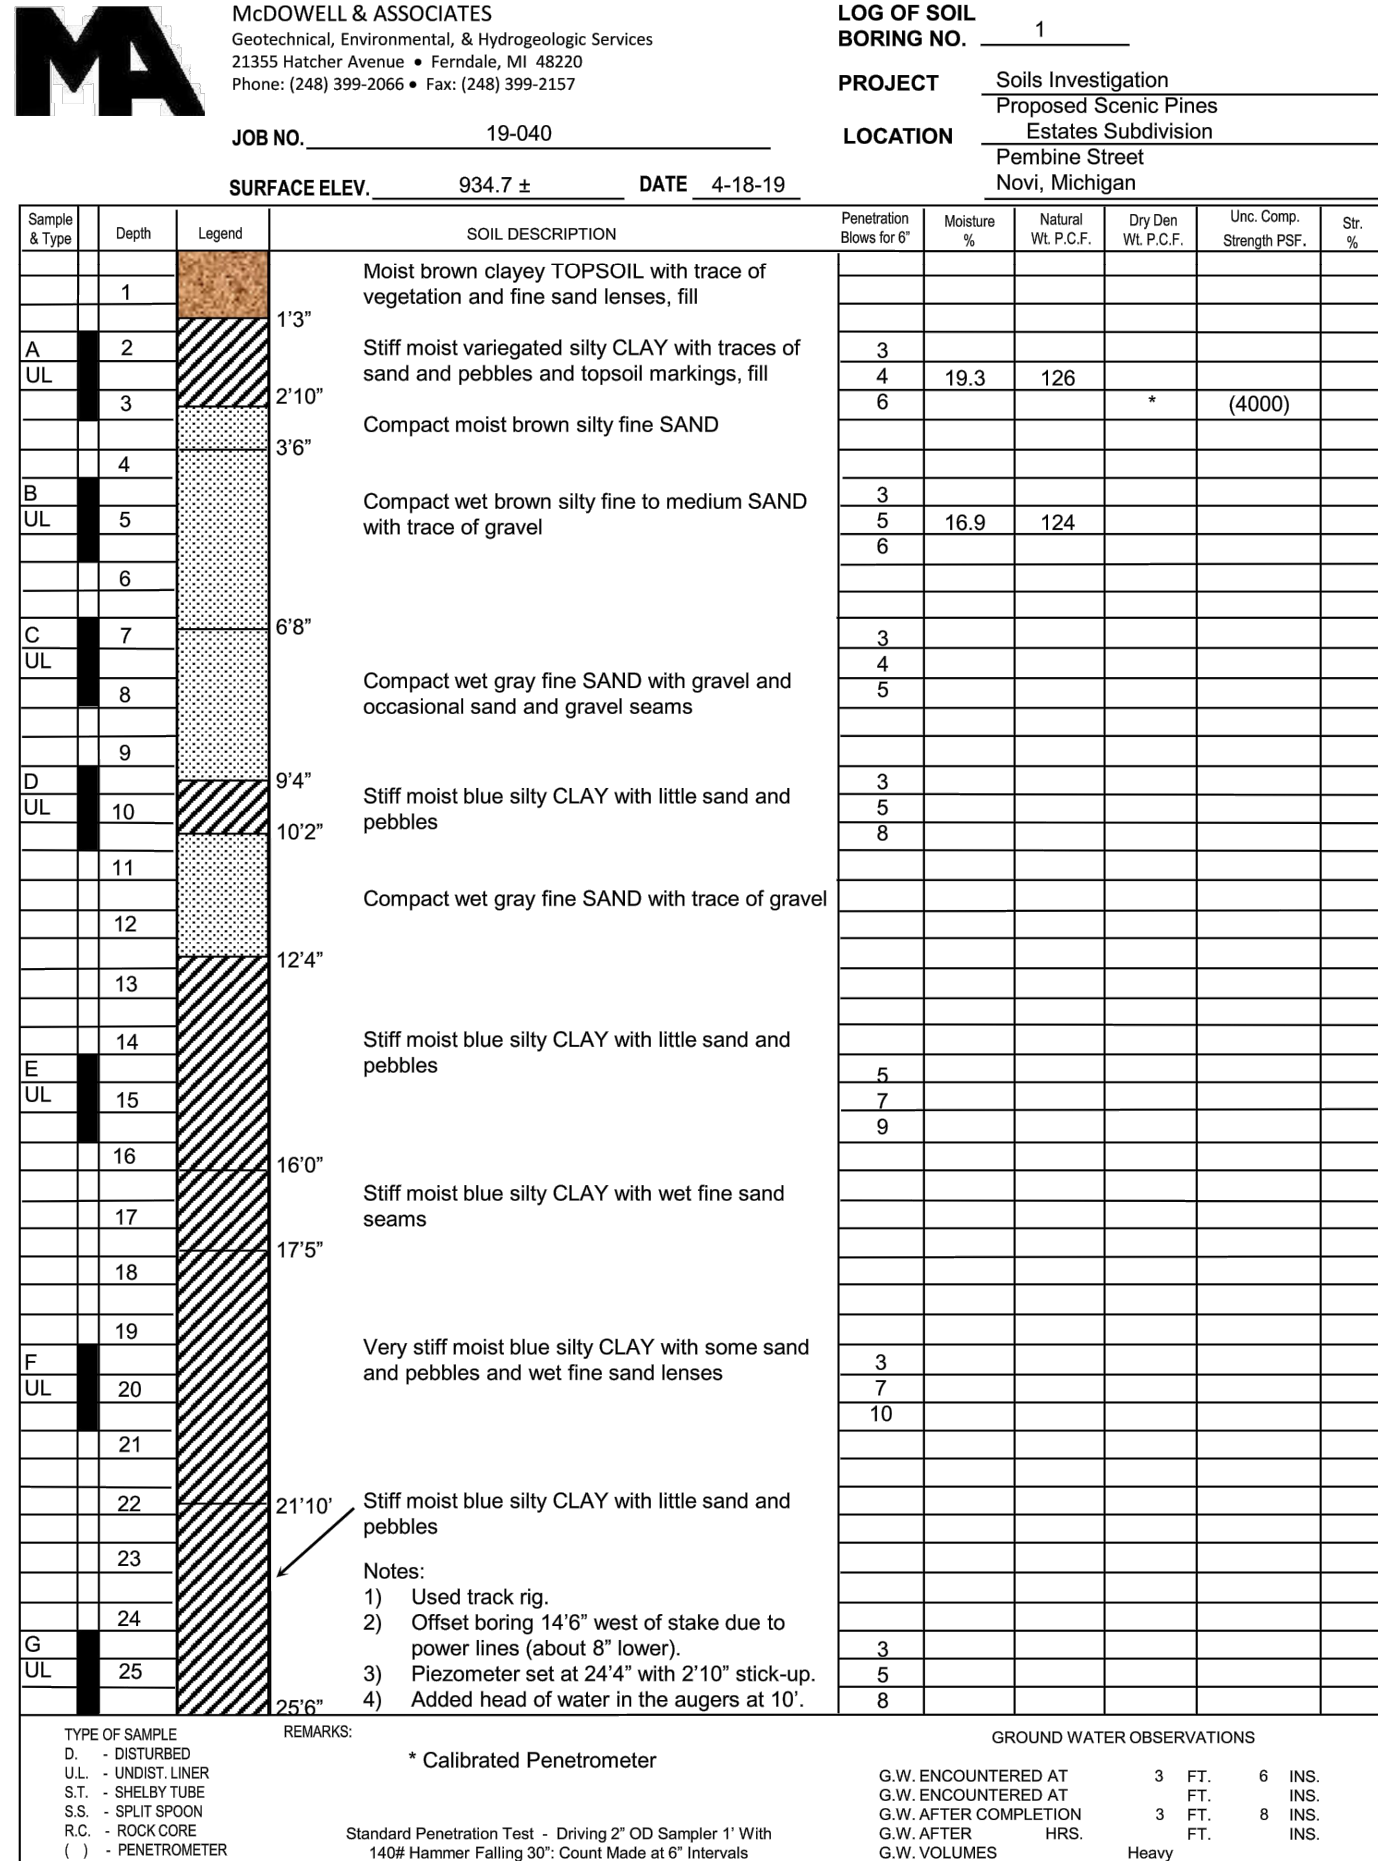
The UMLOR Group
LAND DEVELOPMENT SERVICES


SECTION 3
TOWN 1 NORTH, RANGE 8 EAST
CITY OF NOVI
OAKLAND COUNTY, MICHIGAN

SCENIC PINES
SINGH DEVELOPMENT, LLC.
7125 ORCHARD LAKE ROAD
BLOOMFIELD HILLS, MICHIGAN 48322
TRAFFIC SIGNAGE PLAN

DATE: 11-27-2019
REVISIONS
PER CITY 03-24-2020
PER CITY 01-18-2021

DR BY: SDT
CK BY: SDT/MY
P.M. SA
SCALE 0 20 40
1" = 40 FEET
JOB NO. 180905
SHEET NO.





McDOWELL & ASSOCIATES
 Geotechnical, Environmental, & Hydrogeologic Services
 21355 Hatcher Avenue • Ferndale, MI 48220
 Phone: (248) 309-2066 • Fax: (248) 309-2157

LOG OF SOIL BORING NO. 8

PROJECT Soils Investigation
 Proposed Scenic Pines Estates Subdivision

LOCATION Pembine Street
 Novi, Michigan

JOB NO. 19-040

SURFACE ELEV. 933.9

DATE 4-22-19

Sample & Type	Depth	Legend	SOIL DESCRIPTION	Penetration Blows per ft	Moisture %	Natural Wt. P.C.P.	Dry Den Wt. P.C.P.	Ult. Comp. Strength PSF	Str. %
	1		Moist dark brown clayey TOPSOIL						
A UL	2		Compact moist to wet variegated clayey fine SAND with silt and seams of clay	3					
	3	4		16.8	130				
	4								
B UL	5		Firm moist variegated silty CLAY with sand and pebbles and wet gray fine sand seams	4					
	6	5		19.6	125				
	7						*	(3500)	
C UL	8		Soft moist blue silty CLAY with wet fine silt seams and organics	1					
	9	1		25.6	124				
	10	1							
D UL	11		Medium compact wet gray gravelly silty SAND with occasional trace to seams of silty clay	2					
	12	3		14.1	134				
	13	4							
E UL	14		Stiff moist blue silty CLAY with sand and pebbles	3					
	15	6							
	16	9							
	17								
	18								
	19								
	20								
	21								
	22								
	23								
	24								
	25								

Note: Used track rig.

TYPE OF SAMPLE
 D - DISTURBED
 UL - UNDISTURBED
 S.T. - SHALLOW SPIES
 S.S. - SPIG SPOON
 K.C. - ROCK CORE
 J. - PENETROMETER

REMARKS:

* Calibrated Penetrometer

Standard Penetration Test - Driving 2" OD Sampler 1 With 140# Hammer Falling 30" Count Made at 6" Intervals

GROUND WATER OBSERVATIONS

G.W. ENCOUNTERED AT	3	FT.	5	INS.
G.W. ENCOUNTERED AT	4	FT.	0	INS.
G.W. AFTER COMPLETION	4	FT.	0	INS.
G.W. AFTER	FT.			
G.W. VOLUMES	Heavy			

McDOWELL & ASSOCIATES
Geotechnical, Environmental, & Hydrologic Services
21355 Hitcher Avenue • Ferndale, MI 48220
Phone: (248) 399-2064 • Fax: (248) 399-2157

JOB NO. 19-040

SURFACE ELEV. 934.0+ **DATE** 4-22-19

LOG OF SOIL BORING NO. 9

PROJECT

Soils Investigation

LOCATION

Proposed Scenic Pines Estates Subdivision
Pembine Street
Novi, Michigan

Sample & Type	Depth	Legend	SOIL DESCRIPTION	Penetration Blows per Ft	Moisture %	Natural Wt. P.C.F.	Dry Den Wt. P.C.F.	Unc. Comp. Strength PSF	Str. %
	1		0'3"						
	2								
A UL	3		2'10"						
	4		3'4"						
B UL	5		5'0"						
	6								
C UL	7								
	8								
D UL	9								
	10								
	11								
	12								
	13								
	14								
E UL	15		15'8"						
	16								
	17								
	18								
	19								
	20								
	21								
	22								
	23								
	24								
	25								

Notes:

- 1) Offset boring 16" east of staked location due to large hole filled with water.
- 2) Used track rig.

TYPE OF SAMPLE
D - DISTURBED
UL - UNDISTURBED
S.T. - SHALLOW
S.S. - SHALLOW
R.C. - ROCK CORE
J - REMOTE METER

REMARKS

* Calibrated Penetrometer

Standard Penetration Test - Driving "2" Od Sampler 1' With

GROUND WATER OBSERVATIONS

G.W. ENCOUNTERED AT	2	FT.	10	INS.
G.W. ENCOUNTERED AT		FT.		INS.
G.W. AFTER COMPLETION	6	FT.	0	INS.
G.W. AFTER		FT.		INS.
G.W. VOLUMES	Heavy			

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LOG OF SOIL BORING NO. 10

PROJECT Soils Investigation

Proposed Scenic Pines Estates Subdivision

JOB NO. 19-040

LOCATION Pembine Street

SURFACE ELEV. 934.2

DATE 4/25/2019

Novi, Michigan

Sample # Type	Depth	Legend	SOIL DESCRIPTION	Penetration Blows per F	Moisture %	Natural Wt. P.C.F.	Dry Den Wt. P.C.F.	Ult. Comp. Strength PSF	Str. %
	1		Very moist dark brown clayey TOPSOIL						
A	2		Slightly compact wet clayey variegated fine SAND with some silt and trace of vegetation	1					
UL	3			2	17.2	128			
	4		Compact wet brown fine SAND with trace of vegetation and seams to layers of clayey sand	7					
B	5			5					
UL	6			12	10.5	139			
	7		Very stiff moist variegated sandy CLAY with some sand and pebbles and little silt	13			*	(8000)	
C	8			3					
UL	9		Very stiff moist brown silty CLAY with trace of sand and pebbles	10					
	10		Very stiff moist blue silty CLAY with little sand and pebbles	11					
D	11			3					
UL	12		Stiff moist blue silty CLAY with some sand and pebbles and seams of wet fine to medium sand	3	11.7	141		2295	
	13			7			*	(2500-3000)	
E	14								
UL	15		Very stiff moist blue silty CLAY with sand and pebbles and wet fine sand streaks	3					
	16			7					
	17			10					
	18								
	19		Stiff moist blue silty CLAY with little sand and pebbles						
F	20			3					
UL	21			5					
	22			5					
	23								
	24								
	25								

NOTES:

- 1) Set piezometer at 10' with 3' stick up.
- 2) Used track rig.

TYPE OF SAMPLE
O - OBTAINED
UL - UNDIST. LNER
S.S. - SPLIT SPON
R.C. - ROCK CORE
J - JENNETT METER

REMARKS: * Calibrated Penetrometer

Standard Penetration Test - Driving 2' OD Sampler 1' With

GROUND WATER OBSERVATIONS

G.W. ENCOUNTERED AT	0 FT.	6 INS.
G.W. ENCOUNTERED AT	2 FT.	5 INS.
G.W. AFTER COMPLETION	13 FT.	0 INS.
G.W. AFTER	INS.	
G.W. VOLUMES	Medium	

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LOG OF SOIL BORING NO. 11

PROJECT Soils Investigation
 Proposed Scenic Pines Estates Subdivision
LOCATION Pembine Street
 Novi, Michigan

JOB NO. 19-040
SURFACE ELEV. 941.0 **DATE** 4-22-19

Sample ID Type	Depth	Legend	SOIL DESCRIPTION
	1		0'3"
A UL	2		Moist dark brown clayey TOPSOIL with vegetation
	3		
	4		
B UL	5		Stiff moist brown silty CLAY with wet brown silt seams
	6		
	7		4'10"
	8		
C UL	9		Very stiff moist brown silty CLAY
	10		
	11		
	12		
	13		6'6"
	14		
D UL	15		Very compact moist to wet brown fine to medium SAND with trace of silt
	16		
	17		
	18		
	19		
	20		
	21		
	22		
	23		12'6"
	24		
	25		
	26		
	27		
	28		
	29		
	30		
	31		
	32		
	33		
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	35		
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JOB NO. 19-040

SURFACE ELEV. 934.3 DATE 4-22-19

LOG OF SOIL BORING

12

PROJECT

Soils Investigation
Proposed Scenic Pines
Estates Subdivision
Pembine Street
Novi, Michigan

LOCATION

Sample & Type	Depth	Legend	SOIL DESCRIPTION
A UL	1 2 3 4		Mold dark brown clayey TOPSOIL with trace of vegetation
B UL	5 6		Stiff moist variegated sandy CLAY with moist to wet brown and gray silt seams
C UL	7 8 9 10 11 12 13 14		Compact wet brown silty fine to medium SAND with traces of clay and gravel
D UL	15 16 17 18 19 20 21 22 23 24 25		Very stiff moist blue silty CLAY with sand and pebbles and occasional stones

Penetration Blow ft.	Moisture %	Natural Wt. P.C.F.	Dry Den. Wt. P.C.F.	Unc. Comp. Strength PSF	Str. %
1 4 5	23.1	123	*	(3500)	
3 5 5	14.6	131			
3 6 6	12.3	140	*	(5000)	
3 5 5					
5 9 11					
7 8 11					

Note:

Installed 1½" diameter PVC piezometer in boring with screen bottom at 10' and 3' stick-up.

REMARKS:


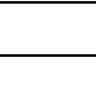
* Calibrated Penetrometer

GROUND WATER OBSERVATIONS


G.W. ENCOUNTERED AT	4 FT.	0 INS.
G.W. ENCOUNTERED AT	7 FT.	0 INS.
G.W. AFTER COMPLETION	3 FT.	6 INS.
G.W. AFTER	HRS.	FT.
G.W. VOLUMES	Heavy	INS.

Standard Penetration Test - Driving 2" OD Sampler 1 With

140lb Hammer Falling 30" Count Blows at 6" Intervals

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<p>SECTION 3</p> <p>TOWN 1 NORTH, RANGE 8 EAST</p> <p>CITY OF NOVI</p> <p>OAKLAND COUNTY, MICHIGAN</p>	<p>SCENIC PINES</p> <p>SINGH DEVELOPMENT, LLC. 7125 ORCHARD LAKE ROAD BLOOMFIELD HILLS, MICHIGAN 48322</p> <p>SOIL BORE LOGS-2</p>
<p>CLIENT:</p>	
<p>DATE: 11-27-2019</p>	
<p>REVISIONS</p>	
<p>PER CITY 03-24-2020</p>	
<p>PER CITY 01-18-2021</p>	
<p>DR BY: SDT</p>	
<p>CK BY: SDT/MY</p>	
<p>P.M. SA</p>	
<p>SCALE 0 </p>	
<p>AS NOTED</p>	
<p>JOB NO. 180905</p>	
<p>SHEET NO.</p>	
<p>38</p>	
<p>SHEET 38 OF 38</p>	



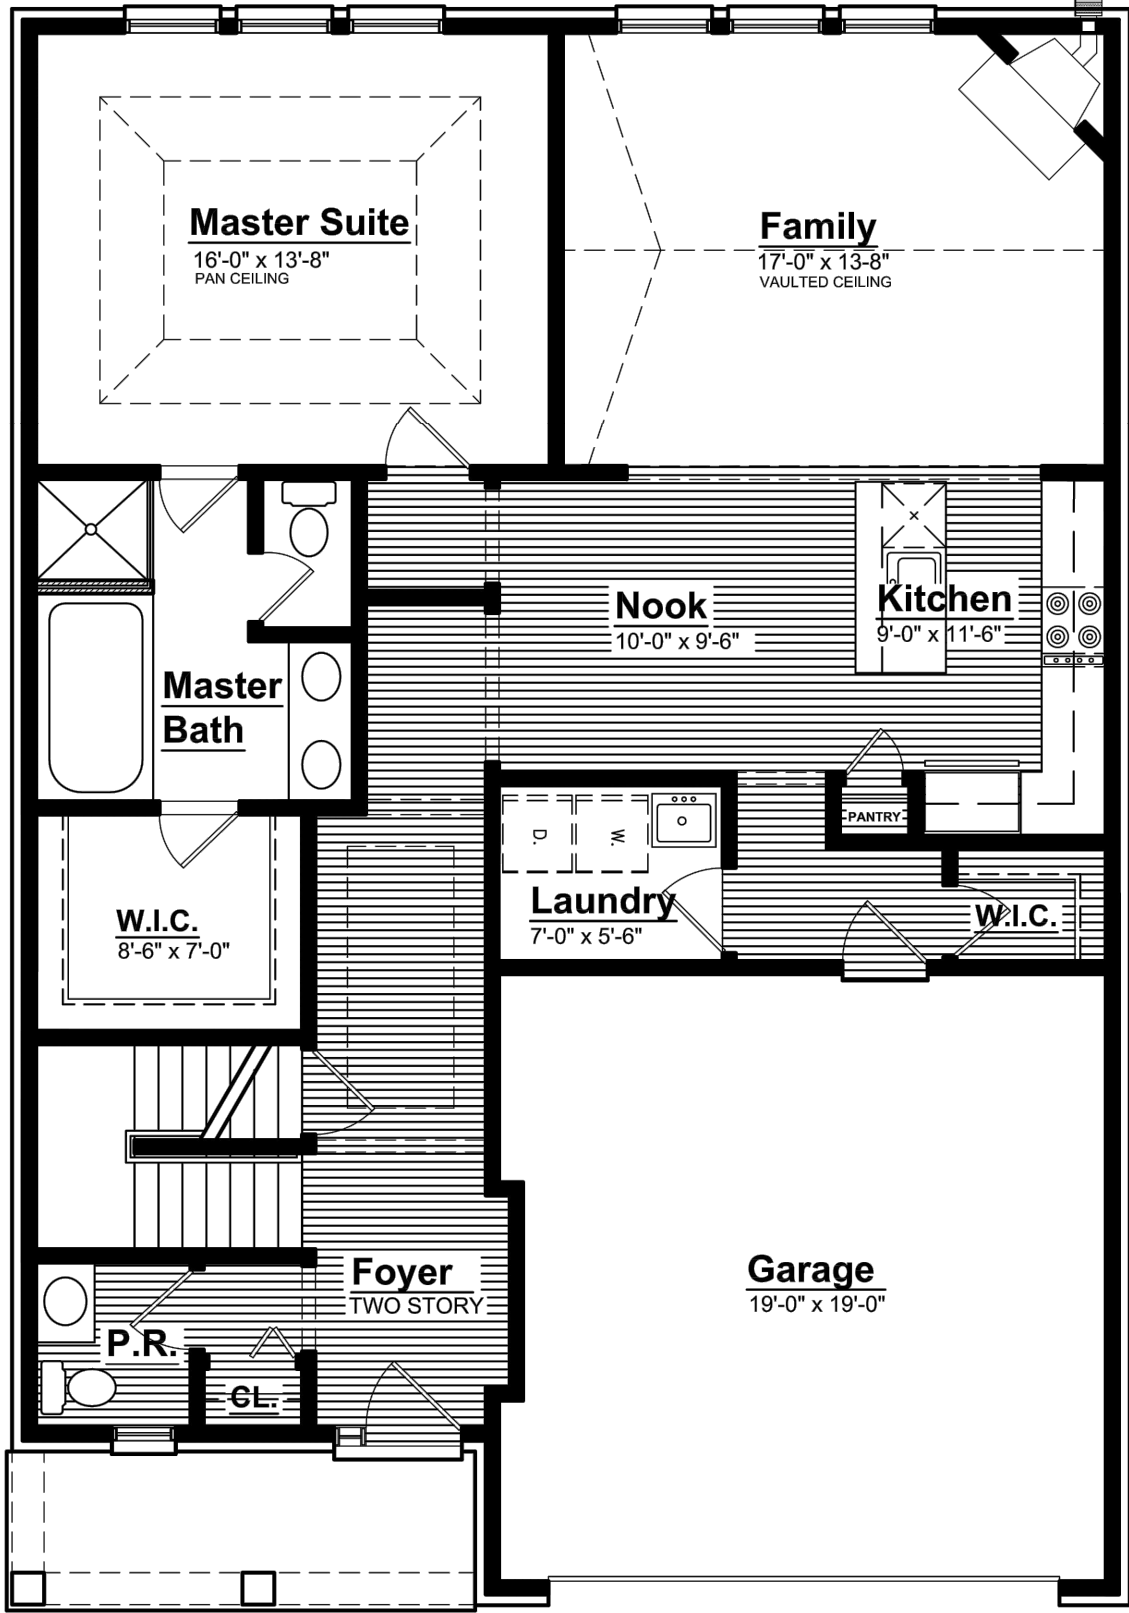

Singh Homes - Scenic Pines of Novi
Two Car Garage - Cape Cod - First Floor
1,295 SF



Singh Homes - Scenic Pines of Novi
Two Car Garage - Cape Cod - Second Floor
805 SF



ELEVATION "A"
BUILDING HEIGHT MAX. 35'



ELEVATION "B"
BUILDING HEIGHT MAX. 35'



ELEVATION "C"
BUILDING HEIGHT MAX. 35'

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LAND DEVELOPMENT SERVICES

SECTION 3	TOWN 1 NORTH, RANGE 8 EAST	SCENIC PINES SINGH DEVELOPMENT, LLC. 7125 ORCHARD LAKE ROAD BLOOMFIELD HILLS, MICHIGAN 48322
	CITY OF NOVI	
OAKLAND COUNTY, MICHIGAN		ARCHITECTURAL SKETCHES

DATE:	11-27-2019
REVISIONS	
PER CITY 03-24-2020	
OR BY: SDT	
CK BY: SDT/MY	
P.M. SA	
SCALE 0	
AS NOTED	
JOB NO. 180905	
SHEET NO.	
A1	
SHEET A1 OF 37	



M:\UMLOR GROUP PROJECT FOLDERS\SCENIC PINES DEVELOPMENT\180905 - SCENIC PINES DESIGN FILES & PLAN SETS\SCENIC PINES CO'S\180905-ARCHITECTURAL SKETCHES.DWG



ELEVATION "2200-A"
BUILDING HEIGHT MAX. 35'



ELEVATION "2300-A"
BUILDING HEIGHT MAX. 35'



ELEVATION "2200-B"
BUILDING HEIGHT MAX. 35'



ELEVATION "2300-B"
BUILDING HEIGHT MAX. 35'



ELEVATION "2200-C"
BUILDING HEIGHT MAX. 35'



ELEVATION "2300-C"
BUILDING HEIGHT MAX. 35'

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SECTION 3	TOWN 1 NORTH, RANGE 8 EAST	CITY OF NOVI	OAKLAND COUNTY, MICHIGAN
CLIENT:	SCENIC PINES SINGH DEVELOPMENT, LLC. 7125 ORCHARD LAKE ROAD BLOOMFIELD HILLS, MICHIGAN 48322		
CLIENT:	ARCHITECTURAL SKETCHES		

DATE: 11-27-2019

REVISIONS

PER CITY 03-24-2020

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CK BY:	SDT/JMY
P.M.	SA
SCALE	0 -- --
	AS NOTED
JOB NO.	180905
SHEET NO.	A2
SHEET A2 OF 37	

STATE OF MICHIGAN

WES LEE

C. UMLOR

ENGINEER

6201634574

PROFESSIONAL ENGINEER

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ELEVATION "2400-A"
BUILDING HEIGHT MAX. 35'



ELEVATION "2400-B"
BUILDING HEIGHT MAX. 35'



ELEVATION "2400-C"
BUILDING HEIGHT MAX. 35'



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	CITY OF NOVI	

SCENIC PINES

CLIENT: SINGH DEVELOPMENT, LLC.
7125 ORCHARD LAKE ROAD
BLOOMFIELD HILLS, MICHIGAN 48322


ARCHITECTURAL SKETCHES

DATE: 11-27-2019


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PER CITY 03-24-2020

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SHEET NO. **A3**
SHEET A3 OF 37

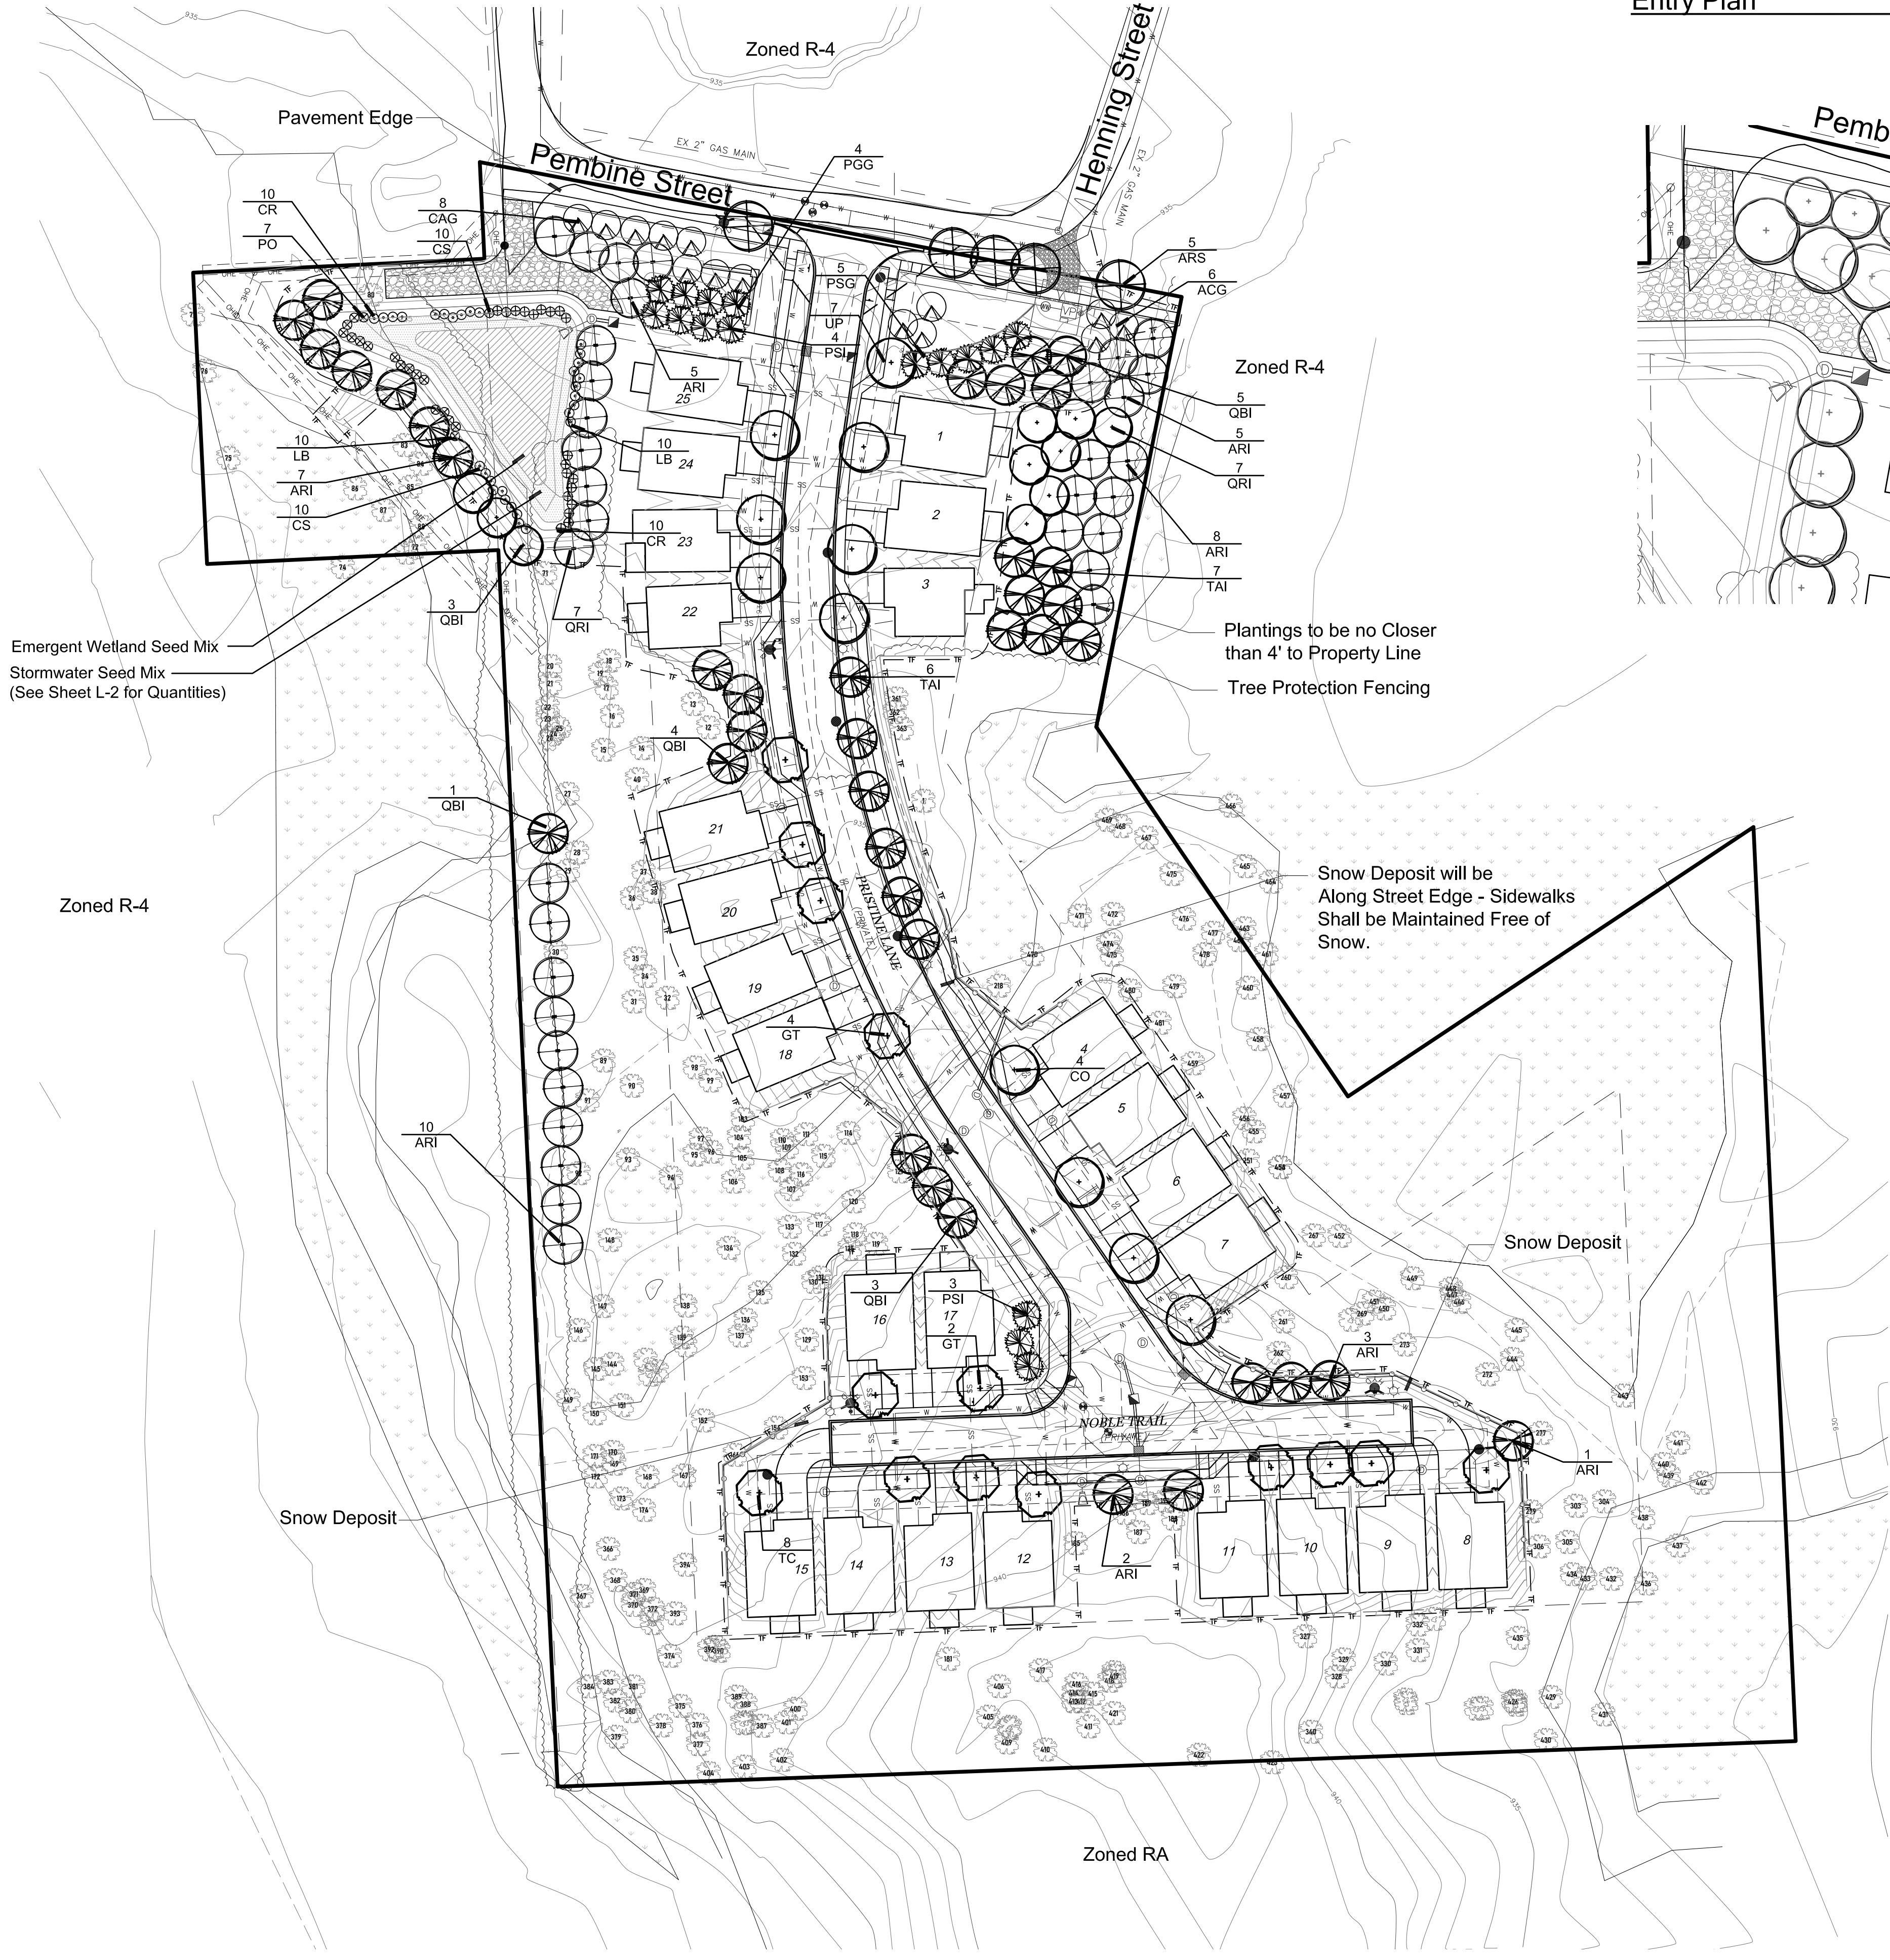

Entry Plan

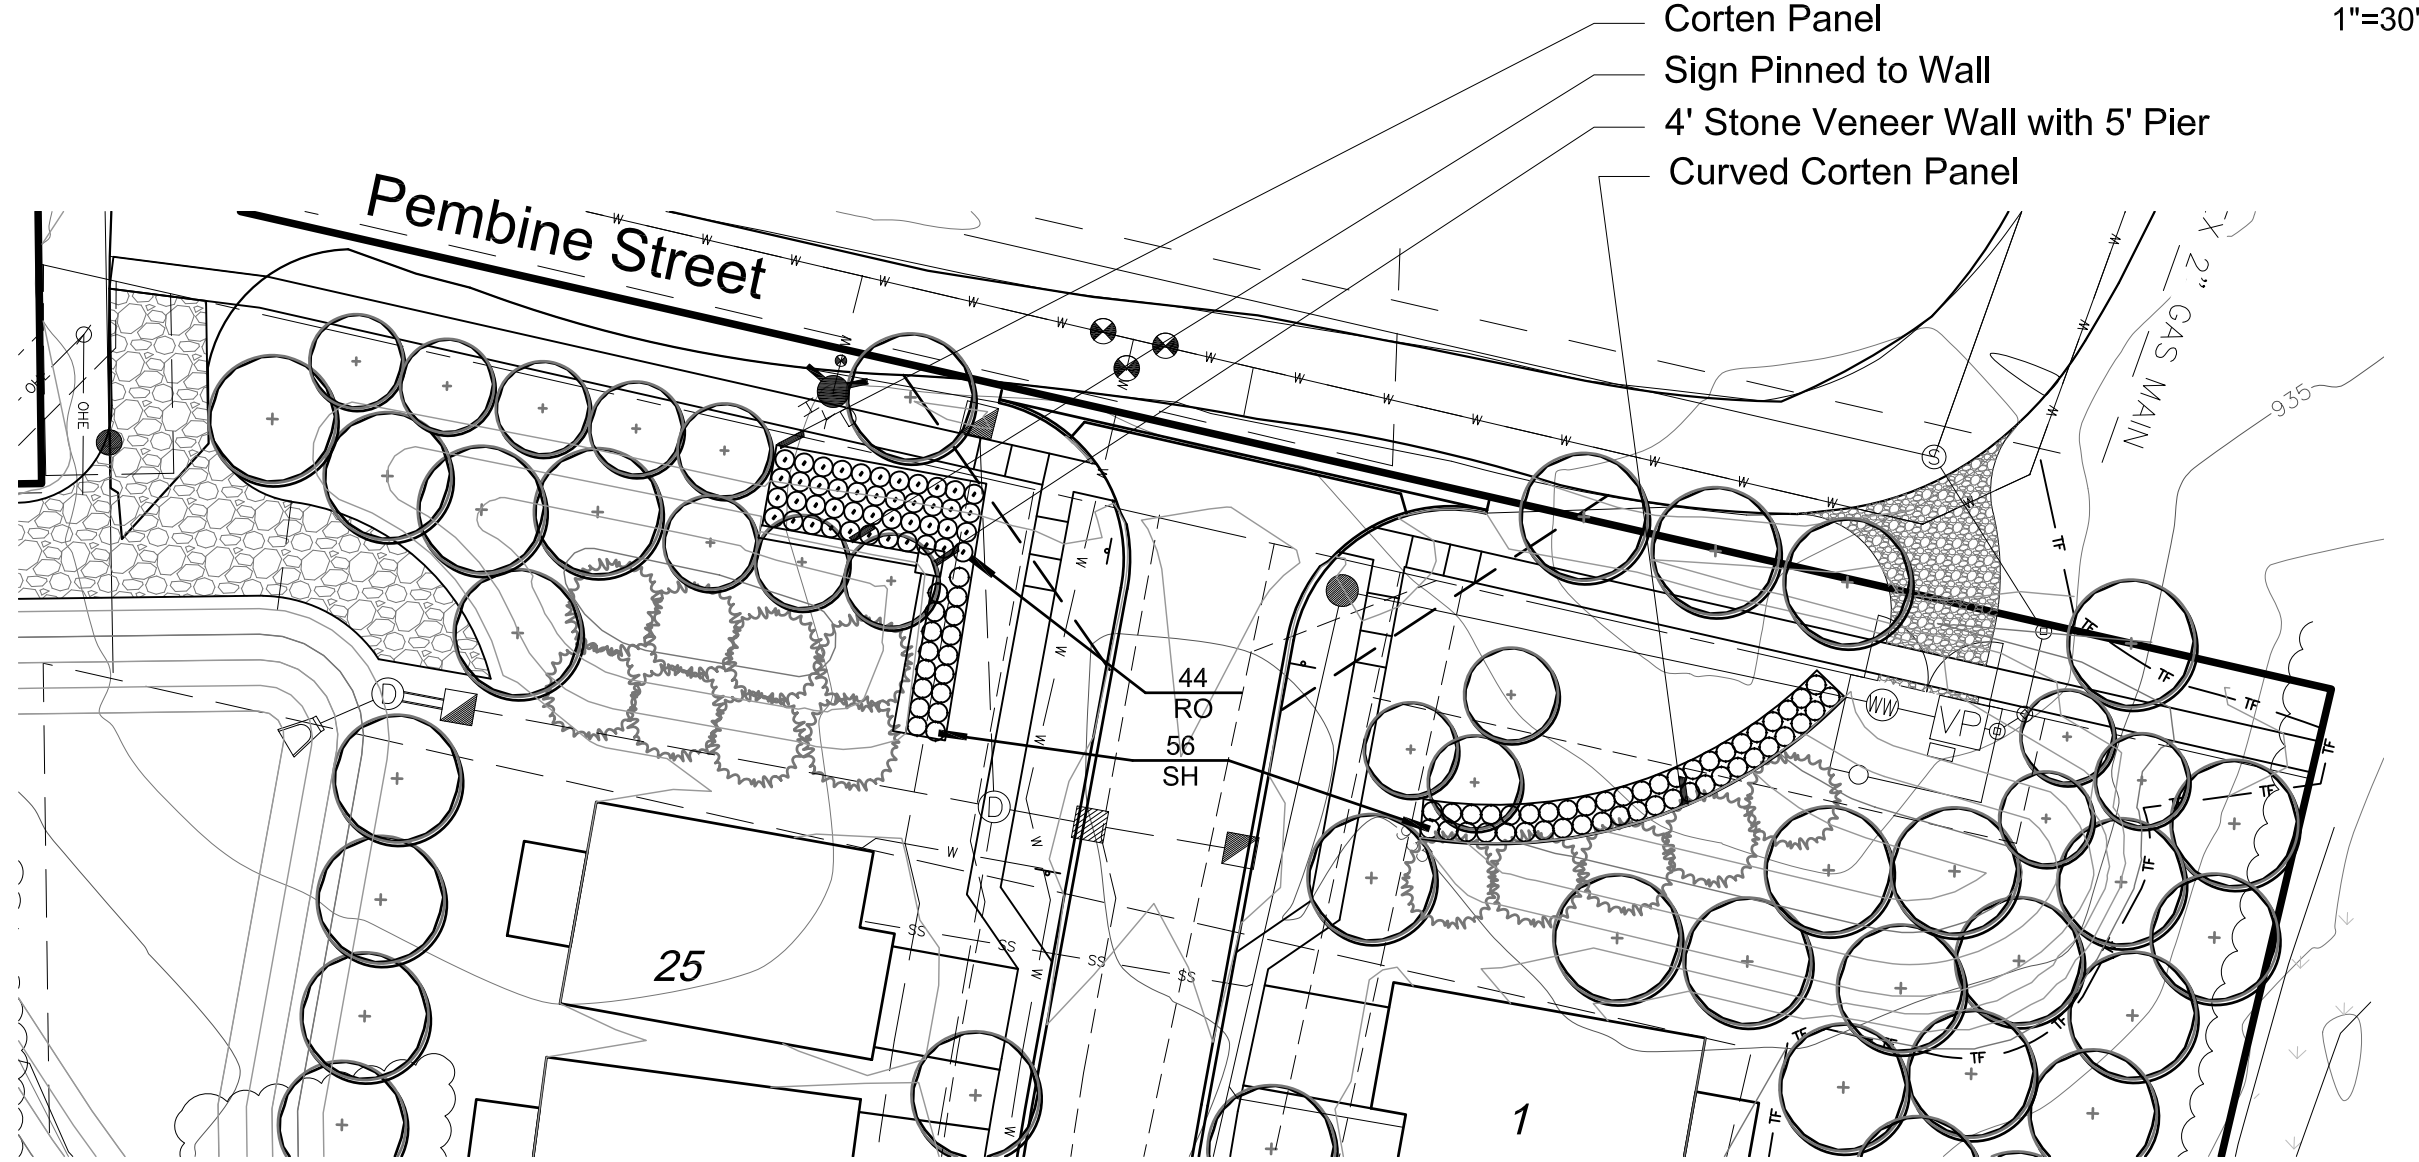


Landscape Summary

Street Trees		Woodland Replacement	
Unit Trees	25 Units	Replacement Required	438 Trees
Trees Required	25 Trees (1 per unit)	Total Trees Provided	88.6 Trees
Trees Provided	25 Trees	Trees to be Paid into Fund	349.4 Trees
Street Lawn		Detention Pond	
Total Street Frontage	367 l.f.	High Water Length	415 l.f.
Less Drive Opening	28 l.f.	Landscape Required	291 l.f. (415 x 70%)
Net Street Frontage	339 l.f.	Landscape Provided	301 l.f. (73%)
Trees Required	9.6 Trees (339 / 35)	LANDSCAPE WAIVERS GRANTED BY THE PLANNING COMMISSION ON 9/25/2019:	
Trees Provided	5 Trees	3 street trees are planted more than 15 feet behind the curb, and not between the sidewalk and curb.	
Greenbelt Plantings		Absence of 3 required street trees along Pembine street frontage that can't be planted due to a lack of space between the sidewalk and road.	
Total Street Frontage	367 l.f.	Notes:	
Less Drive Opening	28 l.f.	• Trees Shall be Planted 10' from Utility Structures Including Hydrants	
Net Street Frontage	339 l.f.	• Snow Shall be Deposited Adjacent to Drives and within the Curb Lawn	
Canopy Trees Required	8.5 Trees (339 / 40)	• All Utility Boxes Shall be Screen per Detail on Sheet L-2	
Canopy Trees Provided	9 Trees	• Overhead Lines are Not Present	
Sub-Canopy Trees Required	13.5 Trees (339 / 25)	• Phragmites is not Present on the Site.	
Sub-Canopy Trees Provided	14 Trees		

Plant List

sym.	qty.	botanical name	common name	caliper	spacing	root	height	price	total	Species	Genus	Native	Total
Woodland Replacement													
ARI	41	Acer rubrum	Red Maple	2.5"	as shown	B&B		\$ 400.00	\$ 16,400.00			1	1
QBI	16	Quercus bicolor	Swamp White Oak	2.5"	as shown	B&B		\$ 400.00	\$ 6,400.00			1	1
QRI	14	Quercus rubra	Red Oak	2.5"	as shown	B&B		\$ 400.00	\$ 5,600.00			1	1
PSI	7	Pinus strobus	White Pine	as shown	B&B	6'		\$ 325.00	\$ 2,275.00			1	1
TAI	13	Tilia americana	Basswood	2.5"	as shown	B&B		\$ 400.00	\$ 5,200.00			1	1
88.6 Replacements Shown													
Detention Shrubs													
CR	20	Cornus racemosa	Gray Dogwood		as shown		36"	\$ 50.00	\$ 1,000.00			1	1
CS	20	Cornus stolonifera	Red-osier Dogwood		as shown		36"	\$ 50.00	\$ 1,000.00			1	1
LB	20	Lindera benzoin	Spicebush		as shown		36"	\$ 50.00	\$ 1,000.00			1	1
PO	7	Physocarpus opulifolius	Eastern Ninebark		as shown		36"	\$ 50.00	\$ 350.00			1	1
67 Shrubs Shown													
Unit and Street Trees													
CO	4	Celtis occidentalis	Northern Hackberry	3.0"	as shown	B&B		\$ 400.00	\$ 1,600.00	8%	8%	1	1
GT	6	Gleditsia triacanthos var. inermis	Thornless Honeylocust	3.0"	as shown	B&B		\$ 400.00	\$ 2,400.00	11%	11%	1	1
TC	8	Tilia cordata 'Greenspire'	Greenspire Linden	3.0"	as shown	B&B		\$ 400.00	\$ 3,200.00	15%	15%	1	1
UP	7	Ulmus 'Pioneer'	Pioneer Elm	3.0"	as shown	B&B		\$ 400.00	\$ 2,800.00	13%	13%	1	1
25 Trees Provided													
Street Lawn and Greenbelt													
ACG	6	Amelanchier laevis	Shadbowl	2.5"	as shown	B&B		\$ 250.00	\$ 1,500.00	11%	11%	1	1
ARS	5	Acer rubrum	Red Maple	3.0"	as shown	B&B		\$ 400.00	\$ 2,000.00	9%	9%	1	1
CAG	8	Cornus alternifolia	Alternative Leaf Dogwood	2.5"	as shown	B&B		\$ 250.00	\$ 2,000.00	15%	15%	1	1
PSG	9	Pinus strobus	White Pine	as shown	B&B	8'		\$ 325.00	\$ 2,925.00	17%	17%	1	1
28 Trees Provided													
General Plantings													
RO	44	Rosa 'Drift'	Drift Rose		as shown	#2		\$ 15.00	\$ 660.00			1	1
SH	56	Sporobolus heterolepis	Prairie Dropseed		13" o.c.	#2		\$ 15.00	\$ 840.00			1	1
										Total		16	19
										% Native		84%	
Mulch:													
	19	4" Deep Shredded Hardwood Bark Mulch / s. y.						\$35	\$ 665.00				
	46	Sod / s. y.						\$6	\$ 276.00				
	732	Seed / s. y. (Lawn)						\$3.00	\$ 2,196.00				
	851	Seed / s. y. (Detention Pond)						\$6.00	\$ 5,106.00				
Irrigation													
									Total	\$ 73,393.00			

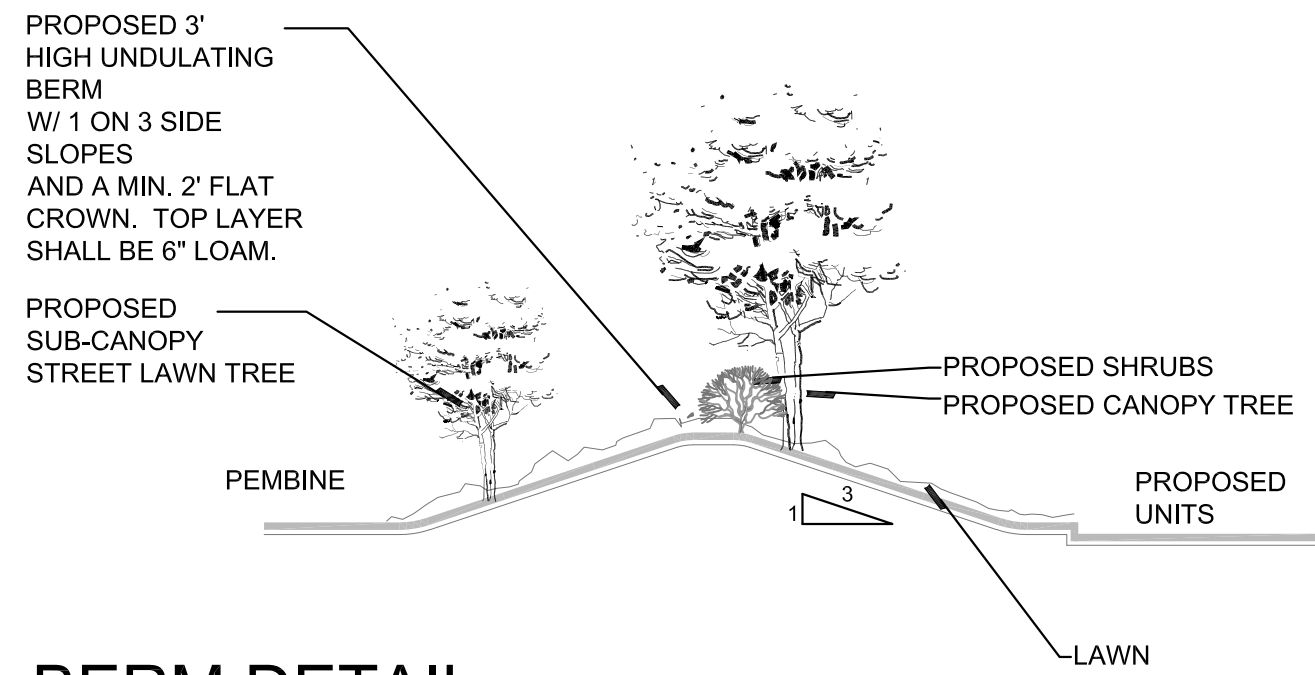

BERM DETAIL

HORIZONTAL SCALE: 1"=10'

Seal:



Title:

Landscape Plan

Project:

Scenic Pines
Novi, MI

Prepared for:

Singh Development, LLC
7125 Orchard Lake Road, Suite 200
West Bloomfield, Michigan 48322

Revision:

Review
Revised
Revised
Revised
Revised

Issued:

February 22, 2019
May 24, 2019
July 16, 2019
November 25, 2019
March 23, 2020

Job Number:

19-019

Drawn By:

jca

Checked By:

jca




Sheet No.

L-1




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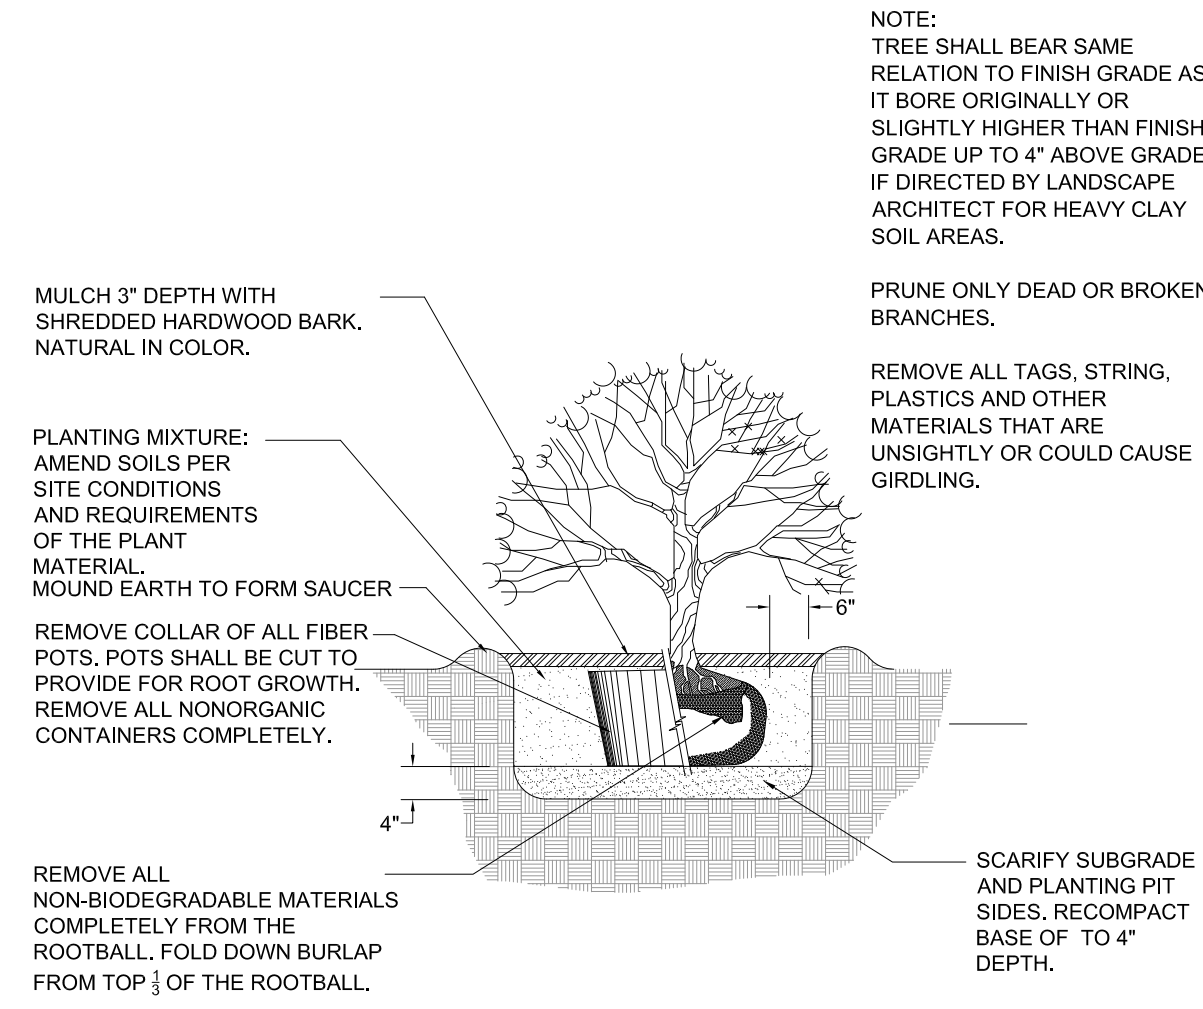
DECIDUOUS TREE PLANTING DETAIL

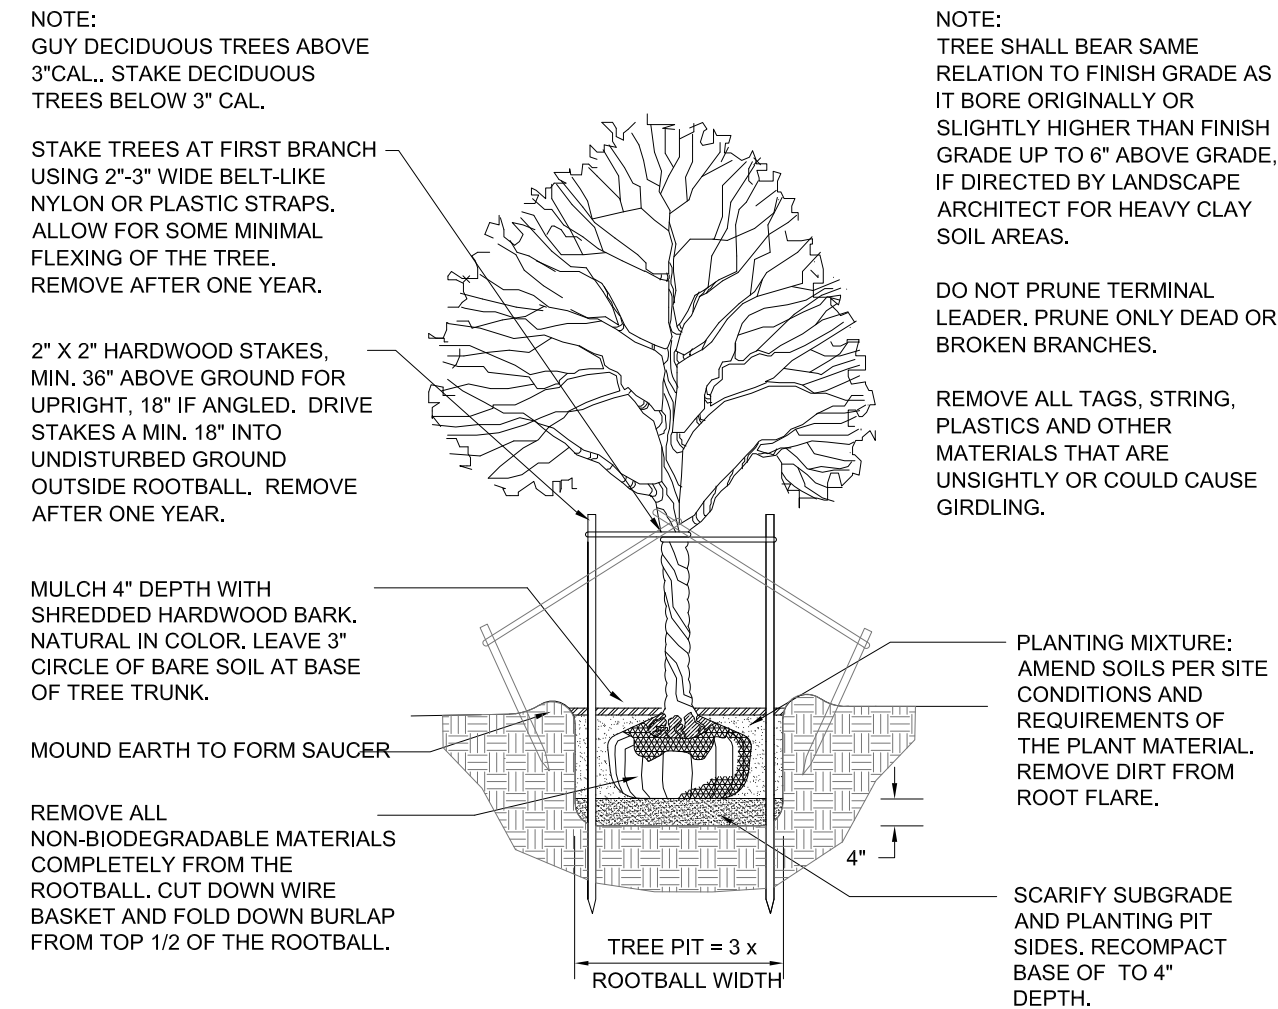NOT TO SCALE




EVERGREEN TREE PLANTING DETAIL

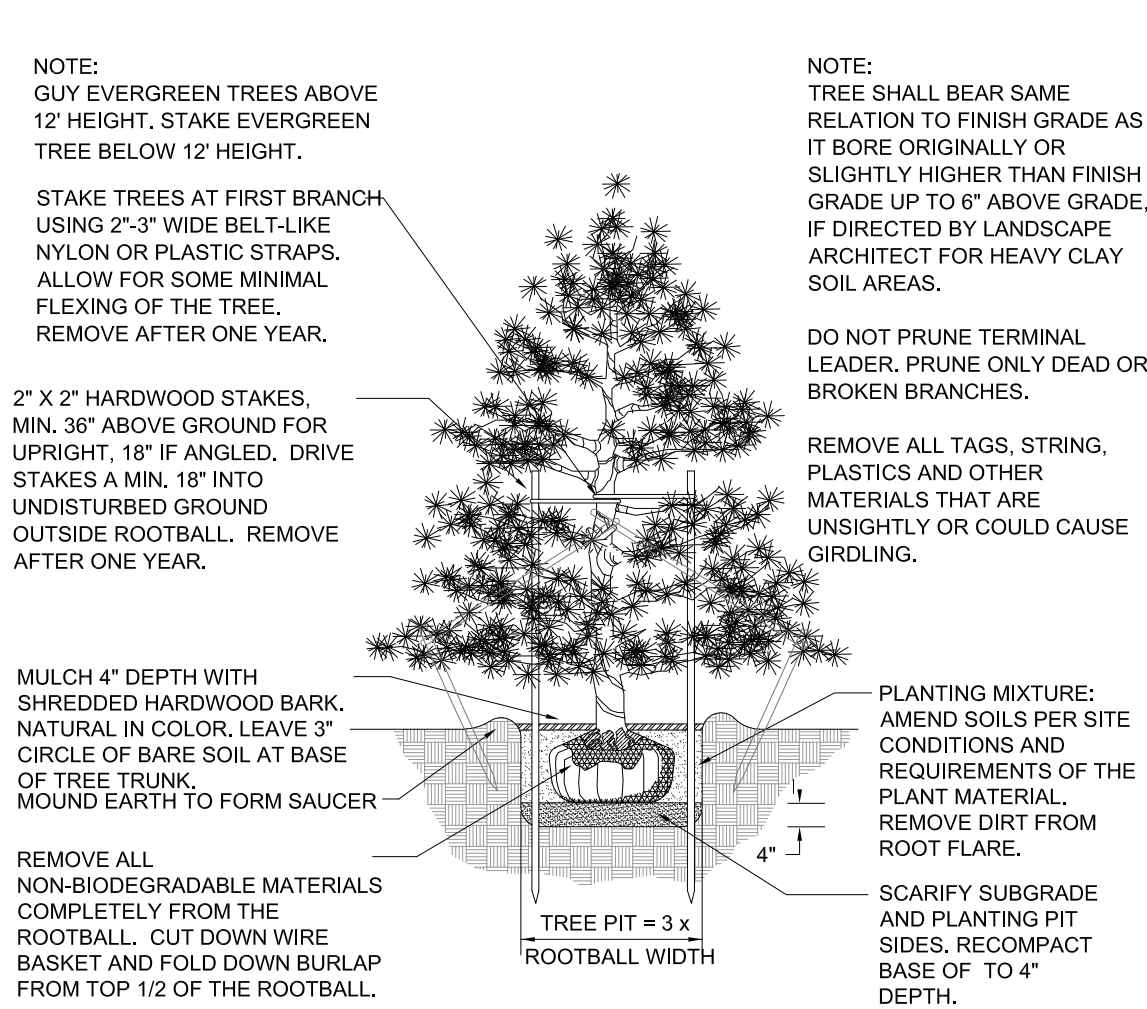Not to scale




SHRUB PLANTING DETAIL

NOT TO SCALE

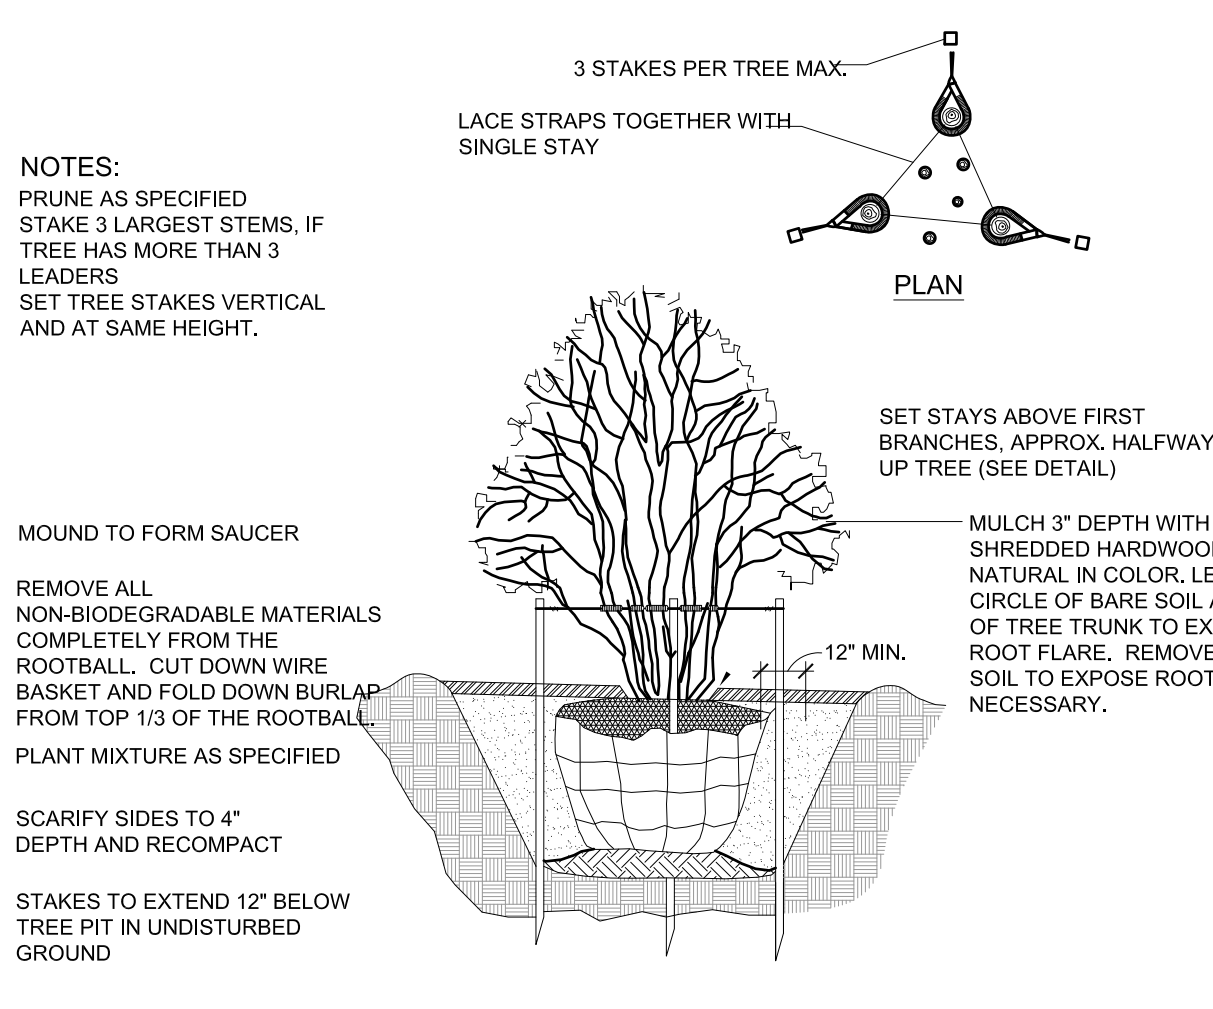


MULTI-STEM TREE PLANTING DETAIL

NOT TO SCALE

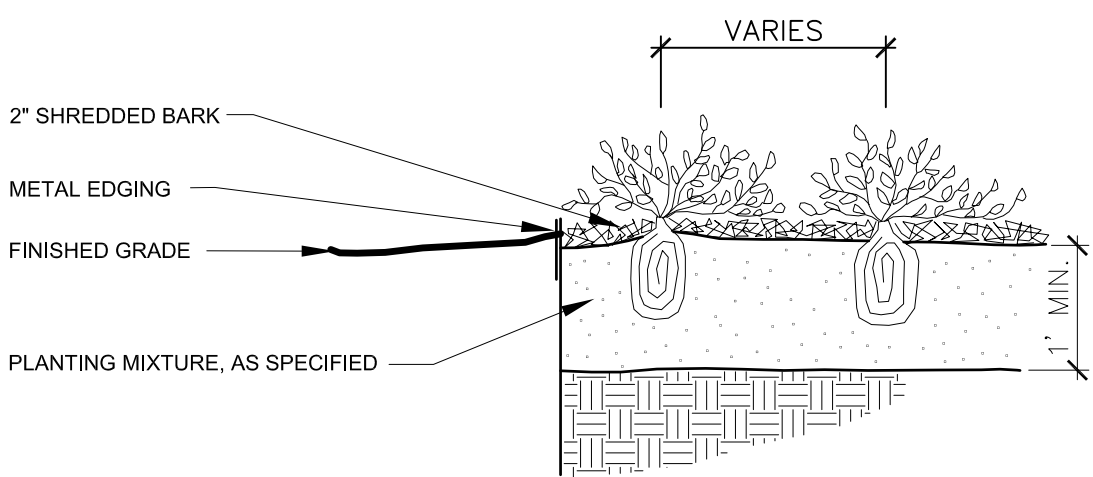

PERENNIAL PLANTING DETAIL

Not to scale

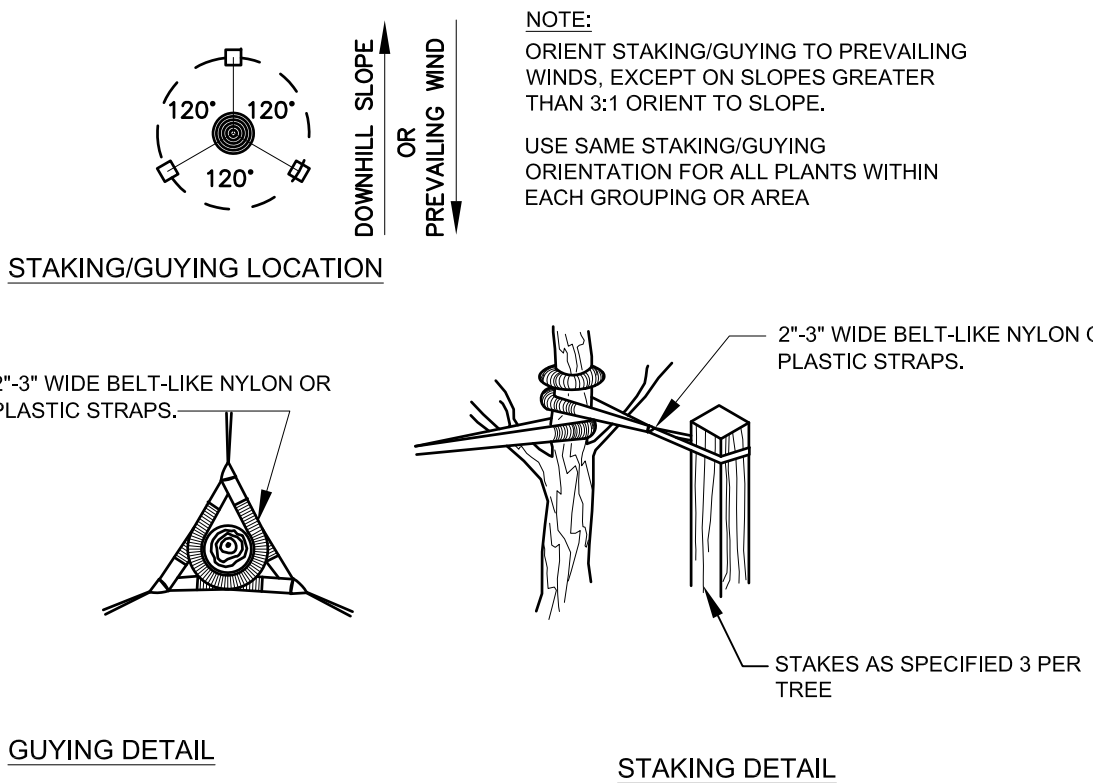

TREE STAKING DETAIL

Not to scale

CITY OF NOVI NOTES

- All landscape islands shall be backfilled with a sand mixture to facilitate drainage.
- All proposed landscape islands shall be curbed.
- All landscape areas shall be irrigated.
- Overhead utility lines and poles to be relocated as directed by utility company of record.
- Evergreen and canopy trees shall be planted a minimum of 10' from a fire hydrant, and manhole, 15' from overhead wires.
- All plant material shall be guaranteed for two (2) years after City Approval and shall be installed and maintained according to City of Novi standards. Replace Failing Material within 3 Months of Discovering the Need for Replacement. One cultivation per month shall occur in July-August.
- All proposed street trees shall be planted a minimum of 4' from both the back of curb and proposed walks.
- All tree and shrub planting beds shall be mulched with shredded hardwood bark, spread to minimum depth of 4". All lawn area trees shall have a 4' diameter circle of shredded hardwood mulch 3" away from trunk. All perennial, annual and ground cover beds shall receive 2" of dark colored bark mulch as indicated on the plant list. Mulch is to be free from debris and foreign material, and shall contain no pieces of inconsistent size.
- All Substitutions or Deviations from the Landscape Plan Must be Approved in Writing by the City of Novi Prior to their Installation.

NOTES:
THE APPROXIMATE DATE OF INSTALLATION FOR THE PROPOSED LANDSCAPE WILL BE FALL OR SPRING OF 2020 or 2021.

THE SITE WILL BE MAINTAINED BY THE DEVELOPER IN ACCORDANCE WITH THE STANDARDS SET FORTH IN THE CITY OF NOVI ZONING ORDINANCE. THIS INCLUDES WEEDING AND WATERING AS REQUIRED BY NORMAL MAINTENANCE PRACTICES.

DEVELOPER SHALL BE RESPONSIBLE FOR REPLACING ANY TREES WITHIN UTILITY EASEMENTS THAT ARE DAMAGED THROUGH NORMAL MAINTENANCE OR REPAIRS.

PLANT MATERIALS SHALL BE GUARANTEED FOR 2 YEARS AND SHALL BE MAINTAINED IN ACCORDANCE WITH CITY ORDINANCES. WARRANTY PERIOD BEGINS AT THE TIME OF CITY APPROVAL. WATERING AS NECESSARY SHALL OCCUR DURING THIS WARRANTY PERIOD.

DETENTION POND SEED MIXES

Emergent Seed Mix

Botanical Name	Common Name	PLS Oz/Acre
Boboschoenus luvatis	River Bulrush	1.00
Carex comosa	Brady Sedge	2.50
Carex leucostris	Common Lake Sedge	0.25
Carex lurida	Bottlebrush Sedge	4.00
Carex stricta	Common Tussock Sedge	1.00
Carex vulpinoidea	Brown Fox Sedge	6.00
Eleocharis palustris	Great Spike Rush	1.00
Juncus effusus	Common Rush	1.00
Leersia oryzoides	Rice Cut Grass	3.00
Scheuchzeria palustris	Hardstem Bulrush	2.50
Scheuchzeria palustris	Chenopodium	3.00
Scheuchzeria palustris	Softstem Bulrush	6.00
Total		31.25
Temporary Cover		
Avena sativa	Common Oat	360.00
Lolium multiflorum	Annual Ryegrass	100.00
Total		460.00
Forbs/Shrubs		
Acorus americanus	Swamp Flag	0.50
Alisma spp.	Water Plantain Mx	2.00
Asclepias incarnata	Swamp Milkweed	1.50
Cephalanthus occidentalis	Butterbush	6.00
Decodon verticillatus	Swamp Loosestrife	0.50
Eutrochium maculatum	Spotted Joe Pye Weed	0.50
Hibiscus spp.	Rosemallow Mx	4.00
Iris virginica	Blue Flag	6.00
Lobelia cardinalis	Cardinal Flower	0.25
Lobelia spicata	Great Blue Lobelia	0.25
Lycopus americanus	Common Water Horehound	0.25
Mimulus ringens	Monkey Flower	1.00
Peltandra virginica	Arrow Arum	16.00
Pentstemon sedoides	Ditch Stonecrop	0.50
Polygonum spp.	Primrose Mx	0.50
Portulaca oleracea	Pickering Weed	10.00
Sagittaria latifolia	Common Arrowhead	2.00
Sparganium angustifolium	Common Bur Reed	6.00
Veronica hastata	Blue Vervain	1.00
Total		58.75

Emergent Wetland Seed Mix by Cardno JFNew
3,119 s.f.

34.4 lbs. per Acre Application Rate
2.5 lbs. of Emergent Seed Mix
3"-6" of Topsoil or Wetland Mulch Shall be Placed in this Area. Use Seed Mat.

Stormwater Seed Mix

Botanical Name	Common Name	PLS Oz/Acre
Permanent Grasses/Sedges		
Boboschoenus luvatis	River Bulrush	0.25
Carex cristata	Crested Oval Sedge	2.00
Carex lurida	Bottlebrush Sedge	3.00
Carex vulpinoidea	Brown Fox Sedge	6.00
Leersia oryzoides	Virginia Wild Ryegrass	13.50
Juncus effusus	Fowl Manna Grass	1.25
Leersia oryzoides	Common Rush	2.00
Panicum virgatum	Rice Cut Grass	2.00
Scheuchzeria palustris	Swamp Bulrush	3.00
Scirpus atrovirens	Dark Green Rush	2.00
Scirpus cyperinus	Wool Grass	37.00
Total		70.00
Temporary Cover		
Avena sativa	Common Oat	360.00
Lolium multiflorum	Annual Ryegrass	100.00
Total		460.00
Forbs		
Alisma spp.	Water Plantain Mx	4.25
Asclepias incarnata	Swamp Milkweed	1.50
Bidens spp.	Bidens Mx	2.00
Eleocharis acicularis	Shrubby Sedge	2.00
Fredericia virginica	Blue Flag	4.00
Lycopus americanus	Common Water Horehound	0.25
Mimulus ringens	Monkey Flower	1.00
Oligoneuron riddellii	Riddell's Goldenrod	0.50
Polygonum sedoides	Ditch Stonecrop	0.50
Polygonum spp.	Primrose Mx	4.00
Sagittaria latifolia	Swamp Arrowhead	1.00
Sagittaria latifolia	Brown-Eyed Susan	1.00
Sagittaria latifolia	Common Arrowhead	1.00
Sagittaria latifolia	Wild Senna	1.00
Sagittaria latifolia	New England Aster	1.50
Sagittaria latifolia	Purple Meadow Rue	2.00
Total		28.00

Stormwater Seed Mix by Cardno JFNew

2,886 s.f.

32.8 lbs. per Acre Application Rate
2.2 lbs. of Storm Water Seed Mix
3"-6" of Topsoil Shall be Placed in this Area.

DETENTION POND SEED NOTES

Site Preparation

Planting may be type of mind, but preparing your site is critical to success. Weed seeds are persistent and undesirable species will be a long-term problem if eradication of undesirable and invasive vegetation isn't complete before installation.

Eradicate all existing vegetation
Too much undesirable vegetation may require this course through one or a combination of the following techniques.

- Cultivating**
Avoid the use of chemicals and can be done on a larger scale than smothering, but it often brings up more weed seeds and is labor intensive. Cultivate every 2-3 weeks from early spring through fall to a depth of 4-5 inches using a harrow, spring tooth or rototiller to destroy the roots and weeds. Once most weeds have been eliminated, the depth should be made shallow for several months to create a firm soil bed prior to native seeding.
- Herbicide**
If your site is very large or if there is little or no native vegetation present, herbicides may be the most economical and successful option. The number of treatments will depend on the condition of the site. Ag sites may only require one or two treatments directly prior to planting, while old fields might require several treatments throughout an entire season. **Caution:** Some herbicides remain persistent long after application. Know the chemical history of your site and always READ THE LABEL and follow manufacturer's instructions when using herbicides.

Preparing the Seed Bed

A firm and level seed bed relatively free of debris is ideal for proper installation. Pack loose or soft soil with a heavy roller or cult-packer before (and after) installation. A good method for testing soil firmness is to walk over the seed bed. If your footprint sinks more than one inch, the seed bed is too soft. If a no-till drill seeder is being used and the site water is cultivated, the seed bed should be firm enough. Removing tree roots and limbs from eliminated trees, other debris (corn stubble) and grading ruts will make for a smoother planting process as well as limit damage to equipment.

Installation

Seeding Methods
Your planting method depends on the size of your site, condition of the soil, and your budget. Regardless of the method you choose, seed to soil contact and planting depth (no deeper than) are critical factors in growing native seeds. Keep this in mind before, during, and after seeding.

- Broadcast**
Best for areas less than a couple acres and generally the least expensive method, but requires a cultivated and firm seed bed. The native seed mix can be scattered a handful at a time from a bucket or you can use a hand crank seeder to cover more area faster. You can also use an ATV or tractor mounted broadcast spreader. To evenly spread seed across the entire site, divide your mix in half and scatter the first half of the seed over the entire area, then scatter the second half perpendicular to the first pass. Further divisions will give you more chances to calibrate your technique and ensure adequate coverage. Consider adding a filter such as cracked corn, vermiculite or a mesh screen of annual ryegrass and seed oats to create more bulk. If it is too windy, wait for the wind to decrease. Roll the seed into the top surface of the soil for best results, or lightly rake the seed into the soil surface using an upright-down bar rake. If the area is too large to rake by hand, use a tractor or truck to pull a light piece of fence or very light drag.
- No-Till Native Seed Drill**
Perfect for larger areas with hard ground or existing vegetation debris, no-till drills cause minimal soil disturbance and do not require tillage before planting. Fewer weed seeds are brought up from the seed bank, but the technique requires the use of herbicide. No-till drills plant into rows by opening a shallow groove in the soil, dropping the seeds, then covering the groove with soil with a rubber-packer wheel.
- A pre-emergent weed control agent, "Premer" or equal, shall be applied uniformly on top of all mulching in all planting beds.**

- All landscape areas shall be provided with an underground automatic sprinkler system.**
- Sod shall be two year old "Baron/Chenadelp" Kentucky Blue Grass grown in a sod nursery on loam soil.**

Watering & Irrigation

Watering is not necessary after fall plantings. It's not essential following a spring seeding either, but the seeds may benefit from watering during the first 3 to 6 weeks, especially if no rain has fallen for 7-10 days. If watering is practical for your site and you decide to irrigate, you will need to continue watering periodically to keep the soil from drying out while plant seedlings establish. In a dry spring, quicker establishment may result with supplemental watering.

Maintenance

After you've planted, controlling weeds is the priority for the first three years. The native plants will only grow a few inches the first year; weeds will grow much thicker and taller than the natives and can shade out the native seedlings. A simple, but diligent, maintenance plan will ensure your native planting reaches the best possible outcome.

First Year

Mowing the vegetation to a height of 4-6 inches when it reaches 10-12 inches. If you get a lot of rain, you may have to mow about once a month. Mowing keeps the weeds from shading out the natives, as well as stopping the weeds from producing new seeds. Stop mowing at the end of the growing season. A little weed growth at the end of the year will help protect the seedlings during their first winter.

Hand pulling weeds and herbicide are generally **not recommended** in the first year. You risk harming the sensitive native seedlings. If aggressive weeds, like Canada thistle or reed-canary grass, appear to be a problem you can consider careful herbicide application. Take care not to allow herbicide to contact native vegetation.

Second Year

When the vegetation reaches 12-18 inches, mow it down to 8 inches. Because you're allowing it to grow higher, you should mow fewer times in the second year. You'll see some natives blooming, but it's worth sacrificing flowers at this stage to achieve better weed control and a more successful native planting in the long term. The natives will persist through mowing and a few will bloom at lower heights in response to repeated mowing.

Hand pulling and spot treatments of herbicide may be needed for some of the common competitive weeds such as spotted knoeweed, Canada thistle, buckhorn, wild parsnip, sweet clover, and Queen Anne's lace.

Third Year and Beyond

If the planting is establishing as it should, you should now have enough fuel accumulated to burn on a regular basis. If burning doesn't occur, a thatch layer can accumulate, causing poor growth or plants to die out completely. Burning kills or at least reduces weed growth and stimulates growth of native species.

Early spring burns are most common. Only experienced, trained crews should perform a prescribed burn. Be sure to check your local fire regulations and obtain the appropriate permits. A wide path (10-15 feet) or burn line should be mowed throughout the growing season around the perimeter of the planting, prior to a burn.


After the third year, burning should take place every one to three years. Consider a burn rotation in which a half or third of the area is burned one year and another section the next. This will give ensure that over-wintering butterflies, moths, and nesting birds do not temporarily lose all of their habitat.

Spot treating with herbicide may still be needed if weeds persist, however, once your natives are established, they should require minimal maintenance.

The landscape contractor shall send the City's Landscape Architect, Rick Meador at (meador@cityofnovi.org) a photo of the label on the seed bag to confirm that the correct mix is used. Failure to use the specified mix or a substitute not approved by the City may require the area to be re-prepared and re-seeded with the correct mix.

ALLEN DESIGN
LAND PLANNING / LANDSCAPE ARCHITECTURE
557 CARPENTER • NORTHVILLE, MI 48167
248 467 4668 • Fax 248 349 0559
Email: jca@wideopenwest.com

Seal:

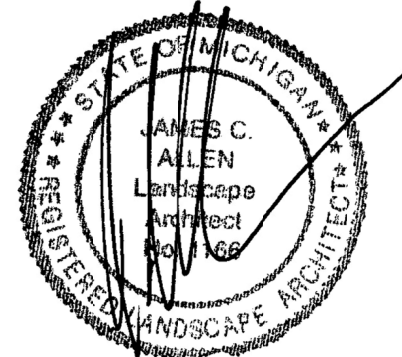

Title:

Landscape Details

Project:

Scenic Pines

Novi, MI

Prepared for:

Singh Development, LLC
7125 Orchard Lake Road, Suite 200
West Bloomfield, Michigan 48322

Revision:

Review	Issued:
Revised	February 21, 2019
Revised	May 24, 2019
Revised	July 16, 2019
Revised	November 25, 2019
Revised	March 23, 2020

Job Number:

19-019

Drawn By:

jca

Checked By:

jca

Sheet No.



L-2

Seal: _____

Title: _____
Irrigation Plan

Project: _____

Scenic Pines
Novi, MI


Prepared for: _____

Singh Development, LLC
7125 Orchard Lake Road, Suite 200
West Bloomfield, Michigan 48322

Revision: _____ Issued: _____
Review March 23, 2020

Job Number: _____
19-019


Drawn By: _____ Checked By: _____
ajb jca

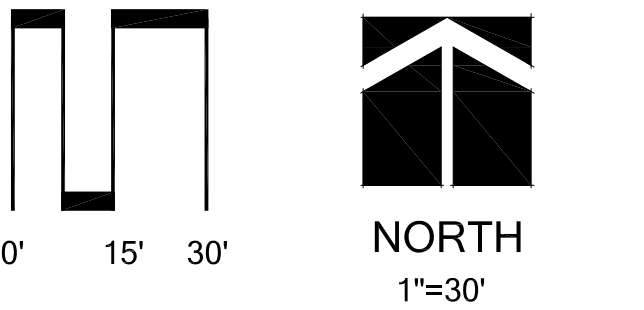







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IR-1

PIPE SIZE CHART
0-12 GPM = 1" DIAMETER POLYETHYLENE PIPE
12-24 GPM = 1 1/4" DIAMETER POLYETHYLENE PIPE
24-30 GPM = 1 1/2" DIAMETER POLYETHYLENE PIPE
30-60 GPM = 2" DIAMETER POLYETHYLENE PIPE

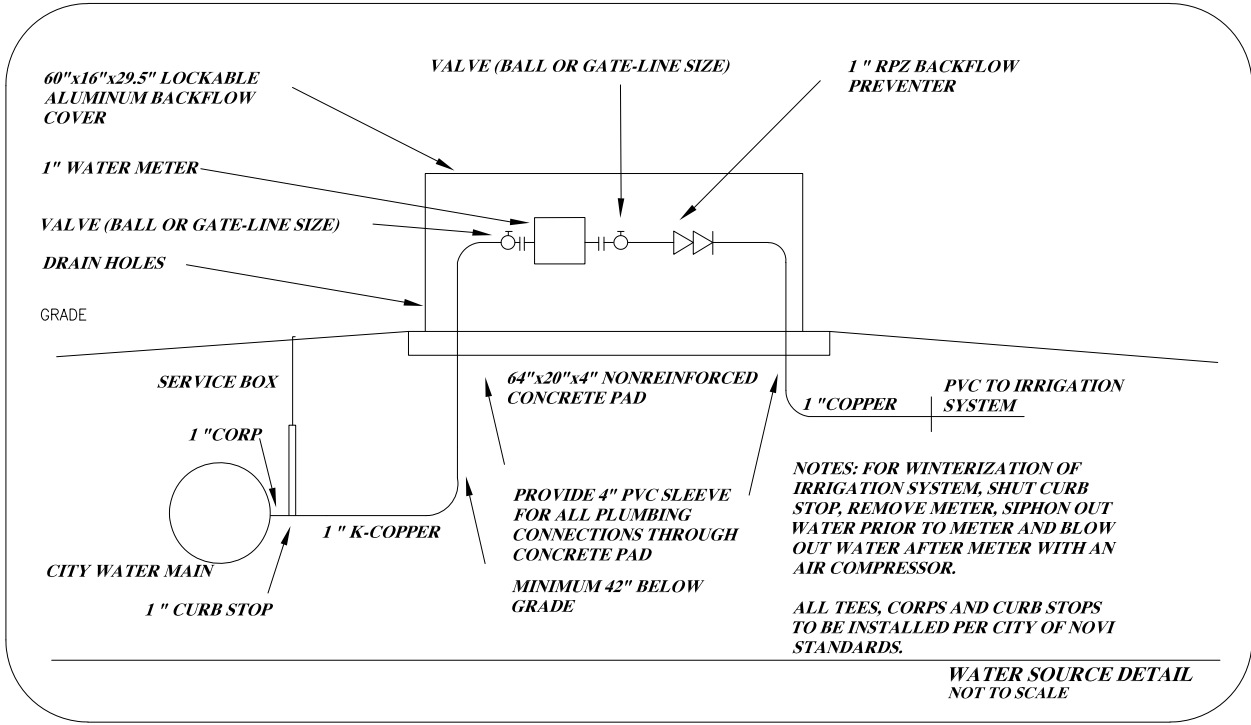

IRRIGATION CONTRACTOR RESPONSIBLE TO COORDINATE INSTALLATION OF WATER MAIN TAP WITH CITY PRIOR TO CONSTRUCTION. ALL PERMITS AND FEES ARE RESPONSIBILITY OF THE IRRIGATION CONTRACTOR. CONTINUE WATER TAP CONSTRUCTION AND CONNECTION TO IRRIGATION SYSTEM PER DETAIL SHOWN.

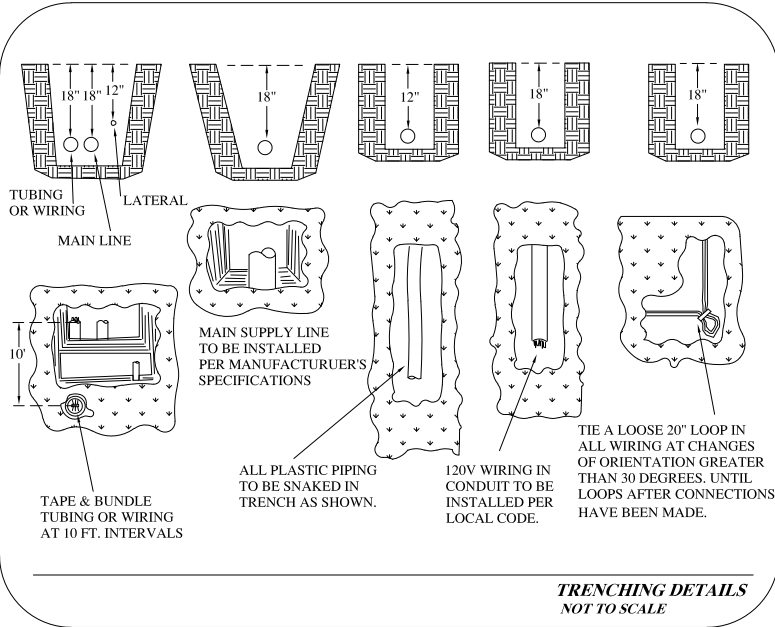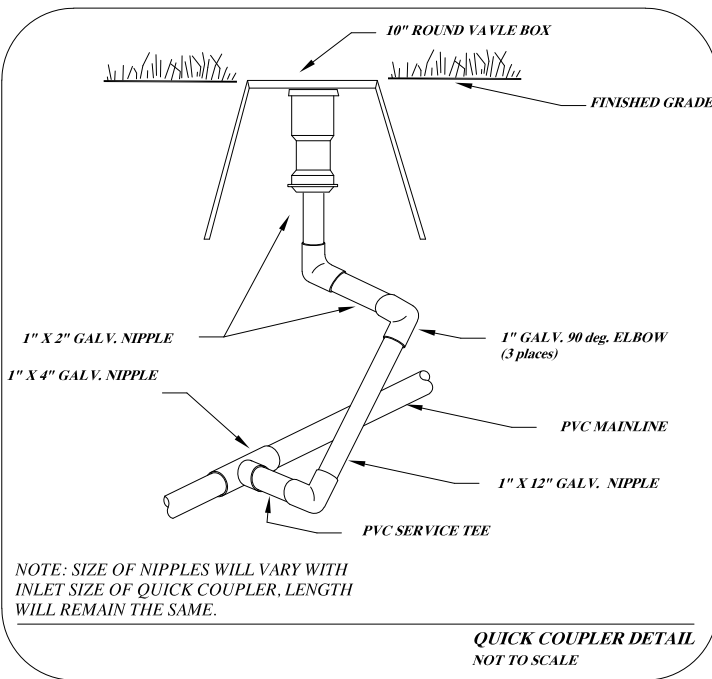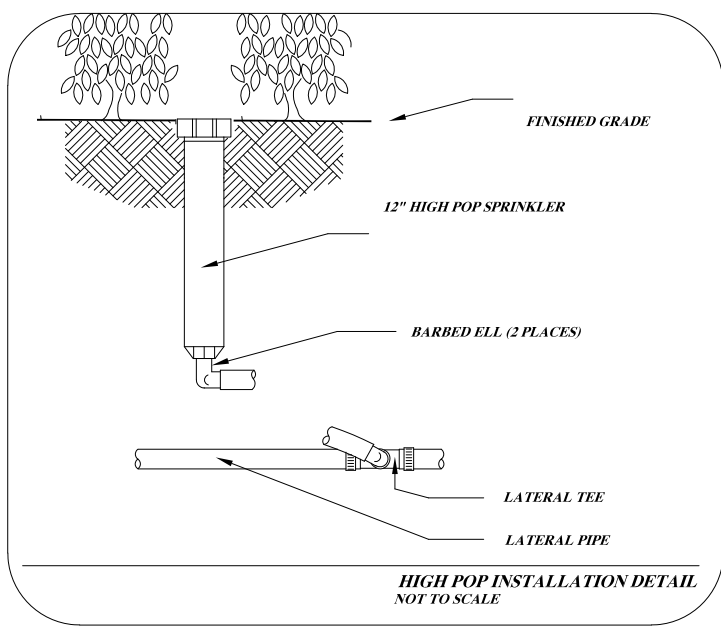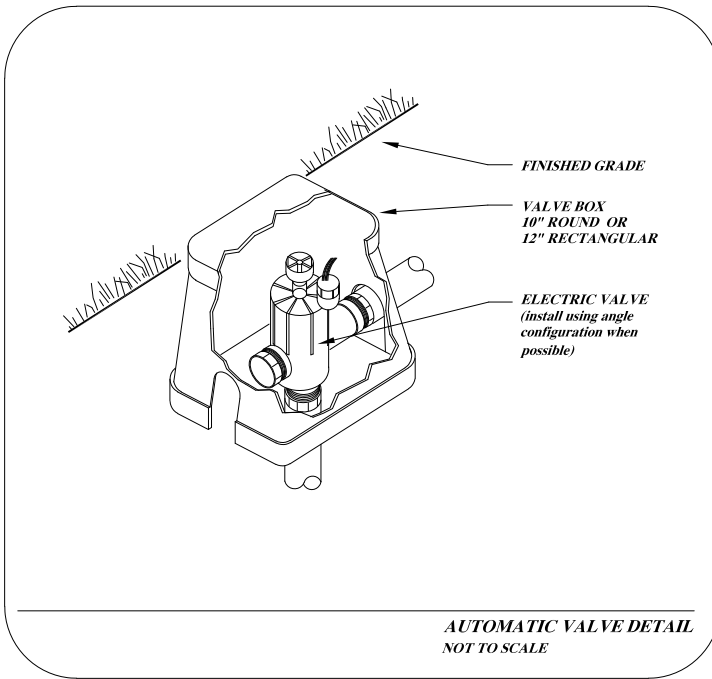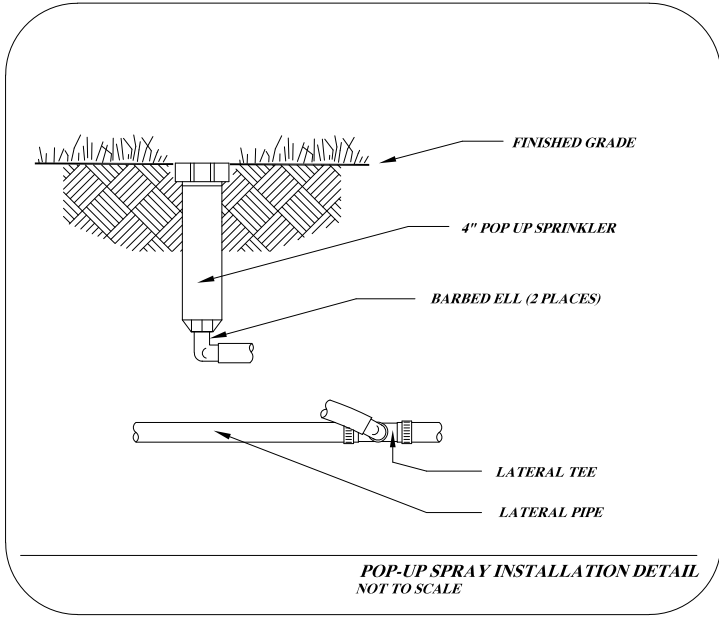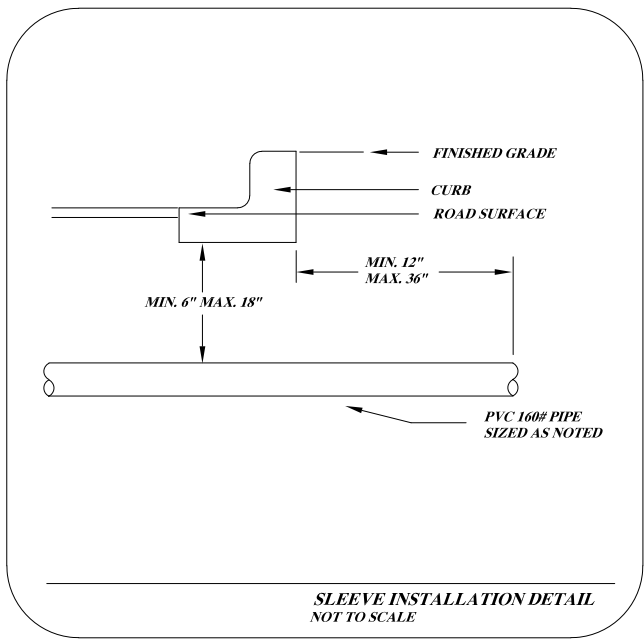

IRRIGATION LEGEND:


Hunter	FIXED SPRAY POP-UP (12") ■ 10 Series ■ 12 Series □ 15 Series ■ Strip Series	PROS-12
	▲ FIXED SPRAY POP-UP (12") w/ 2' radius nozzle	PROS-12-CV
	○ FIXED SPRAY POP-UP (4") w/ MPR nozzle	PROS-04 PRS30-CV
	○ MP1000 ● MP2000 ○ MP3000 ● MPSS530/MPLC(RC)15	
⊕	ELECTRIC MASTER VALVE - LINE SIZE- with Decoder	ICV-Series
⊗	ELECTRIC VALVE -with Decoder	ICV-Series
⊙	QUICK COUPLER VALVE	HQ44 RC
▣	CONTROLLER mount along backside of entrance wall	PRO HC
▾	REDUCED PRESSURE ASSEMBLY	FEBCO 825Y100
■	ISOLATION GATE VALVE (LINE SIZE)	
⊗	RAIN SENSOR DEVICE (Install at all controller locations)	SOLAR SYNC (wireless)
⊗	POINT OF CONNECTION TO WATER SOURCE	See note this sheet
—	PVC MAINLINE, SDR 26, BE, Size as shown	
—	POLYETHYLENE PIPE, 100#, NSF APPROVED, Size as shown	
—	PVC SLEEVES - SDR 26 - Size as shown	
	WATER REQUIREMENTS: 24 GPM @ 65 PSI (CONTRACTOR TO VERIFY PSI AVAILABLE ON SITE PRIOR TO SYSTEM INSTALLATION)	
	VALVE DESIGNATION: Controller and Station Number Valve Size Gallons Per Minute	

NOTES:

- Refer to the specifications for installation details and descriptions, as well as, construction methods which will be accepted.
- All work shall be in compliance with all local, state, and federal codes and ordinances.
- All electrical connections shall be made using 3m DBY-6 splice kits.
- All control wiring downstream of the controller shall be Hunter IDWIRE communication cable UL approved for direct bury.
- All polyethylene lateral pipe clamps shall be stainless steel worm gear type clamps. Lateral pipes 1-1/2" or larger shall be double clamped.
- Pipe routing is schematic. All heads are to be field adjusted to within 2' to take into consideration any obstruction. Final head placements are subject to the landscape architects approval.
- All sprinkler heads shall be mounted on 2 elbow poly swing joints as specified.
- Contractor to verify final controller location with owner's authorized representative prior to installation.
- All pipe not sized downstream of control valve is 1".
- All sleeves shall be PVC SDR 21 (see specifications).
- Irrigation contractor's point of connection to water source shall be as noted on this sheet.
- Locate and connect to indicated water source. All pipe installed above grade shall be copper type "M".
- 120v power to the controller locations should be provided others. Coordinate with owner's representative. Hardwire controller directly to nearest circuit panel. Place all wires in conduit per code.
- Design pressure does not take into account seasonal supply fluctuations. Periods of drought may cause temporary pressure losses to the city water supply resulting in inadequate irrigation system performance. Irrigation design is based on normal weather conditions and typical municipal water supply abilities.
- Irrigation contractor shall be responsible for determining and maintaining the irrigation schedule during the project construction and throughout the length of the warranty period.
- The irrigation schedule shall deliver 1" of precipitation per week +/- natural rainfall quantities for turf grass.
- Landscape material shall receive adjusted amounts of precipitation to maintain proper plant health.
- Landscape and turf grass shall be irrigated separately.
- Rotors and spray zones may not be combined to operate at the same time.



IRRIGATION DESIGN &
WATER MANAGEMENT

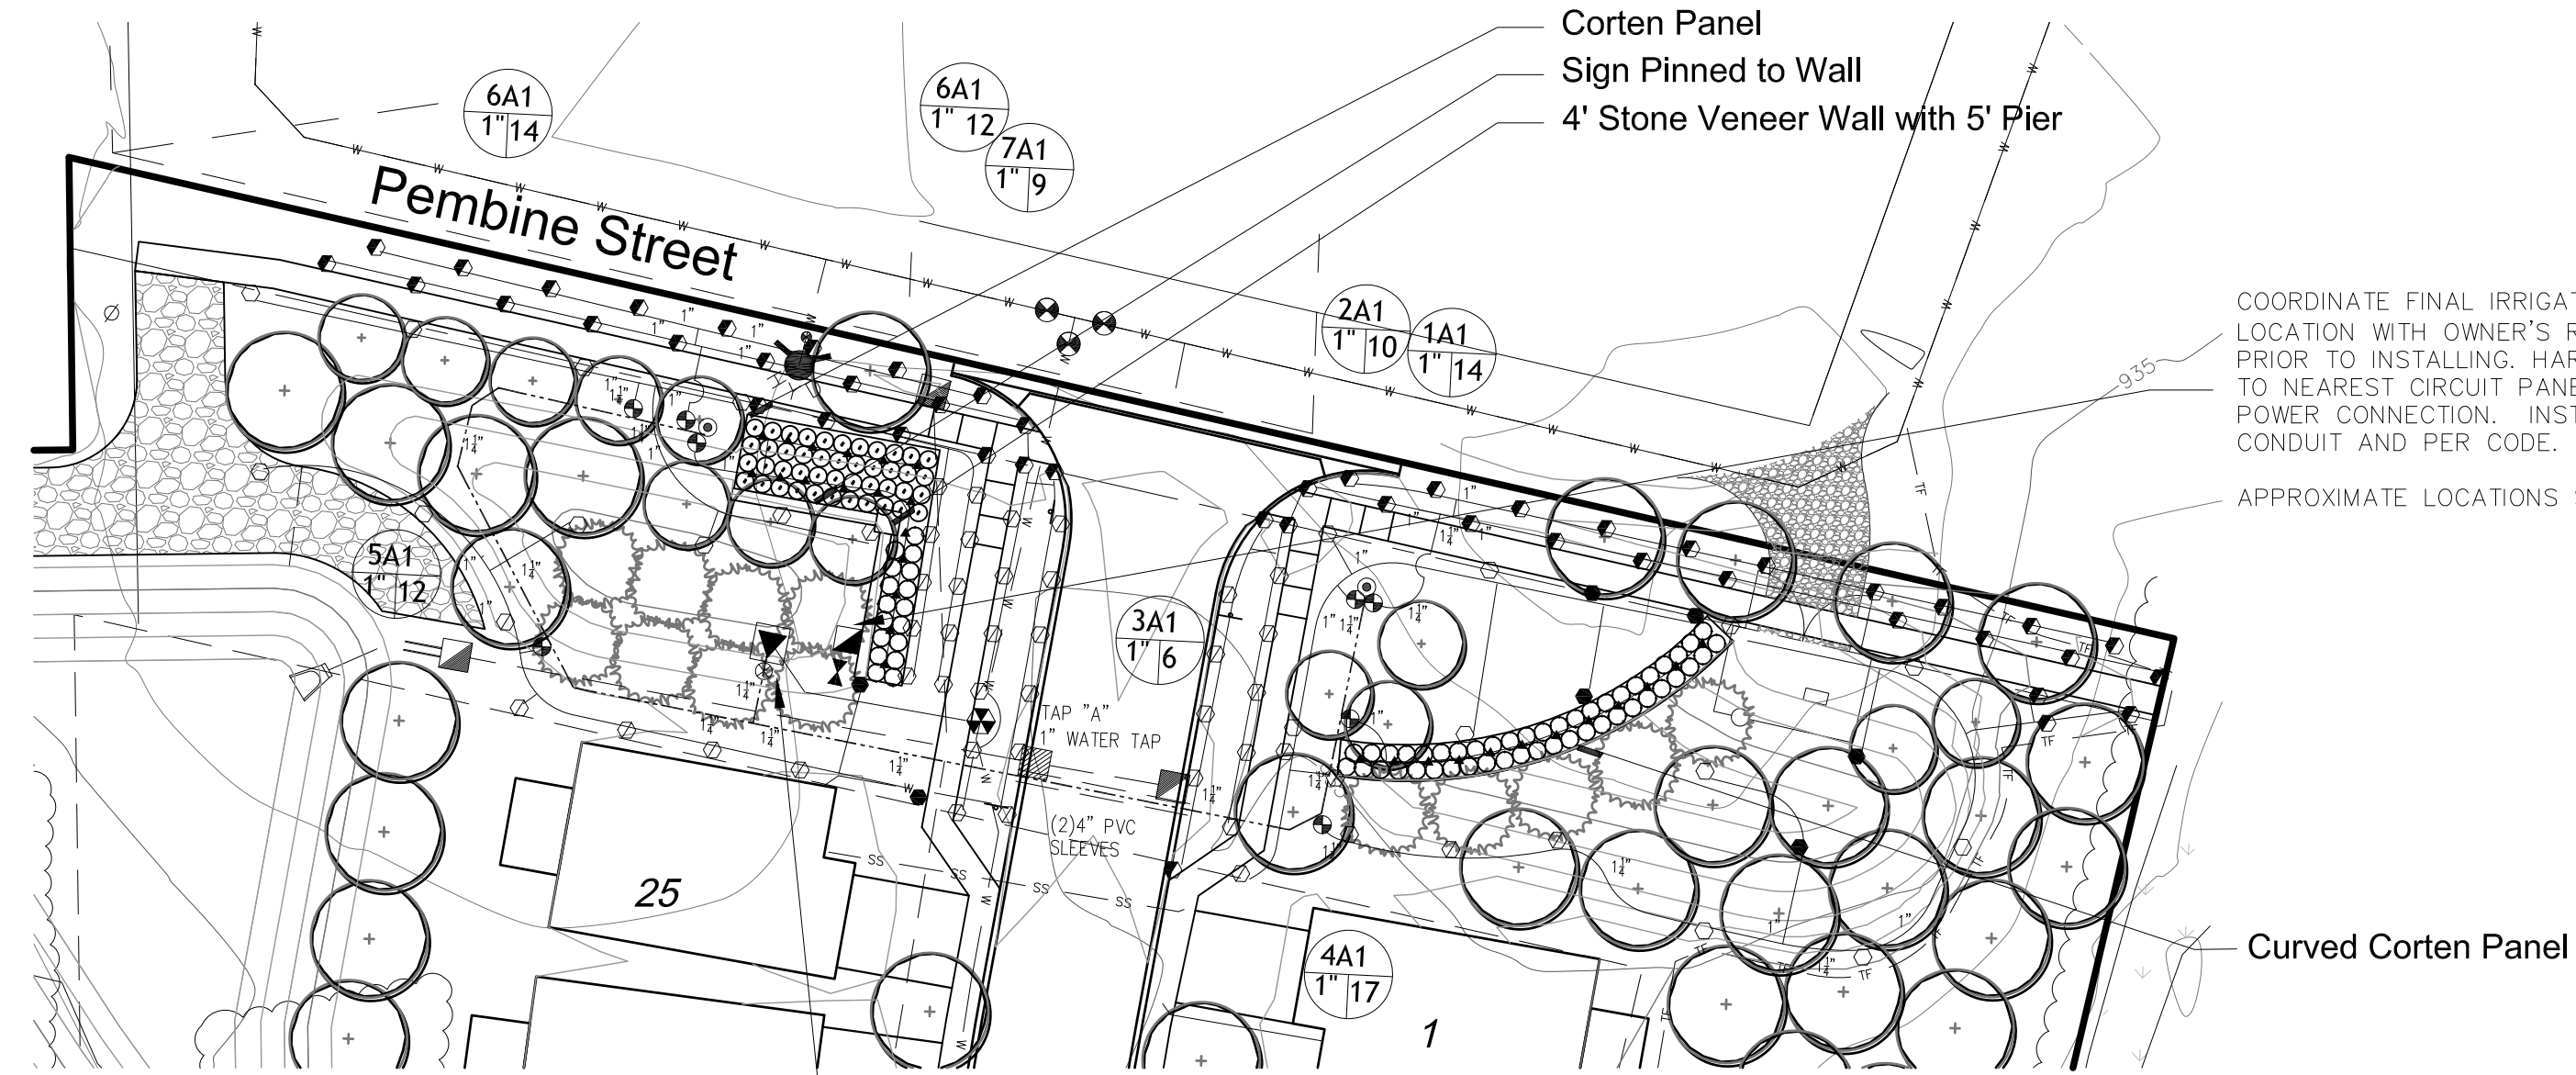

Entry Enlargement

1"=30'

INSTALL A 1" MASTER VALVE AND HC FLOW METER PER MANUFACTURER RECOMMENDATIONS.





PLANNING COMMISSION ACTION SUMMARY

CITY OF NOVI

Regular Meeting

September 25, 2019 7:00 PM

Council Chambers | Novi Civic Center
45175 W. Ten Mile (248) 347-0475

CALL TO ORDER

The meeting was called to order at 7:00 PM.

ROLL CALL

Present: Member Anthony, Member Avdoulos, Member Ferrell, Member Gronachan, Member Lynch, Member Maday

Absent: Chair Pehrson

Also Present: Barbara McBeth, City Planner; Sri Komaragiri, Planner; Kate Richardson, Staff Engineer; Rick Meader, Landscape Architect; Thomas Schultz, City Attorney; Pete Hill, Environmental Consultant; Josh Bocks, Traffic Engineering Consultant; Doug Necci, Façade Consultant

APPROVAL OF AGENDA

Motion to approve the September 25, 2019 Planning Commission Agenda. *Motion carried 6-0.*

CONSENT AGENDA - REMOVALS AND APPROVAL

1. 39500 ORCHARD HILLS PLACE JF19-04 – SECTION 9 WAIVER

Approval of the request of JFK Investment Company, LLC, for 39500 Orchard Hills Place JSP19-04 for a Section 9 waiver related to an exterior remodel. The subject parcel is located in Section 36, west of Haggerty Road north of Eight Mile Road. It is zoned OSC, Office Service Commercial. The existing building was constructed in 1986, prior to the adoption of the Façade Ordinance. The applicant proposes to update the building facades to replace the existing primary material, EIFS, with a Flat Metal Panel system.

In the matter of request of JFK Investment Company, LLC, for 39500 Orchard Hills Place JSP19-04, motion to approve a Section 9 Façade Waiver to allow an underage of brick (30% required, 7% proposed) and an overage of Flat Metal Panels (50 % maximum allowed, 93% proposed) because bringing the existing building into compliance would represent extreme practical difficulty and would not significantly enhance the appearance of the building. *Motion carried 6-0.*

2. CROSSPOINTE MEADOWS ACCESSORY BUILDING JSP 19-36

Approval at the request of Crosspointe Meadows Church for Preliminary Site Plan with a Section 9 waiver. The subject property is located on the eastside of

Meadowbrook Road, south of Thirteen Mile Road in section 12 . The primary building on the property is a Church. The applicant is proposing to build a 480 square feet storage building in the rear yard, adjacent to the existing dumpster. No other changes to the site plan are proposed.

In the matter of Crosspointe Meadows Church Accessory Building, JSP 15-40, motion to approve the Preliminary Site Plan and a Section 9 Waiver, based on and subject to the following:

- a. To allow the underage of brick on south façade (30% minimum required, 23% proposed) and overage of EIFS on the south façade (25% maximum allowed, 44% proposed) and Trim on the south façade (15% maximum allowed, 33% proposed), because the deviations are a result of the large overhead door which is not regulated by the Ordinance and the plan is consistent with the intent and purpose of the Façade Ordinance, which is hereby granted;
- b. A waiver to allow a painted island in lieu of a raised end island near the entrance to the storage shed, because the drive is only used for dumpster pick up and lawn maintenance vehicles, which is hereby granted;
- c. The findings of compliance with Ordinance standards in the staff review letter and the conditions and the items listed in that letter being addressed.

Motion Carried 6-0.

PUBLIC HEARINGS

1. GOLLING MASERATI & ALFA ROMEO JZ19-28 WITH REZONING 18.728

Public hearing at the request of Dorchen/Martin Associates for Planning Commission's recommendation to City Council for a Planned Rezoning Overlay Concept Plan associated with a Zoning Map amendment, to rezone from NCC (Non-Center Commercial) to B-3 (General Business). The subject property is approximately 5.25 acres and is located on the south side of Grand River Avenue, west of Joseph Drive (Section 24). The applicant is proposing an automobile dealership, a permitted use in the B-3 District, with outdoor space for exclusive sale of new and used automobiles, which is a Special Land Use in the B-3 District.

In the matter of Golling Maserati & Alfa Romeo, JZ19-28, with Zoning Map Amendment 18.728, motion to postpone making a recommendation to the City Council to rezone the subject property from NCC (Non-Center Commercial) to B-3 (General Business) with a Planned Rezoning Overlay Concept Plan. This motion is made for the following reason: the applicant requested that the matter be postponed until the October 30th meeting. *Motion Carried 6-0.*

1. SCENIC PINES ESTATES JSP 18-76

Public hearing at the request of Singh Development for Preliminary Site Plan With One-Family clustering Option, Site Condominium, Special Land Use, Wetland Permit, Woodland Permit and Stormwater Management Plan Approval. The subject properties are approximately 9.44 acres and are located south of South Lake Drive and south side of Pembine Drive (Section 3). The applicant is proposing to utilize the One-family Cluster Option to develop a site condominium with 25 single family detached homes.

In the matter of Scenic Pines Estates, JSP 18-76, motion to approve the Special Land Use Permit based on and subject to the following:

1. The proposed use will not cause any detrimental impact on existing thoroughfares *(based on the Traffic review)*;
2. The proposed use will not cause any detrimental impact on the capabilities of public services and facilities;
3. The proposed use is compatible with the natural features and characteristics of the land *(because the applicant is proposing to preserve 53% of qualifying area that includes regulated woodlands and wetlands)*;
4. The proposed use is compatible with adjacent uses of land *(because the subject property is surrounded by single family residential uses. Façade review notes that the proposed elevations portray an overall architectural standard equal or higher than the existing homes in the surrounding neighborhood)*;
5. The proposed use is consistent with the goals, objectives, and recommendations of the City's Master Plan for Land Use *(because the development is age-targeted. The proposed floor plans indicate first-floor master)*;
6. The proposed use will promote the use of land in a socially and economically desirable manner;
7. The proposed use is (1) listed among the provision of uses requiring special land use review as set forth in the various zoning districts of this Ordinance, and (2) is in harmony with the purposes and conforms to the applicable site design regulations of the zoning district in which it is located;
8. The approval shall be subject to the following conditions at that time:
 - a. The Planning Commission finding that Parcel ID No. 22-03-327-004, mentioned in the notes to the site plan, located on the north side of South Lake Drive, is not part of this development and shall not become or be made part of this development, as it does not comply with Sec. 36-62, Lakefront use standards, of the City Code of Ordinances as relates to lakefront recreational parks;
 - b. Maintenance and reconstruction of the roads during and after construction, dust maintenance control and the stipulation that the roads be videotaped before and after construction to determine reconstruction requirements;
 - c. Limit Construction times with respect to elementary school bus schedule;
 - d. Construction traffic to comply with the City load limits; and
9. Final Site Plan shall come back to Planning Commission for Final Approval.

Motion Carried 6-0.

In the matter of Scenic Pines Estates, JSP 18-76, motion to approve the Preliminary Site Plan with One-family clustering option and the Site Condominium based on and subject to the following:

1. Planning Commission's finding per Section 3.28.1.B, that in all one-family residential districts, the clustering of one-family dwellings may be permitted, provided that the land consists of an unsubdivided area and the proposed site plan and, that the conventional approach to residential development would destroy the unique environmental significance of the site, and that the use of the cluster option is a desirable course of action to follow based on the following condition.
 - a. The majority (fifty (50) percent) of the net site area (defined as the area which is delineated by parcel lines, exclusive of rights-of-way as shown on the adopted master plan) is composed of lands that are within jurisdiction of Woodland Protection Ordinance, as amended, Chapter 37 of the Code of Ordinances, or within the jurisdiction of the Wetland and Watercourse Protection Ordinance, as amended, Chapter 12, Article V of the Code of Ordinances, or any combination

of such lands. The applicant is proposing to permanently preserve up to 53% of qualifying area on site.

2. Planning Commission approval for reduction of minimum distance between the clusters, based on the finding, subject to conditions listed in Section 3.28.5., that the strict application of the distance in this instance would destroy a natural amenity such as regulated wetlands and woodlands. This is required for the Units 1-2-3 cluster and the Units 22-23-24-25 cluster. A minimum of 85 feet is required, approximately 78 feet is proposed;
3. Planning Commission approval of reduction of front building setbacks from the streets as listed in Section 3.28.4.D. A minimum of 30 feet is required from the edge of Private drive, the plans currently propose 25 feet in order to protect regulated woodlands in the back yards; this is based on the following findings listed in Section 3.28.6.C:
 - a. All the conditions listed in Section 3.28.6.C. from i thru iv are met with the exception as noted below;
 - b. A Zoning Board of Appeals variance from Section 3.28.6.C.iv.a to allow absence of required berm along the east, west and south property boundaries adjacent to other single-family residential districts;
4. Planning Commission waiver for reduction of the minimum distance for opposite-side spacing requirement, Design and Construction Standards Section 11-216(d), for the roadway spacing between Pristine Lane and Henning Street(A minimum of 200 feet is required, 117 feet is proposed, due to estimated low volume of vehicles expected from the proposed development, which is hereby granted;
5. A landscape waiver for absence of three required street trees along Pembine Street Frontage , as listed in 5.5.3.E.i.c and LDM 1.d., due to lack of space between the edge of pavement and the future Right-of-way ad conflicts with other required proposed utilities and swales, which is hereby granted;
6. A landscape waiver from Section 2.1 of Landscape Design Manual to allow some of the proposed trees to be located outside of the space between the sidewalk and the curb due to conflicts with proposed utilities, which is hereby granted. This waiver is supported as most of the proposed trees are located within 15 feet from the curb, with an exception of three trees;
7. Administrative approval from Engineering for variance from Engineering Design Manual Section 7.4.2.C.1 for not meeting the minimum distance of 15 feet from back of curb to outside edge of sidewalk;
8. The applicant shall revise the woodland replacement plan at the time of final site plan to avoid the conflict between the proposed tree replacement locations and the existing overhead electric line along the western property boundary;
9. The applicant shall obtain necessary approvals from all related outside agencies for the proposed location of storm water pond and related landscape under the existing overhead lines prior to approval of Final site plan;
10. Assurance of the permanence of the open space and its continued maintenance shall be submitted for review and approval by the City Attorney at the time of final site plan approval.
11. The findings of compliance with Ordinance standards in the staff and consultant review letters, and the conditions and items listed in those letters, as well as all of the terms and conditions of the PRO Agreement as approved, with these items being addressed on the Final Site Plan; and
12. The Final Site Plan shall come back to Planning Commission for Final Approval.

Motion Carried 6-0.

In the matter of Scenic Pines Estates, JSP 18-76, motion to approve the **Wetland Permit** based on and subject to the findings of compliance with Ordinance standards in the staff and consultant review letters, and the conditions and items listed in those letters being addressed on the Final Site Plan. *Motion Carried 6-0.*

In the matter of Scenic Pines Estates, JSP 18-76, motion to approve the **Woodland Permit** based on and subject to the findings of compliance with Ordinance standards in the staff and consultant review letters, and the conditions and items listed in those letters being addressed on the Final Site Plan. *Motion Carried 6-0.*

In the matter of Scenic Pines Estates, JSP 18-76, motion to approve the **Stormwater Management Plan**, based on and subject to the findings of compliance with Ordinance standards in the staff and consultant review letters, and the conditions and items listed in those letters being addressed on the Final Site Plan; and the Final Site Plan must come back to Planning Commission for Final Approval. *Motion Carried 6-0.*

MATTERS FOR CONSIDERATION

1. APPROVAL OF THE AUGUST 28, 2019 PLANNING COMMISSION MINUTES

Motion to approve the August 28, 2019 Planning Commission Meeting Minutes. *Motion carried 6-0.*

ADJOURNMENT

The meeting was adjourned at 9:41 PM.

**Actual language of the motions subject to review.*