

#### COMMUNITY DEVELOPMENT DEPARTMENT

45175 Ten Mile Road Novi, MI 48375 (248) 347-0415 Phone (248) 735-5600 Facsimile www.cityofnovi.org

## ZONING BOARD OF APPEALS STAFF REPORT

FOR: City of Novi Zoning Board of Appeals ZONING BOARD APPEALS DATE: March 13, 2018

REGARDING: Parcel # 50-22-11-300-009 (PZ18-0005)

BY: Larry Butler, Deputy Director Community Development

#### . GENERAL INFORMATION:

#### **Applicant**

CA Senior Living Holdings, LLC

#### Variance Type

**Dimensional Variance** 

#### **Property Characteristics**

Zoning District: Office Service & Residential Acreage

Location: East of Novi Road and North of Thirteen Mile Road

Parcel #: 50-22-11-300-009

#### Request

The applicant is requesting variances from the City of Novi Zoning Ordinance Sections 5.4.1 to allow a proposed loading zone in the side yard. Rear yard location required by code. Section 4.19.2.F to allow placement of a proposed dumpster (screened) in the side yard. Rear yard location required by code. Section 4.19.2.A to allow proposed transformer and generator (screened) placement in the side yard. Rear yard location required by code in rear yard by code.

This property is zoned Office Service (OS-1) and Residential Acreage (RA) and is governed by the William R. Eldridge v City of Novi Consent Judgment.

#### II. STAFF COMMENTS:

#### III. RECOMMENDATION:

The Zoning Board of Appeals may take one of the following actions:

1.	I	move	that	we	grant	the	variance	in	Case	No.	PZ18-0005,	sought	by for
	 	fficulty re	equiring	1							oner has sho	own prac	
	<b>G</b>	(a) Wit	thout th	ne vari	ance P	etitior		nreas	sonably	prever	nted or limite	d with resp	sect
		(b) The	e prope	erty is u	ınique b	ecaus	se				·		

		(c)	Petitioner did not create the condition because
		(d)	The relief granted will not unreasonably interfere with adjacent or surrounding properties because
		(e)	The relief if consistent with the spirit and intent of the ordinance because
		(f)	The variance granted is subject to:
			1
			2
			3
			4
2.	I	moʻ	ve that we <u>deny</u> the variance in Case No. <b>PZ18-0005</b> , sought by
			because Petitioner has not shown
	pra	CUC	al difficulty requiring
		(a)	The circumstances and features of the property including are not unique because they
			exist generally throughout the City.
		(b)	The circumstances and features of the property relating to the variance request are self-created because
		(c)	The failure to grant relief will result in mere inconvenience or inability to attain higher economic or financial return based on Petitioners statements that
		(d)	The variance would result in interference with the adjacent and surrounding properties by
		(e)	Granting the variance would be inconsistent with the spirit and intent of the ordinance to
			·

Should you have any further questions with regards to the matter please feel free to contact me at (248) 347-0417.

Larry Butler Deputy Director Community Development City of Novi



45175 Ten Mile Road Novi, MI 48375 (248) 347-0415 Phone (248) 735-5600 Facsimile www.cityofnovi.org

### ZONING BOARD OF APPEALS APPLICATION

#### APPLICATION MUST BE FILLED OUT COMPLETELY

I. PROPERTY INFORMATION (Address	S OF SUBJECT ZBA C	ase) A	Application Fee:						
PROJECT NAME / SUBDIVISION									
Novi Senior living (CA Cenior ADDRESS		LOT/SIUTE/SPACE #	Neeting Date:						
42400 W. 12 Mile Rd.		EO1/3101E/3FACE #							
SIDWELL #	May be o	btain from Assessing	BA Case #: PZ						
50-22-11 -300 -009		ent (248) 347-0485							
CROSS ROADS OF PROPERTY East of Novi Rd. and 12 Mile Rd.									
IS THE PROPERTY WITHIN A HOMEOWNER'S ASSOCIA	IATION JURISDICTION?	REQUEST IS FOR:							
☐ YES 🗹 NO		RESIDENTIAL OM	MERCIAL   VACANT PR	operty 🗆 signage					
DOES YOUR APPEAL RESULT FROM A NOTICE		_ <u></u>		0121111 2 010111102					
II. APPLICANT INFORMATION									
I EM	MAIL ADDRESS		CELL PHONE NO.						
A. APPLICANT	nduggan@ca-ventu	res.com							
NAME	00 0		TELEPHONE NO.						
CA Senior Living Holdings, LLC			312.248.2091						
ORGANIZATION/COMPANY			FAX NO.						
CA Senior Living Holdings, LLC		OUTY	STATE	ZIP CODE					
ADDRESS 130 E. Randolph St. Suite 2100	ì	CITY Chicago	IL	60601					
	I A BRILLOANT IS ALOS	THE PROPERTY OWNER							
	EMAIL ADDRESS	THE PROPERTY OWNER	CELL PHONE NO.						
	TOE QUISCON	PANIES IAM	CELETHONENO						
NAME Mosaic of Novi, LLC	,,,,,,,,,,,,,,,,,,,,,,,,,,,,,,,,,,,,,,,	TELEPHONE NO. 248.530.9199							
ORGANIZATION/COMPANY			FAX NO.						
Mosaic of Novi, LLC									
				710 0005					
ADDRESS		CITY	STATE	ZIP CODE					
2145 Crooks Rd. Suite 210		Troy	STATE MI	48084					
2145 Crooks Rd. Suite 210  III. ZONING INFORMATION				-					
2145 Crooks Rd. Suite 210  III. ZONING INFORMATION  A. ZONING DISTRICT		Troy	MI	-					
2145 Crooks Rd. Suite 210  III. ZONING INFORMATION  A. ZONING DISTRICT	R-3 □ R-4	Troy  □ RM-1 □ RM-2 □	MI   MH	-					
2145 Crooks Rd. Suite 210  III. ZONING INFORMATION  A. ZONING DISTRICT  R-A R-1 R-2 R-2	] R-3	□ RM-1 □ RM-2	MI   MH	-					
2145 Crooks Rd. Suite 210  III. ZONING INFORMATION  A. ZONING DISTRICT  R-A R-1 R-2 R-2		Troy  □ RM-1 □ RM-2 □	MI   MH	-					
2145 Crooks Rd. Suite 210  III. ZONING INFORMATION  A. ZONING DISTRICT  R-A R-1 R-2 R-2  I-1 I-2 RC  B. VARIANCE REQUESTED	] TC □ TC-1	□ RM-1 □ RM-2 □ OTHER OS-1/OSC - Co	MI   MH	-					
2145 Crooks Rd. Suite 210	TC TC-1	Troy  □ RM-1 □ RM-2 □ □ OTHER OS-1/OSC - Co	MH nsent Judgement	-					
2145 Crooks Rd. Suite 210  III. ZONING INFORMATION  A. ZONING DISTRICT  R-A R-1 R-2 RC  I-1 I-2 RC  B. VARIANCE REQUESTED  INDICATE ORDINANCE SECTION (S) AND VAR  1. Section 5.4.1 Variance	TC TC-1  RIANCE REQUESTED:  iance requested	Troy  ☐ RM-1 ☐ RM-2 ☐ OTHER OS-1/OSC - Co	MI  MH Insent Judgement	48084					
2145 Crooks Rd. Suite 210  III. ZONING INFORMATION  A. ZONING DISTRICT  R-A R-1 R-2 RC  I-1 I-2 RC  B. VARIANCE REQUESTED  INDICATE ORDINANCE SECTION (S) AND VAR  1. Section 5.4.1 Vari  2. Section 4.19.2.F Vari	TC TC-1  RIANCE REQUESTED:  iance requested  iance requested	RM-1 RM-2 OS-1/OSC - Co	MH  nsent Judgement  side yard e side yard (scree	ned)					
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2145 Crooks Rd. Suite 210	RIANCE REQUESTED: iance requested iance requested iance requested iance requested	RM-1 RM-2 OTHER OS-1/OSC - Co Allow loading zone in Allow dumpster in the Allow transformer and ge	MI  MH  Insent Judgement  I side yard  E side yard (scree) Inerator in side yard (scree)  Ily Residential (New) \$	ned) screened)					
2145 Crooks Rd. Suite 210   III. ZONING INFORMATION   A. ZONING DISTRICT   R-A   R-1   R-2   RC   R-A   R-1   R-2   RC   R-A   R-1   R-2   RC   R-A   R-A   R-1   R-2   RC   R-A	RIANCE REQUESTED: iance requested iance requested iance requested iance requested iance requested iance requested	Troy  RM-1 RM-2  OTHER OS-1/OSC - Co  Allow loading zone in Allow dumpster in the Allow transformer and ge  ation) \$250 Single Familiation) \$400 Signs \$300	MI  MH Insent Judgement  Side yard Side yard (scree inerator in side yard (scree inerator)  MH  MH IN	ned) screened)					
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2145 Crooks Rd. Suite 210   III. ZONING INFORMATION	RIANCE REQUESTED: iance requested	Troy  RM-1 RM-2  OTHER OS-1/OSC - Co  Allow loading zone in Allow dumpster in the Allow transformer and generation) \$250 Single Familiation) \$400 Signs \$300 eetings (At discretion of Books A PDF	MH Insent Judgement  In side yard In side yard (scree inerator in side yard (scree inerator in side yard (scree inerator))  If (With Violation) \$	ned) screened)  250 400 t property lines					
2145 Crooks Rd. Suite 210   III. ZONING INFORMATION   A. ZONING DISTRICT   R-A   R-1   R-2   RC   R-A   R-1   R-2   RC   R-A	RIANCE REQUESTED: iance requested COO (With Violation) Special M	Troy  RM-1 RM-2  OTHER OS-1/OSC - Co  Allow loading zone in Allow dumpster in the Allow transformer and generation) \$250 Single Familiation) \$400 Signs \$300 eetings (At discretion of Boto AS A PDF  Existing & proposed Location of existing	MH Insent Judgement  I side yard E side yard (scree Inerator in side yard (scree Inerator in side yard (scree) I (With Violation) \$ I (	ned) screened)  250 400  t property lines applicable					



### **ZONING BOARD OF APPEALS APPLICATION**

V. VARIANCE
A. VARIANCE (S) REQUESTED
☑ DIMENSIONAL ☐ USE ☐ SIGN
There is a five-(5) hold period before work/action can be taken on variance approvals.
B. SIGN CASES (ONLY) Your signature on this application indicates that you agree to install a Mock-Up Sign ten-(10) days before the schedule ZBA meeting. Failure to install a mock-up sign may result in your case not being heard by the Board, postponed to the next schedule ZBA meeting, or cancelled. A mock-up sign is NOT to be actual sign. Upon approval, the mock-up sign must be removed within five-(5) days of the meeting. If the case is denied, the applicant is responsible for all costs involved in the removal of the mock-up or actual sign (if erected under violation) within five-(5) days of the meeting.
C. ORDINANCE
City of Novi Ordinance, Section 3107 – Miscellaneous
No order of the Board permitting the erection of a building shall be valid for a period longer than one-(1) year, unless a building permit for such erection or alteration is obtained within such period and such erection or alteration is started and proceeds to completion in accordance with the terms of such permit.
No order of the Board permitting a use of a building or premises shall be valid for a period longer than one-hundred and eighty-(180) days unless such use is establish within such a period; provided, however, where such use permitted is dependent upon the erection or alteration or a building such order shall continue in force and effect if a building permit for such erection or alteration is obtained within one-(1) year and such erection or alteration is started and proceeds to completion in accordance with the terms of such permit.
D. APPEAL THE DETERMINATION OF THE BUILDING OFFICIAL
PLEASE TAKE NOTICE:
The undersigned hereby appeals the determination of the Building Official / Inspector or Ordinance made  CONSTRUCT NEW HOME/BUILDING  ACCESSORY BUILDING  USE  OTHER
VI APPLICANT & PROPERTY SIGNATURES
VI. APPLICANT & PROPERTY SIGNATURES  A. APPLICANT  Applicant Signature  Date
A. APPLICANT  Applicant Signature  B. PROPERTY OWNER  If the applicant is not the owner, the property owner must read and sign below:  The undersigned affirms and acknowledges that he, she or they are the owner(s) of the property described in this application, and is/are owner of the contents of this application and related enclosures.
A. APPLICANT  Applicant Signature  B. PROPERTY OWNER  If the applicant is not the owner, the property owner must read and sign below:  The undersigned affirms and acknowledges that he, she or they are the owner(s) of the property described in this
A. APPLICANT  Applicant Signature  B. PROPERTY OWNER  If the applicant is not the owner, the property owner must read and sign below:  The undersigned affirms and acknowledges that he, she or they are the owner(s) of the property described in this application, and is/are aware of the contents of this application and related enclosures.  1-30-2018
A. APPLICANT  Applicant Signature  B. PROPERTY OWNER  If the applicant is not the owner, the property owner must read and sign below:  The undersigned affirms and acknowledges that he, she or they are the owner(s) of the property described in this application and is/are aware of the contents of this application and related enclosures.  Property Owner Signature  1-30-2018  Date
A. APPLICANT Applicant Signature  B. PROPERTY OWNER If the applicant is not the owner, the property owner must read and sign below: The undersigned affirms and acknowledges that he, she or they are the owner(s) of the property described in this application, and is/are aware of the contents of this application and related enclosures.  Property Owner Signature  VII. FOR OFFICIAL USE ONLY
A. APPLICANT Applicant Signature  B. PROPERTY OWNER If the applicant is not the owner, the property owner must read and sign below: The undersigned affirms and acknowledges that he, she or they are the owner(s) of the property described in this application, and is/are aware of the contents of this application and related enclosures.  Property Owner Signature  VII. FOR OFFICIAL USE ONLY  DECISION ON APPEAL:  GRANTED  GRANTED



#### **Community Development Department**

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### REVIEW STANDARDS DIMENSIONAL VARIANCE

The Zoning Board of Appeals (ZBA) will review the application package and determine if the proposed Dimensional Variance meets the required standards for approval. In the space below, and on additional paper if necessary, explain how the proposed project meets each of the following standards. (Increased costs associated with complying with the Zoning Ordinance will not be considered a basis for granting a Dimensional Variance.)

#### Standard #1. Circumstances or Physical Conditions.

Explain the circumstances or physical conditions that apply to the property that do not apply generally to other properties in the same zoning district or in the general vicinity. Circumstances or physical conditions may include:

a. Shape of Lot. Exceptional narrowness, shallowness or shape of a specific property in existence on the effective date of the Zoning Ordinance or amendment. Describe below:

The lot is very narrow and the rear end of the lot is heavily wooded so our goal was to avoid removing too many trees in the rea by adding equiment and loading access.

OR

**b. Environmental Conditions.** Exceptional topographic or environmental conditions or other extraordinary situations on the land, building or structure. **Describe below:** 

OR

c. Abutting Property. The use or development of the property immediately adjacent to the subject property would prohibit the literal enforcement of the requirements of the Zoning Ordinance or would involve significant practical difficulties. **Describe below:** 

#### Standard #2. Not Self-Created.

Describe the immediate practical difficulty causing the need for the Dimensional Variance, that the need for the requested variance is not the result of actions of the property owner or previous property owners (i.e., is not self-created).

The difficult is caused by the shape of the site and existing woodlands. The nature of the design of senior living project requires that service elements be in the center of the building.

#### Standard #3. Strict Compliance.

Explain how the Dimensional Variance in strict compliance with regulations governing area, setback, frontage, height, bulk, density or other dimensional requirements will unreasonably prevent the property owner from using the property for a permitted purpose, or will render conformity with those regulations unnecessarily burdensome.

The variance allows us to avoid extending the buildable any further north into the woodlands than necessary. The nature of the building is such that the service areas need to be centrally located for safety, efficiency and operations.

#### Standard #4. Minimum Variance Necessary.

Explain how the Dimensional Variance requested is the minimum variance necessary to do substantial justice to the applicant as well as to other property owners in the district.

Although the elements are proposed in the side yard they are screen both by the building and the screen walls. None of which can be seen from the front of the property. While they aren't in the rear of the property these are in the rear of the building. The narrow shape of the site lends itself to this arrangment.

#### Standard #5. Adverse Impact on Surrounding Area.

Explain how the Dimensional Variance will not cause an adverse impact on surrounding property, property values, or the use and enjoyment of property in the neighborhood or zoning district.

The side yard faces a cemetary which is then additionally screened with landscaping as to not impact their enjoyment.

# NOVI SENIOR COMMUNITY PROJECT PRELIMINARY SITE PLAN

A PART OF THE SOUTHWEST 1/4 OF SECTION 11, TOWN 1 NORTH, RANGE 8 EAST, CITY OF NOVI, OAKLAND COUNTY, MICHIGAN

13 MILE ROAD

### DESCRIPTION OF PROPERTY (OF RECORD)

PART OF TAX ID . 22-11-300-009

PART OF THE SOUTHWEST 1/4 OF SECTION 11, TOWN 1 NORTH, RANGE 8 EAST, CITY OF NOVI OAKLAND COUNTY, MICHIGAN; MORE PARTICULARLY DESCRIBED AS: COMMENCING AT THE SOUTH 1/4 CORNER OF SAID SECTION 11; THENCE NO0°14'12"E, 90.00 FEET, ALONG THE NORTH AND SOUTH 1/4 LINE OF SAID SECTION 11, TO THE POINT OF BEGINNING; THENCE DUE WEST, 399.75 FEET (PREVIOUSLY DESCRIBED AS 400.00 FEET), (SAID LINE BEING 90.00 FEET NORTH OF AND PARALLEL TO THE SOUTH LINE OF SAID SECTION 11 AND THE CENTERLINE OF TWELVE MILE ROAD); THENCE NO0°23'54"E, 296.70 FEET; THENCE DUE WEST, 1.09 FEET; THENCE NO0°14'12"E, 762.31 FEET; THENCE DUE EAST, 400.00 FEET, TO A POINT ON THE NORTH AND SOUTH 1/4 LINE OF SAID SECTION 11, (SAID POINT BEING SO0'14'12"W, 1483.34 FEET, FROM THE CENTER OF SAID SECTION 11); THENCE S00°14'12"W, 1059.00 FEET, ALONG THE NORTH AND SOUTH 1/4 LINE OF SAID SECTION 11. TO THE POINT OF BEGINNING. ALL OF THE ABOVE CONTAINING 9.720 ACRES.

ALL OF THE ABOVE BEING SUBJECT TO EASEMENT, RESTRICTIONS AND RIGHT-OF-WAY OF RECORD.

DESCRIPTION OF PROPERTY (AS SURVEYED)

PART OF TAX ID . 22-11-300-009

PART OF THE SOUTHWEST 1/4 OF SECTION 11, TOWN 1 NORTH, RANGE 8 EAST, CITY OF NOVI OAKLAND COUNTY, MICHIGAN; MORE PARTICULARLY DESCRIBED AS: COMMENCING AT THE SOUTH 1/4 CORNER OF SAID SECTION 11; THENCE NO0°13'43"E, 90.00 FEET, ALONG THE NORTH AND SOUTH 1/4 LINE OF SAID SECTION 11, TO THE POINT OF BEGINNING; THENCE DUE WEST, 399.73 FEET, (SAID LINE BEING 90.00 FEET NORTH OF AND PARALLEL TO THE SOUTH LINE OF SAID SECTION 11 AND THE CENTERLINE OF TWELVE MILE ROAD); THENCE NO0°23'54"E, 296.70 FEET; THENCE DUE WEST, 1.09 FEET; THENCE NO0°14'12"E, 762.31 FEET; THENCE DUE EAST, 399.84 FEET, TO A POINT ON THE NORTH AND SOUTH 1/4 LINE OF SAID SECTION 11, (SAID POINT BEING SO0°13'43"W, 1483.48 FEET, FROM THE CENTER OF SAID SECTION 11); THENCE S00°13'43"W, 1059.00 FEET, ALONG THE NORTH AND SOUTH 1/4 LINE OF SAID SECTION 11, TO THE POINT OF BEGINNING. ALL OF THE ABOVE CONTAINING 9.718 ACRES.

ALL OF THE ABOVE BEING SUBJECT TO EASEMENT, RESTRICTIONS AND RIGHT-OF-WAY OF RECORD.

#### **GENERAL NOTES:**

. THE CONTRACTOR SHALL NOTIFY THE CITY OF NOVI ENGINEERING DIVISION (248-347-0454) 48 HOURS PRIOR TO THE START OF CONSTRUCTION OF PUBLIC UTILITIES OR CONSTRUCTION IN THE STREET RIGHT OF WAY.

2. ON SITE PARKING SHALL BE PROVIDED FOR CONSTRUCTION WORKERS.

3. ALL ON-SITE STORAGE TANKS, EXCEPT THOSE CONTAINING POTABLE WATER, SHALL BE PROVIDED WITH SECONDARY CONTAINMENT EQUAL TO A MINIMUM 110% OF TANK CAPACITY.


4. ALL POTENTIAL UTILITY CONFLICTS MUST BE PHYSICALLY DETERMINED PRIOR TO THE START OF CONSTRUCTION OF UTILITIES. AN ENGINEERING INSPECTOR MUST BE PRESENT.

5. UNDERGROUND SANITARY SEWER, WATER MAIN, AND STORM SEWER ARE SHOWN PER RECORD LOCATION WHERE NOT PHYSICALLY EVIDENT. ALL SIZES AND LOCATIONS ARE TO BE VERIFIED PRIOR TO AN CONSTRUCTION.

6. UNDERGROUND ELECTRIC, TELEPHONE, AND GAS LINE LOCATIONS ARE UNKNOWN AND NOT SHOWN AT THIS TIME. COPIES OF THE SURVEY WILL BE SENT TO THE RESPECTIVE COMPANIES REQUESTING THEIR LOCATIONS AND REVISIONS WILL BE MADE UPON RECEIPT OF THEIR COMMENTS.

7. TREE REMOVAL PERMIT IS REQUIRED.

8. STREET SIGNS SHALL BE INSTALLED IN ACCORDANCE WITH THE REQUIREMENTS OF THE CITY OF NOVI.

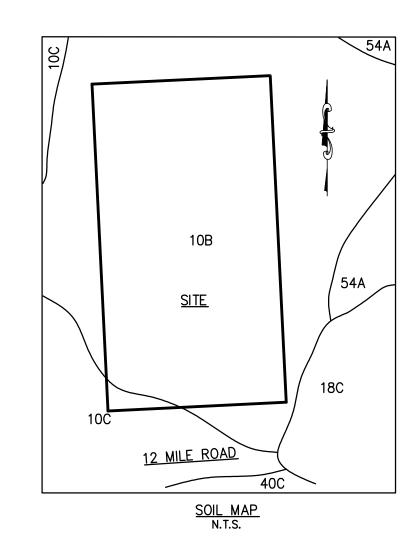

10B Marlette sandy loam, 1 to 6 percent slopes 10C Marlette sandy loam, 6 to 12 percent slopes 18C Fox sandy loam, 6 to 12 percent slopes 40A Udorthents, loamy, nearly level 40C Udorthents, loamy, rolling

54A Matherton sandy loam, 0 to 3 percent slopes

### **PERMITS** SANITARY PERMIT # WATER MAIN PERMIT # W ISSUED SOIL EROSION PERMIT # DEQ WETLAND PERMIT # ISSUED **ISSUED** NPDES PERMIT # MIR

FIRE MARSHALL APPROVAL



# SECTION 11, T1N, R8E, CITY OF NOVI SITE OAKLAND COUNTY. MICHIGAN 12 MILE ROAD **LOCATION MAP** SCALE: 6" = 1 MILE

ALL DRAWINGS, SPECIFICATIONS, AND OTHER RELATED DOCUMENTS ARE THE COPYRIGHT PROPERTY OF FAZAL KHAN & ASSOC. INC. AND SHALL BE RETURNED UPON REQUEST.

REPRODUCTION OF DRAWINGS AND RELATED DOCUMENTS, IN WHOLE OR IN PART, IS FORBIDDEN WITHOUT THE WRITTEN PERMISSION OF FAZAL KHAN & ASSOCIATES INC.

THE CONTRACTOR SHALL CHECK AND VERIFY ALL PERTINENT DIMENSIONS AND REPORT ANY DISCREPANCIES TO FAZAL KHAN & ASSOCIATES INC. BEFORE PROCEEDING WITH THE WORK.

ALL CONSTRUCTION SHALL CONFORM TO THE CURRENT STANDARDS AND SPECIFICATIONS OF ALL GOVERNING AGENCIES.

ALL WATER MAINS, SANITARY SEWERS (AND LEADS) AND STORM SEWERS UNDER PROPOSED OR EXISTING PAVEMENT OR WITHIN 3 FT. OF PAVEMENT TO BE SAND BACK FILLED AND COMPACTED TO 95% OPTIMUM DENSITY (PROCTOR), ALSO ALL UTILITY CROSSINGS TO BE SAND BACKFILLED. SAND BACK FILLING TO BE INCIDENTAL TO CONTRACT.

### **INDEX OF SHEETS**

SHEET C-1 **COVER SHEET** 

SHEET C-2 **BOUNDARY AND TOPOGRAPHIC SURVEY** SHEET C-3 TREE SURVEY AND TREE REMOVAL PLAN

SHEET C-4 TREE LIST

**SHEET C-5** PRELIMINARY SITE PLAN

SHEET C-6 PRELIMINARY SITE PLAN DETAILS SHEET C-7 PRELIMINARY GRADING PLAN

SHEET C-8 PRELIMINARY SITE CROSS SECTIONS SHEET C-9 PRELIMINARY UTILITY PLAN

SHEET C-10 PRELIMINARY STORM WATER MANAGEMENT PLAN

PRELIMINARY DRAINAGE AREA MAP AND **SHEET C-11** 

STORM CALCULATIONS

SIGHT DISTANCE PLAN SHEET C-12 SHEET L-1 LANDSCAPE PLAN - SOUTH

SHEET L-2 LANDSCAPE PLAN - NORTH SHEET L-3 LANDSCAPE DETAILS

**OBSERVATION DECK DETAILS** SHEET L-4 PHOTOMETRIC PLAN **SHEET PM-1** 

**SHEET A1.1** LEVEL 1 SHEET A1.2 LEVEL 2 LEVEL 3 **SHEET A1.3** 

**SHEET A5.1 EXTERIOR ELEVATIONS** SHEET A5.2 **EXTERIOR ELEVATIONS** 

### OWNER / DEVELOPER

CA SENIOR LIVING HOLDINGS, LLC 130 EAST RANDOLPH STREET, SUITE 2100

CHICAGO, IL 60601 PHONE: 312-248-2091


### SURVEYOR / ENGINEER


FAZAL KHAN AND ASSOCIATES, INC. 43279 SCHOENHERR ROAD STERLING HEIGHTS, MI 48313

PHONE: 586-739-8007

REVISIONS

SHE

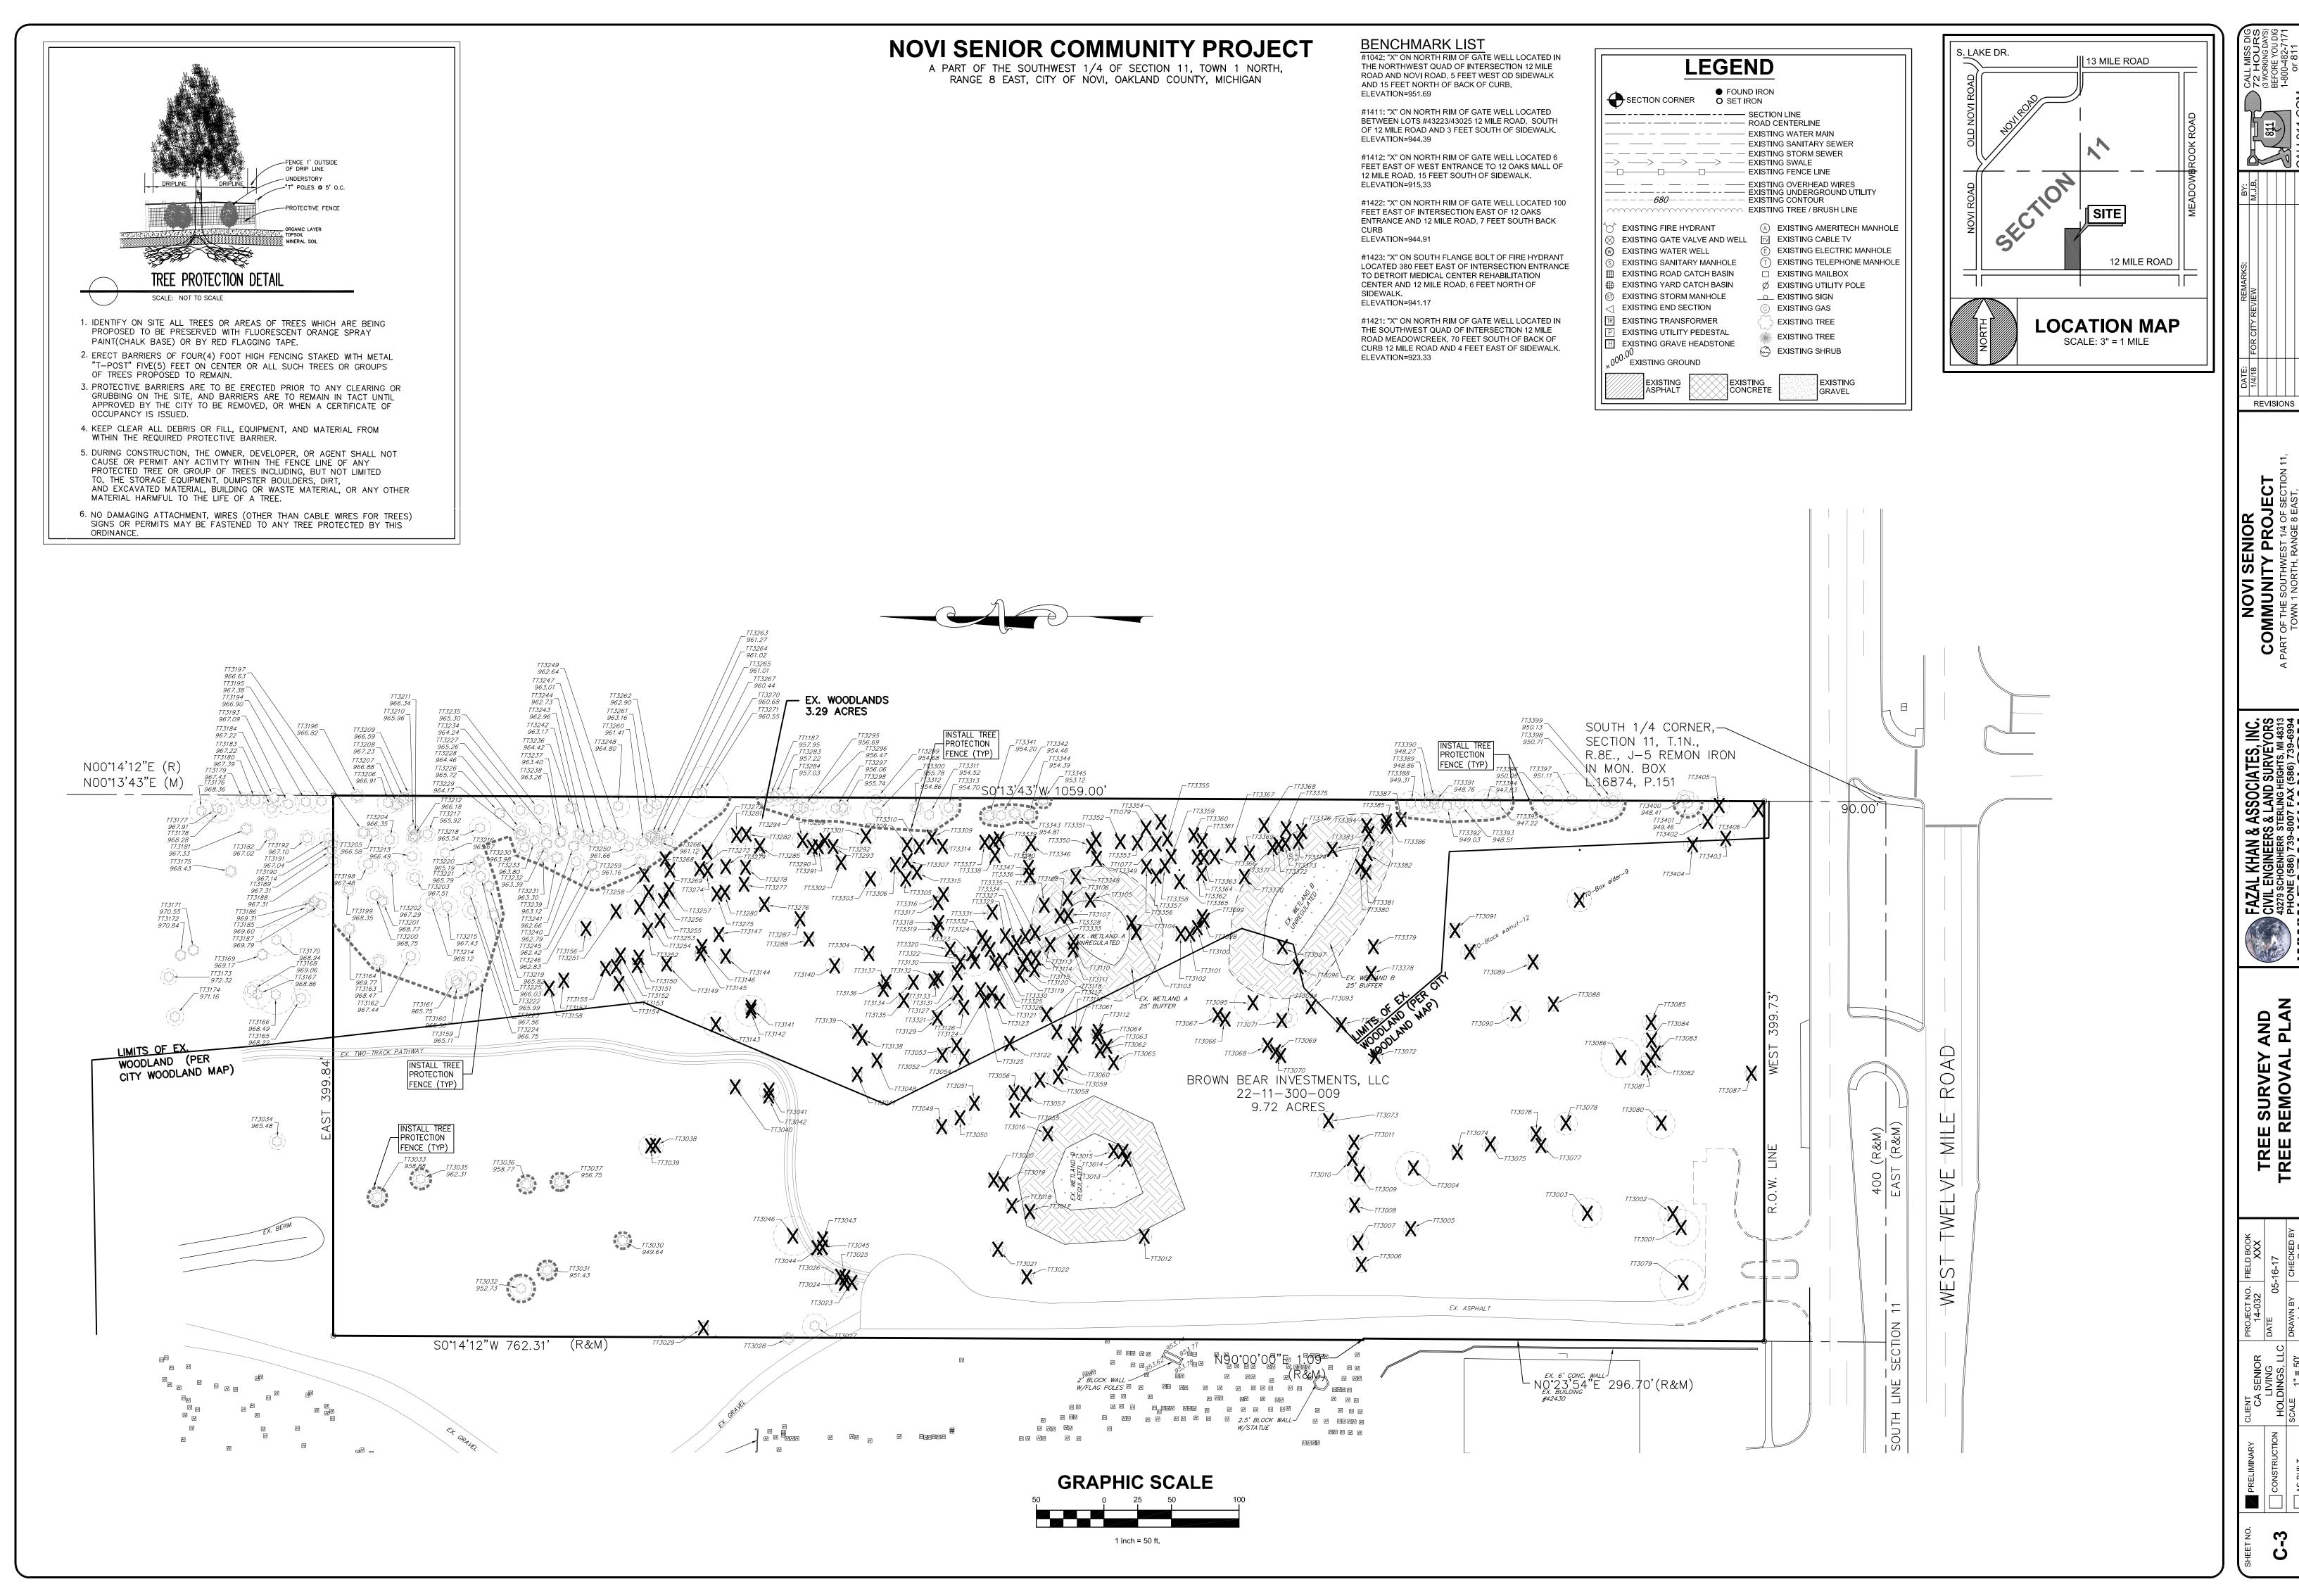

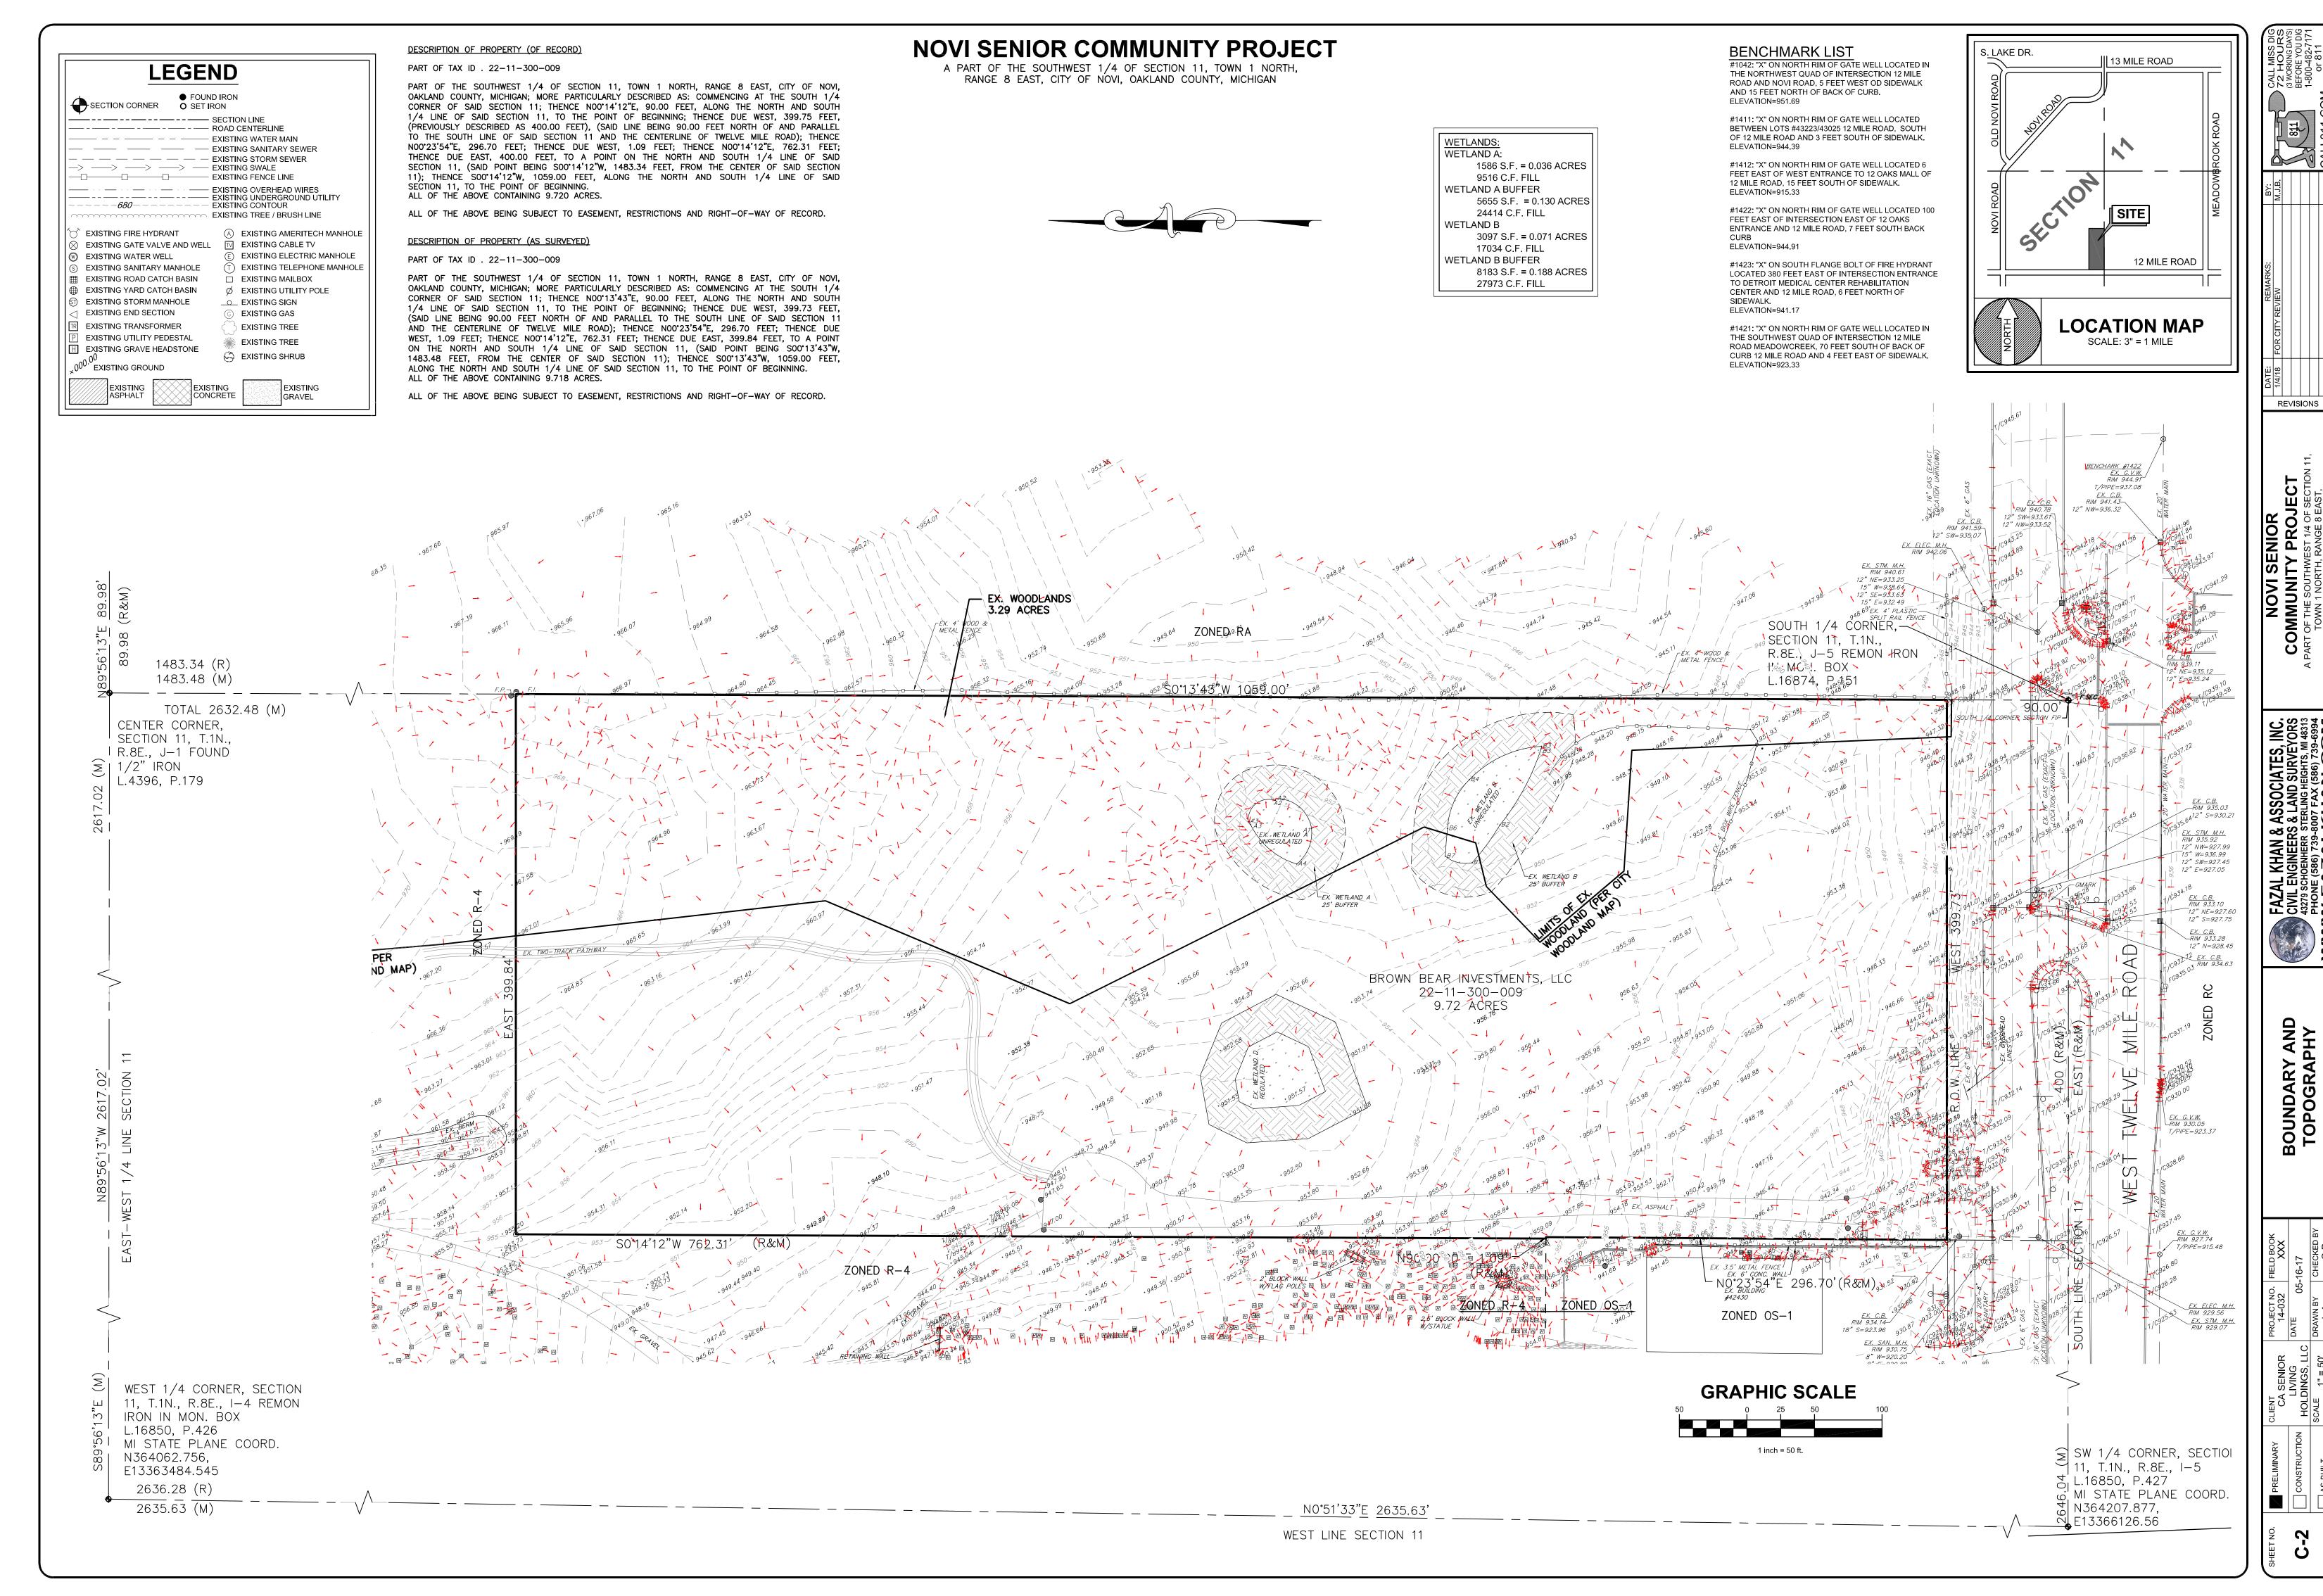


#### \*\* Trees < 50% condition rating, all others >50% rating Bold tag numbers indicate specimen trees

<b>Tag #</b> 1077	Common Name	Scientific Name	DBH (in)	Inches	DBI	l of 2	Sten	ns (in)	Notes/Condition	Save/Remove Remove	Replaceme 1
.079										Save Save	0
002	Blue spruce Blue spruce Red maple	Picea pungens Picea pungens Acer rubrum	27.1 20.4 22.7	20.0					SW Property Corner	Remove Remove	3 3
004	White ash Apple	Fraxinus americana Malus spp.	25.0 11.5	25.0 11.0	9.0	6.5			** <50% ISA Health & Condition Std. Factor Multiple	Remove Remove	3
007	Scots pine Scots pine	Pinus sylvestris Pinus sylvestris	12.0 16.9	12.0 16.0	1.3				Double	Remove Remove	2 2
009	Scots pine Scots pine Scots pine	Pinus sylvestris Pinus sylvestris Pinus sylvestris	13.0 17.1 10.0	13.0 17.0 10.0						Remove Remove	2 2 1
012	Scots pine Eastern cottonwood	Pinus sylvestris Populus deltoides	12.3 11.0	12.0 11.0	11.6 9.0	7.0			Double Multiple	Remove Remove	3 4
8014	Eastern cottonwood Eastern cottonwood Eastern cottonwood	Populus deltoides Populus deltoides Populus deltoides	11.5 10.8 8.2	11.5 10.0 8.0						Remove Remove	2 1 1
	American elm Easter red cedar	Ulmus americana Juniperus virginiana	8.6 11.0	8.0 11.0						Remove Remove	1 1
	American elm	Juniperus virginiana Ulmus americana	9.5	9.0						Remove Remove	1 1
3021	Eastern red cedar White ash Crabapple	Juniperus virginiana Fraxinus americana Malus spp.	9.0 12.0 10.7	9.0 12.0 10.0	11.8				Multiple	Remove Remove	2 3
3023	Black willow Eastern cottonwood	Salix nigra Populus deltoides	9.0 22.0	9.0 22.0	7.0				·	Remove Remove	1 3
	Eastern cottonwood Eastern cottonwood Black willow	Populus deltoides Populus deltoides Salix nigra	11.0 23.0 18.0	11.0 23.0 18.0						Remove Remove	3 2
3028		Salix nigra Salix nigra	9.5 8.3	9.0 8.0	9.5	7.8			Multiple	Offsite Save	0
3031	Eastern red cedar Eastern red cedar	Juniperus virginiana Juniperus virginiana	8.3 10.0	10.0						Save Save	0 0
3033	Eastern red cedar White ash Eastern red cedar	Juniperus virginiana Fraxinus americana Juniperus virginiana	16.6 10.8 12.0	16.0 10.0 12.0	8.0	8.5			Multiple, infested with emerald ash borer	Save Remove Save	0
	Norway maple Easter red cedar	Acer platanoides Juniperus virginiana	11.5 9.1	11.0 9.0	7.0				Double	Save Save	0
3038	American elm Scots pine	Malus spp.  Ulmus americana  Pinus sylvestris	9.0 9.0 18.0	9.0 9.0 18.0	7.5				Double	Save Remove Remove	0 1 2
3040 3041	Eastern red cedar Black cherry	Juniperus virginiana Prunus serotina	10.0 15.1	10.0 15.0	8.4				Double	Remove Remove	3 2
3043		Malus spp.  Populus deltoides  Populus deltoides	8.0 8.5 9.0	8.0 8.0 9.0					Poor	Remove Remove	1 1 1
3045	Eastern cottonwood Eastern cottonwood White ash	Populus deltoides Populus deltoides Fraxinus americana	9.0 14.9 29.0	9.0 14.0 29.0					** <50% ISA Health & Condition Std. Factor	Remove Remove Remove	2 3
3047 3048	Black locust Eastern red cedar	Robinia pseudoacacia Juniperus virginiana	8.5 9.3	8.0 9.0						Remove Remove	1 1
3050	Black locust Black locust	Robinia pseudoacacia Robinia pseudoacacia Robinia pseudoacacia	12.0 17.1 11.8	12.0 17.0 11.0	9.5				Double	Remove Remove	3 2 2
3052	Black locust	Robinia pseudoacacia Robinia pseudoacacia	11.5 14.1	11.0 14.0						Remove Remove	2
3055	Black locust Black locust	Robinia pseudoacacia Robinia pseudoacacia	12.4 12.6 11.0	12.0 12.0 11.0	11.5 10.5				Double Double	Remove Remove	3 3 1
3057	Black locust Black locust	Robinia pseudoacacia Robinia pseudoacacia Robinia pseudoacacia	12.4 14.3	12.0 14.0						Remove Remove	2 2
3060	Black locust Black locust	Robinia pseudoacacia Robinia pseudoacacia	16.4	16.0						Remove Remove	1
3062	Black locust Black locust	Robinia pseudoacacia Robinia pseudoacacia Robinia pseudoacacia	14.5 11.3 10.3	14.0 11.0 10.0						Remove Remove	2 2 1
3064	Black locust American elm	Robinia pseudoacacia Ulmus americana	8.3 19.5	8.0 19.0						Remove Remove	1 2
3067	Apple Scots pine Black cherry	Malus spp.  Pinus sylvestris	9.8 12.7 8.8	9.0 12.0 8.0						Remove Remove	1 2 1
3069	Black cherry Black cherry	Prunus serotina Prunus serotina Prunus serotina	8.6 9.0	8.0 9.0						Remove Remove	1 1
3072	Apple Black walnut	Malus spp. Juglans nigra	8.9 11.0	8.0						Remove Remove	1
3074	Box elder  Box elder  Apple	Acer negundo Acer negundo Malus spp.	9.0 12.0	9.0 12.0	15.5 11.0	14.8			Multiple  Double	Remove Remove	6 1 3
3076	Douglas fir Douglas fir	Pseudotsuga menziesii Pseudotsuga menziesii	12.0 11.9	12.0 11.0						Remove Remove	2 2
3079	Blue spruce White ash Box elder	Picea pungens Fraxinus americana Acer negundo	17.9 34.5 21.0	17.0 34.5 21.0						Remove Remove	2 4 3
3081	Norway spruce Norway spruce	Picea abies Picea abies	17.8 16.8	17.0 16.0						Remove Remove	2 2
3084	Eastern red cedar Norway spruce	Juniperus virginiana Picea abies	10.0	10.0						Remove Remove	1 2
	Norway spruce Weeping willow Black locust	Picea abies  Salix x sepulcralis  Robinia pseudoacacia	13.8 30.0 9.4	30.0 9.0	12.0				Double	Remove Remove	6 1
	Box elder Box elder	Acer negundo Acer negundo	9.0 11.3	9.0 11.0	9.3				Double	Remove Remove	1 3
3091	Black walnut Green ash	Acer negundo Juglans nigra	20.0 11.9 11.6	20.0 11.0 11.0	16.0				Double	Remove Remove	5 2 2
3093	Box elder Silver maple	Fraxinus pennsylvanica Acer negundo Acer saccharinum	12.3 15.1	12.0 15.0	11.5				Double	Remove Remove	2 4
	Silver maple	Acer saccharinum Acer saccharinum	27.0	27.0	16.4	9.3			Multiple	Remove Remove	3 6
	American elm  Black locust  American elm	Ulmus americana Robinia pseudoacacia Ulmus americana	9.5 9.3 9.6	9.0 9.0 9.0						Remove Remove	1 1 1
3100 3101	Black locust Black locust	Robinia pseudoacacia Robinia pseudoacacia	8.0 10.8	8.0 10.0	7.3				Double	Remove Remove	1 3
3103	American elm Silver maple	Robinia pseudoacacia Ulmus americana Acer saccharinum	9.3 28.0	9.0 28.0	25.0	23 0			Multiple	Remove Remove	2 1 3
	Silver maple	Acer saccharinum  Populus deltoides	10.9	10.0	8.8				Double Previous tag #1108	Remove Remove	3
3108	Green ash Black locust	Fraxinus pennsylvanica Robinia pseudoacacia Robinia pseudoacacia	9.3 8.5	9.0 8.0						Remove Remove	1 1 2
	Black locust Black locust Black locust	Robinia pseudoacacia Robinia pseudoacacia Robinia pseudoacacia	11.6 8.3 9.0	8.0 9.0						Remove Remove	1 1
3112 3113	Black locust Black locust	Robinia pseudoacacia Robinia pseudoacacia	10.3 11.8	10.0 11.0					**	Remove Remove	1 2
3115	Black locust Black locust Black locust	Robinia pseudoacacia Robinia pseudoacacia Robinia pseudoacacia	10.0 10.5 8.4	10.0 10.0 8.0					** <50% ISA Health & Condition Std. Factor	Remove Remove	1 1 1
3117	Black locust Black locust	Robinia pseudoacacia Robinia pseudoacacia	11.6 9.8	11.0 9.0					** <50% ISA Health & Condition Std. Factor	Remove Remove	2
3120	Black locust Black locust	Robinia pseudoacacia Robinia pseudoacacia	14.0 11.8	14.0 11.0						Remove Remove	2 2
3122	Black locust Black locust	Robinia pseudoacacia Robinia pseudoacacia Robinia pseudoacacia	13.0 8.3 9.8	8.0 9.0						Remove Remove	1 1
3124	Black locust Black locust	Robinia pseudoacacia Robinia pseudoacacia	9.8 9.4 12.0	9.0 9.0 12.0						Remove Remove	1 2
3127	Black locust Black locust	Robinia pseudoacacia Robinia pseudoacacia Robinia pseudoacacia	11.4 13.9	11.0 13.0						Remove Remove	2 2
3129	Black locust Black maple Black locust	Robinia pseudoacacia Acer nigrum Robinia pseudoacacia	10.3 8.8 17.5	8.0 17.0						Save Remove Remove	0 1 2
3131 3132	American elm Black locust	Ulmus americana Robinia pseudoacacia	11.6 10.5	11.0 10.0						Remove Remove	2
	Black locust Black locust	Robinia pseudoacacia Robinia pseudoacacia Robinia pseudoacacia	9.5 10.9 11.0	9.0 10.0 11.0						Remove Remove	1

	Black locust	Robinia pseudoacacia	9.6	9.0	0.5	7.5			Mulkinla	Remove	1
3137 3138	Black locust Black locust	Robinia pseudoacacia Robinia pseudoacacia	10.0 12.3	10.0	8.5	7.5			Multiple	Remove Remove	4 2
	Black locust  Eastern cottonwood	Robinia pseudoacacia Populus deltoides	10.0 13.3	10.0						Remove Remove	2
3141	Northern red oak	Quercus rubra	10.8	10.0						Remove	1
	Eastern cottonwood Eastern cottonwood	Populus deltoides Populus deltoides	23.0 19.0	23.0 19.0						Remove Remove	3 2
3144 3145	Black locust Black locust	Robinia pseudoacacia Robinia pseudoacacia	10.9 8.1	10.0 8.0						Remove Remove	1
	Black locust Black locust	Robinia pseudoacacia Robinia pseudoacacia	9.1 8.6	9.0 8.0						Remove Remove	1
3148	Blacklocust	Robinia pseudoacacia	9.0	9.0						Save	0
	Black locust Black locust	Robinia pseudoacacia Robinia pseudoacacia	8.3 8.8	8.0						Remove Remove	1
	Black locust Black locust	Robinia pseudoacacia Robinia pseudoacacia	8.1 11.1	8.0 11.0						Remove Remove	2
3153	Black locust	Robinia pseudoacacia	8.8	8.0						Remove	1
	American elm Black locust	Ulmus americana Robinia pseudoacacia	10.8 8.4	10.0 8.0						Remove Remove	1
	Northern red oak Black locust	Quercus rubra Robinia pseudoacacia	16.0 8.8	16.0 8.0						Remove Remove	<u>2</u> 1
3158	Scots pine	Pinus sylvestris	12.3	12.0						Remove	2
3159 3160	Northern red oak Red maple	Quercus rubra Acer rubrum	16.8 17.0	16.0 17.0	15.0				Double	Save Save	0
	Northern red oak Scots pine	Quercus rubra Pinus sylvestris	16.5 14.4	16.0 14.0						Save Save	0
3163	Northern red oak	Quercus rubra	10.0	10.0						Save	0
3164 <del>3165</del>	Black maple Eastern cottonwood	Acer nigrum  Populus deltoides	9.5 <del>14.3</del>	9.0 <del>14.0</del>						Save Offsite	0
3166 3167	Eastern cottonwood  Eastern cottonwood	Populus deltoides Populus deltoides	29.0 21.0	29.0 21.0						Offsite Offsite	0
3168	American basswood	<del>Tilia americana</del>	11.8	11.0						Offsite	0
<del>3169</del> 3170	Northern red oak Eastern cottonwood	<del>Quercus rubra</del> <del>Populus deltoides</del>	8.9 23.0	8.0 23.0	18.0				Double	Offsite Offsite	0
<del>3171</del> <del>3172</del>	American elm Northern red oak	Ulmus americana Quercus rubra	8.0 8.4	8.0 8.0						Offsite Offsite	0
<del>3173</del>	Black walnut	<del>Juglans nigra</del>	11.5	11.5						Offsite	0
3174 3175	Bigtooth aspen Bur oak	Populus grandidentata Quercus macrocarpa	9.1	9.0						Offsite Offsite	0
	Northern red oak Northern red oak	Quercus rubra Quercus rubra	18.0 21.4	18.0 21.0	13.5	8.7			Multiple	Offsite Offsite	0
3178	Northern red oak	Quercus rubra	<del>17.6</del>	17.0						Offsite	0
	Northern red oak Northern red oak	Quercus rubra Quercus rubra	11.5 13.9	11.0 13.0						Offsite Offsite	0
3181 3182	American elm Northern red oak	Ulmus americana Quercus rubra	9.3 10.5	9.0 10.0						Offsite Offsite	0
3183	Northern red oak	Quercus rubra	14.4	14.0						Offsite	0
	Northern red oak Eastern red cedar	<del>Quercus rubra</del> <del>Juniperus virginiana</del>	14.4 10.8	14.0 10.0						Offsite Offsite	0
	<del>Sugar maple</del> <del>Sugar maple</del>	Acer saccharum Acer saccharum	8.0 18.0	8.0 18.0						Offsite Offsite	0
3188	Red maple	Acer rubrum	11.3	11.0						Offsite	0
	Northern red oak Northern red oak	Quercus rubra Quercus rubra	14.5 12.3	14.0 12.0						Offsite Offsite	0
3191 3192	Northern red oak	Quercus rubra Quercus rubra	11.9 11.8	11.0 11.0						Offsite Offsite	0
3193	Northern red oak	Quercus rubra	16.1	16.0						Offsite	0
	Northern red oak Northern red oak	Quercus rubra  Quercus rubra	16.0 18.8	16.0 18.0						Offsite Offsite	0
	Northern red oak Northern red oak	Quercus rubra Quercus rubra	10.9 9.0	10.0 9.0	8.0				Double, Previous tag # 1299	Save Save	0
3198	Northern red oak	Quercus rubra	15.0	15.0	13.0				Double	Save	0
	Black maple Black maple	Acer nigrum Acer nigrum	10.6 13.3	10.0						Save Save	0
	Northern red oak Northern red oak	Quercus rubra Quercus rubra	9.8 11.9	9.0 11.0						Save Save	0
3203	Red maple	Acer rubrum	12.8	12.0						Save	0
	Northern red oak Northern red oak	Quercus rubra Quercus rubra	13.4 11.7	13.0 11.0						Save Save	0
	Northern red oak Northern red oak	Quercus rubra Quercus rubra	16.1 10.1	16.0 10.0						Save Save	0
3208	Northern red oak	Quercus rubra	10.9	10.0	7.3				Double	Save	0
	Northern red oak Northern red oak	Quercus rubra Quercus rubra	11.5 8.6	8.0						Save Save	0
	Northern red oak Northern red oak	Quercus rubra Quercus rubra	9.5 10.2	9.0						Save Save	0
3213	Northern red oak	Quercus rubra	14.5	14.0						Save	0
	Northern red oak Black walnut	Quercus rubra Juglans nigra	16.6 16.3	16.0 16.0					Previous tag # 1261	Save Save	0
	Northern red oak Northern red oak	Quercus rubra Quercus rubra	14.5 11.5	14.0						Save Save	0
3218	Northern red oak	Quercus rubra	16.4	16.0	9.3				Double	Save	0
	Northern red oak Northern red oak	Quercus rubra  Quercus rubra	8.8 9.4	9.0	9.4				Double	Remove Save	0
	Northern red oak Northern red oak	Quercus rubra Quercus rubra	12.3 13.0	12.0 13.0						Save Save	0
3223	Sugar maple	Acer saccharum	12.3	12.0						Save	0
	Northern red oak Northern red oak	Quercus rubra Quercus rubra	14.4 10.3	14.0	10.3	7.5			Multiple	Save Save	0
	Northern red oak Northern red oak	Quercus rubra Quercus rubra	8.4 12.8	8.0 12.0						Save Save	0
3228	Black walnut	Juglans nigra	12.1	12.0						Save	0
3230	Northern red oak Northern red oak	Quercus rubra Quercus rubra	9.0 12.8	9.0						Save Save	0
	Northern red oak Northern red oak	Quercus rubra Quercus rubra	10.4 8.6	10.0						Save Save	0
3233	Northern red oak	Quercus rubra	11.0	11.0						Save	0
	Northern red oak Northern red oak	Quercus rubra Quercus rubra	10.9 15.1	10.0						Save Save	0
	Northern red oak Northern red oak	Quercus rubra Quercus rubra	9.0 9.9	9.0						Save Save	0
3238	Northern red oak	Quercus rubra	8.1	8.0						Save	0
	Northern red oak Northern red oak	Quercus rubra Quercus rubra	9.9 12.8	9.0						Save Save	0
	Northern red oak Northern red oak	Quercus rubra Quercus rubra	8.4 10.3	8.0						Save Save	0
3243	Northern red oak	Quercus rubra	11.1	11.0						Save	0
3245	Northern red oak Northern red oak	Quercus rubra Quercus rubra	12.8 8.0	8.0						Save	0
	Northern red oak Northern red oak	Quercus rubra Quercus rubra	19.7 12.0	19.0 12.0						Save Save	0
3248	Northern red oak	Quercus rubra	17.2	17.0						Save	0
3250	Northern red oak Eastern cottonwood	Quercus rubra Populus deltoides	12.1 14.5	12.0						Save	0
	Black locust Black locust	Robinia pseudoacacia Robinia pseudoacacia	9.1 9.1	9.0 9.0						Remove Remove	1
3253	Black locust	Robinia pseudoacacia	8.1	8.0						Remove	1 2
	Northern red oak Black locust	Quercus rubra Robinia pseudoacacia	20.0 11.5	20.0						Remove Remove	2
	Northern red oak Black locust	Quercus rubra Robinia pseudoacacia	19.0 9.8	19.0 9.0						Remove Remove	2
3258	Black locust	Robinia pseudoacacia	9.1	9.0						Remove	1
	Northern red oak Northern red oak	Quercus rubra Quercus rubra	10.4 11.1	10.0						Save Save	0
	Northern red oak Northern red oak	Quercus rubra Quercus rubra	14.6 16.4	14.0 16.0						Save Save	0
3263	Northern red oak	Quercus rubra	9.8	9.0						Save	0
	Northern red oak Northern red oak	Quercus rubra Quercus rubra	11.4 11.0	11.0						Save Save	0
3266	Northern red oak Northern red oak	Quercus rubra Quercus rubra	10.5 11.0	10.0						Save Save	0
	Northern red oak	Quercus rubra	15.3	15.0						Remove	2
	Northern red oak	Quercus rubra	8.8	8.0	Ι .	1	Ι.	1		Remove	1


	White oak Northern red oak	Quercus alba Quercus rubra	38.0 16.3	38.0 16.0				Previous tag # 1221	Sav Rem		2
	Black locust Black locust	Robinia pseudoacacia Robinia pseudoacacia	8.8 11.4	8.0 11.0				Previous tag#1202	Rem Rem		1 2
3275	Northern red oak Black locust	Quercus rubra Robinia pseudoacacia	20.0	20.0					Rem Rem	ove	2 1
3278	Black locust Black locust	Robinia pseudoacacia Robinia pseudoacacia	10.5 9.8	9.0					Rem	ove	1
3280	Black locust Black locust	Robinia pseudoacacia Robinia pseudoacacia	15.9 10.5	15.0 10.0	11.8			Double, Previous tag # 1201	Rem Rem	ove	1
3282	Northern red oak  Northern red oak  American basswood	Quercus rubra  Quercus rubra  Tilia americana	15.5 8.4 14.1	15.0 8.0 14.0				Previous tag#1190	Remo	ove	2 1 0
3284	Sugar maple  Northern red oak	Acer saccharum  Quercus rubra	14.1 14.1 20.3	14.0 14.0 20.0				Previous tag # 1190 Previous tag # 1191	Sav Sav Rem	re e	0 3
3286	Black walnut Eastern red cedar	Juglans nigra Juniperus virginiana	20.3 16.5 8.8	16.0 8.0					Rem	ove	2
3288	American elm Northern red oak	Ulmus americana Quercus rubra	9.9 15.3	9.0 15.0	13.0			Double	Rem	ove	1 4
	Northern red oak Northern red oak	Quercus rubra Quercus rubra	14.9 15.5	14.0 15.0					Rem Rem		2
3293	Northern red oak Northern red oak	Quercus rubra Quercus rubra	29.0 10.3	13.0 10.0					Rem Rem		3
3295	Northern red oak Northern red oak	Quercus rubra Quercus rubra	11.8 15.5	11.0 15.0					Sav	re e	0
3297	Northern red oak  Northern red oak	Quercus rubra Quercus rubra	17.1 15.8	17.0 15.0					Sav Sav	re e	0 0
3299	Northern red oak  Northern red oak  White oak	Quercus rubra  Quercus rubra  Quercus alba	11.5 15.1 19.1	11.0 15.0 19.0					Sav Sav	re e	0
3301	Northern red oak	Quercus rubra Tilia americana	15.6 9.6	15.0 9.0	14.8			Double	Rem	ove	4
3303	Black walnut American elm	Juglans nigra Ulmus americana	16.8	16.0					Rem	ove	2
	Black walnut Black walnut	Juglans nigra Juglans nigra	14.8 12.8	14.0 12.0					Rem Rem		2
	Black walnut Shagbark hickory	Juglans nigra Carya ovata	10.5 11.3	10.0 11.0					Rem Rem		2
3310	Black locust American basswood		9.9	9.0					Rem	ove	1
3312	Northern red oak Northern red oak	Quercus rubra Quercus rubra	20.3	10.0					Sav	re e	0
3314	White oak  American basswood  American elm	Quercus alba Tilia americana Ulmus americana	13.8 11.3 10.3	13.0 11.0 10.0				** Significant disease in lower bole	Rem	ove	0 2 1
3316	Black locust Black locust	Robinia pseudoacacia Robinia pseudoacacia	9.0	9.0					Rem	ove	1 1
3318	Black locust Black locust	Robinia pseudoacacia Robinia pseudoacacia	11.1	11.0					Rem	ove	2
3320	Black locust	Robinia pseudoacacia Robinia pseudoacacia	8.3 8.0	8.0					Rem	ove	1
3322	Black locust Black locust	Robinia pseudoacacia Robinia pseudoacacia	11.5 12.3	11.0 12.0					Rem Rem	ove	2
3325	Black locust Black locust	Robinia pseudoacacia Robinia pseudoacacia	10.8 11.0	10.0 11.0					Rem	ove	1
3327	Black locust Black locust	Robinia pseudoacacia Robinia pseudoacacia	8.3 17.0	8.0 17.0	13.3	13.0		Multiple	Rem Rem	ove	6
3329	Black locust  Black locust	Robinia pseudoacacia Robinia pseudoacacia	9.3 11.0	9.0					Remo	ove	1 1 1
3331	Black locust Black locust	Robinia pseudoacacia Robinia pseudoacacia Robinia pseudoacacia	9.5 14.0 8.8	9.0 14.0 8.0					Rem Rem	ove	1 2 1
3333	Black locust Black locust	Robinia pseudoacacia Robinia pseudoacacia	13.3 9.4	13.0 9.0					Rem	ove	2
3335	Black locust Black locust	Robinia pseudoacacia Robinia pseudoacacia	12.0 12.0	12.0 12.0				** Lareg scar on lowest 6' of bole, Prev. ta		ove	2 2
3337	Black locust Black locust	Robinia pseudoacacia Robinia pseudoacacia	8.4 8.0	8.0					Rem	ove	1 1
3340	Black locust Black locust	Robinia pseudoacacia Robinia pseudoacacia	8.2 9.5	8.0 9.0					Rem Rem	ove	1
3342	Black locust Black locust	Robinia pseudoacacia Robinia pseudoacacia	9.8	9.0					Sav	re e	0
3344	Black locust Black locust	Robinia pseudoacacia Robinia pseudoacacia	9.3 8.9	9.0					Sav Sav	re e	0
3346	Pignut hickory  Black locust  Black locust	Robinia pseudoacacia Robinia pseudoacacia	8.3 12.0 12.7	8.0 12.0 12.0					Sav Rem	ove	2 2
3348		Populus deltoides Robinia pseudoacacia	11.9 8.8	11.0 8.0				Previous tag #1109	Rem	ove	2
3350	White oak Black locust	Quercus alba Robinia pseudoacacia	12.5 9.1	12.0 9.0					Rem	ove	2
3353	Northern red oak Pignut hickory	Quercus rubra Carya glabra	11.5 13.1	11.0 13.0					Rem Rem	ove ove	2
3355	Black locust White oak	Robinia pseudoacacia Quercus alba	12.9 15.3	12.0 15.0					Sav Rem	ove	0 2
3357	Black locust Black locust	Robinia pseudoacacia Robinia pseudoacacia	8.5 9.4	9.0					Rem	ove	1 1
3359	White oak	Quercus rubra Quercus alba	9.8	9.0	8.4			Double	Remo	ove	3 3
3361	White oak White oak White oak	Quercus alba  Quercus alba  Quercus alba	9.6 12.0 12.4	9.0 12.0 12.0	8.9			Double	Rem Rem	ove	2 2
3363	White oak White oak	Quercus alba Quercus alba	8.9 16.0	8.0 16.0					Rem	ove	1 2
3365	White oak White oak	Quercus alba Quercus alba	11.0 14.1	11.0 14.0					Rem	ove	1 2
3367	White oak White oak	Quercus alba Quercus alba	10.0	10.0					Rem	ove	1 2
3370	White oak White oak	Quercus alba Quercus alba	16.1 23.0	16.0 23.0					Rem Rem	ove	2
3372	White oak	Quercus alba Quercus alba	11.6 12.4	11.0 12.0					Rem	ove	2
3374	American elm White oak	Ulmus americana Quercus alba	8.1 14.3	8.0 14.0					Rem	ove	2
3376	White oak White oak	Quercus alba Quercus alba	9.1 12.6	9.0 12.0 10.0					Remo	ove	1 2 1
3378	American elm  Box elder  Box elder	Ulmus americana Acer negundo Acer negundo	10.1 11.2 9.0	10.0 11.0 9.0					Rem	ove	2
3380	Eastern cottonwood Bur oak	-	17.5 8.4	17.0 8.0					Rem	ove	2
3382	Eastern cottonwood White oak	Populus deltoides Quercus alba	23.0 15.6	23.0 15.0					Rem	ove	3 2
3384	White oak Bur oak	Quercus alba Quercus macrocarpa	11.5 8.0	11.0 8.0					Rem Rem	ove	2
	American elm White oak	Ulmus americana Quercus alba	8.0 8.4	8.0 8.0					Rem Rem		1 1
3389	White oak White oak	Quercus alba Quercus alba	18.2 16.1	18.0					Sav Sav	re e	0
3391	White oak White oak	Quercus alba Quercus alba	14.0	14.0					Sav Rem	ove	2
3393	White oak White oak	Quercus alba Quercus alba	20.0 13.0	20.0 13.0				Dravious to - 44.045	Sav	re e	0
3395	White oak White oak	Quercus alba Quercus alba	21.5	21.5				Previous tag #1015	Sav Sav	re e	0
3397	Northern red oak  Northern red oak  White oak	Quercus rubra  Quercus rubra	22.5 40.0 25.0	22.5 40.0					Sav Sav	re e	0
3399	White oak American elm American elm	Ulmus americana Ulmus americana	25.0 11.7 13.9	25.0 11.0 13.0	11.0			Double	Sav Sav Sav	re e	0 0
3401	White oak Douglas fir	Quercus alba Pseudotsuga menziesii	13.9 17.2 14.1	13.0 17.0 14.0					Sav Sav	re e	0
3403	Douglas fir Hawthorn	Pseudotsuga menziesii Crataegus spp.	14.1	14.0 14.0	7.4			Double	Sav	re e	0
3405	Sweet cherry Sweet cherry	Prunus avium Prunus avium	16.1	16.0					Sav		0

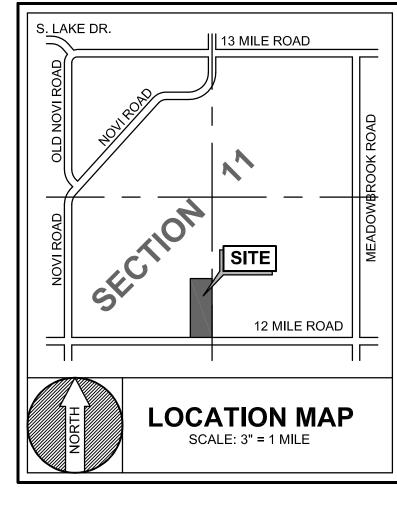

Removed Tree D.B.H. (In Inches)	Ratio Replacement/Removed Tr
8<11	1
>11<20	2
>20<29	3
>30	4
Multiple Stem Trees	<u> </u>
otal of all stems diameter (in inches)	


divided by 8 rounded to the next full number.


SANOISIAN TAMINE

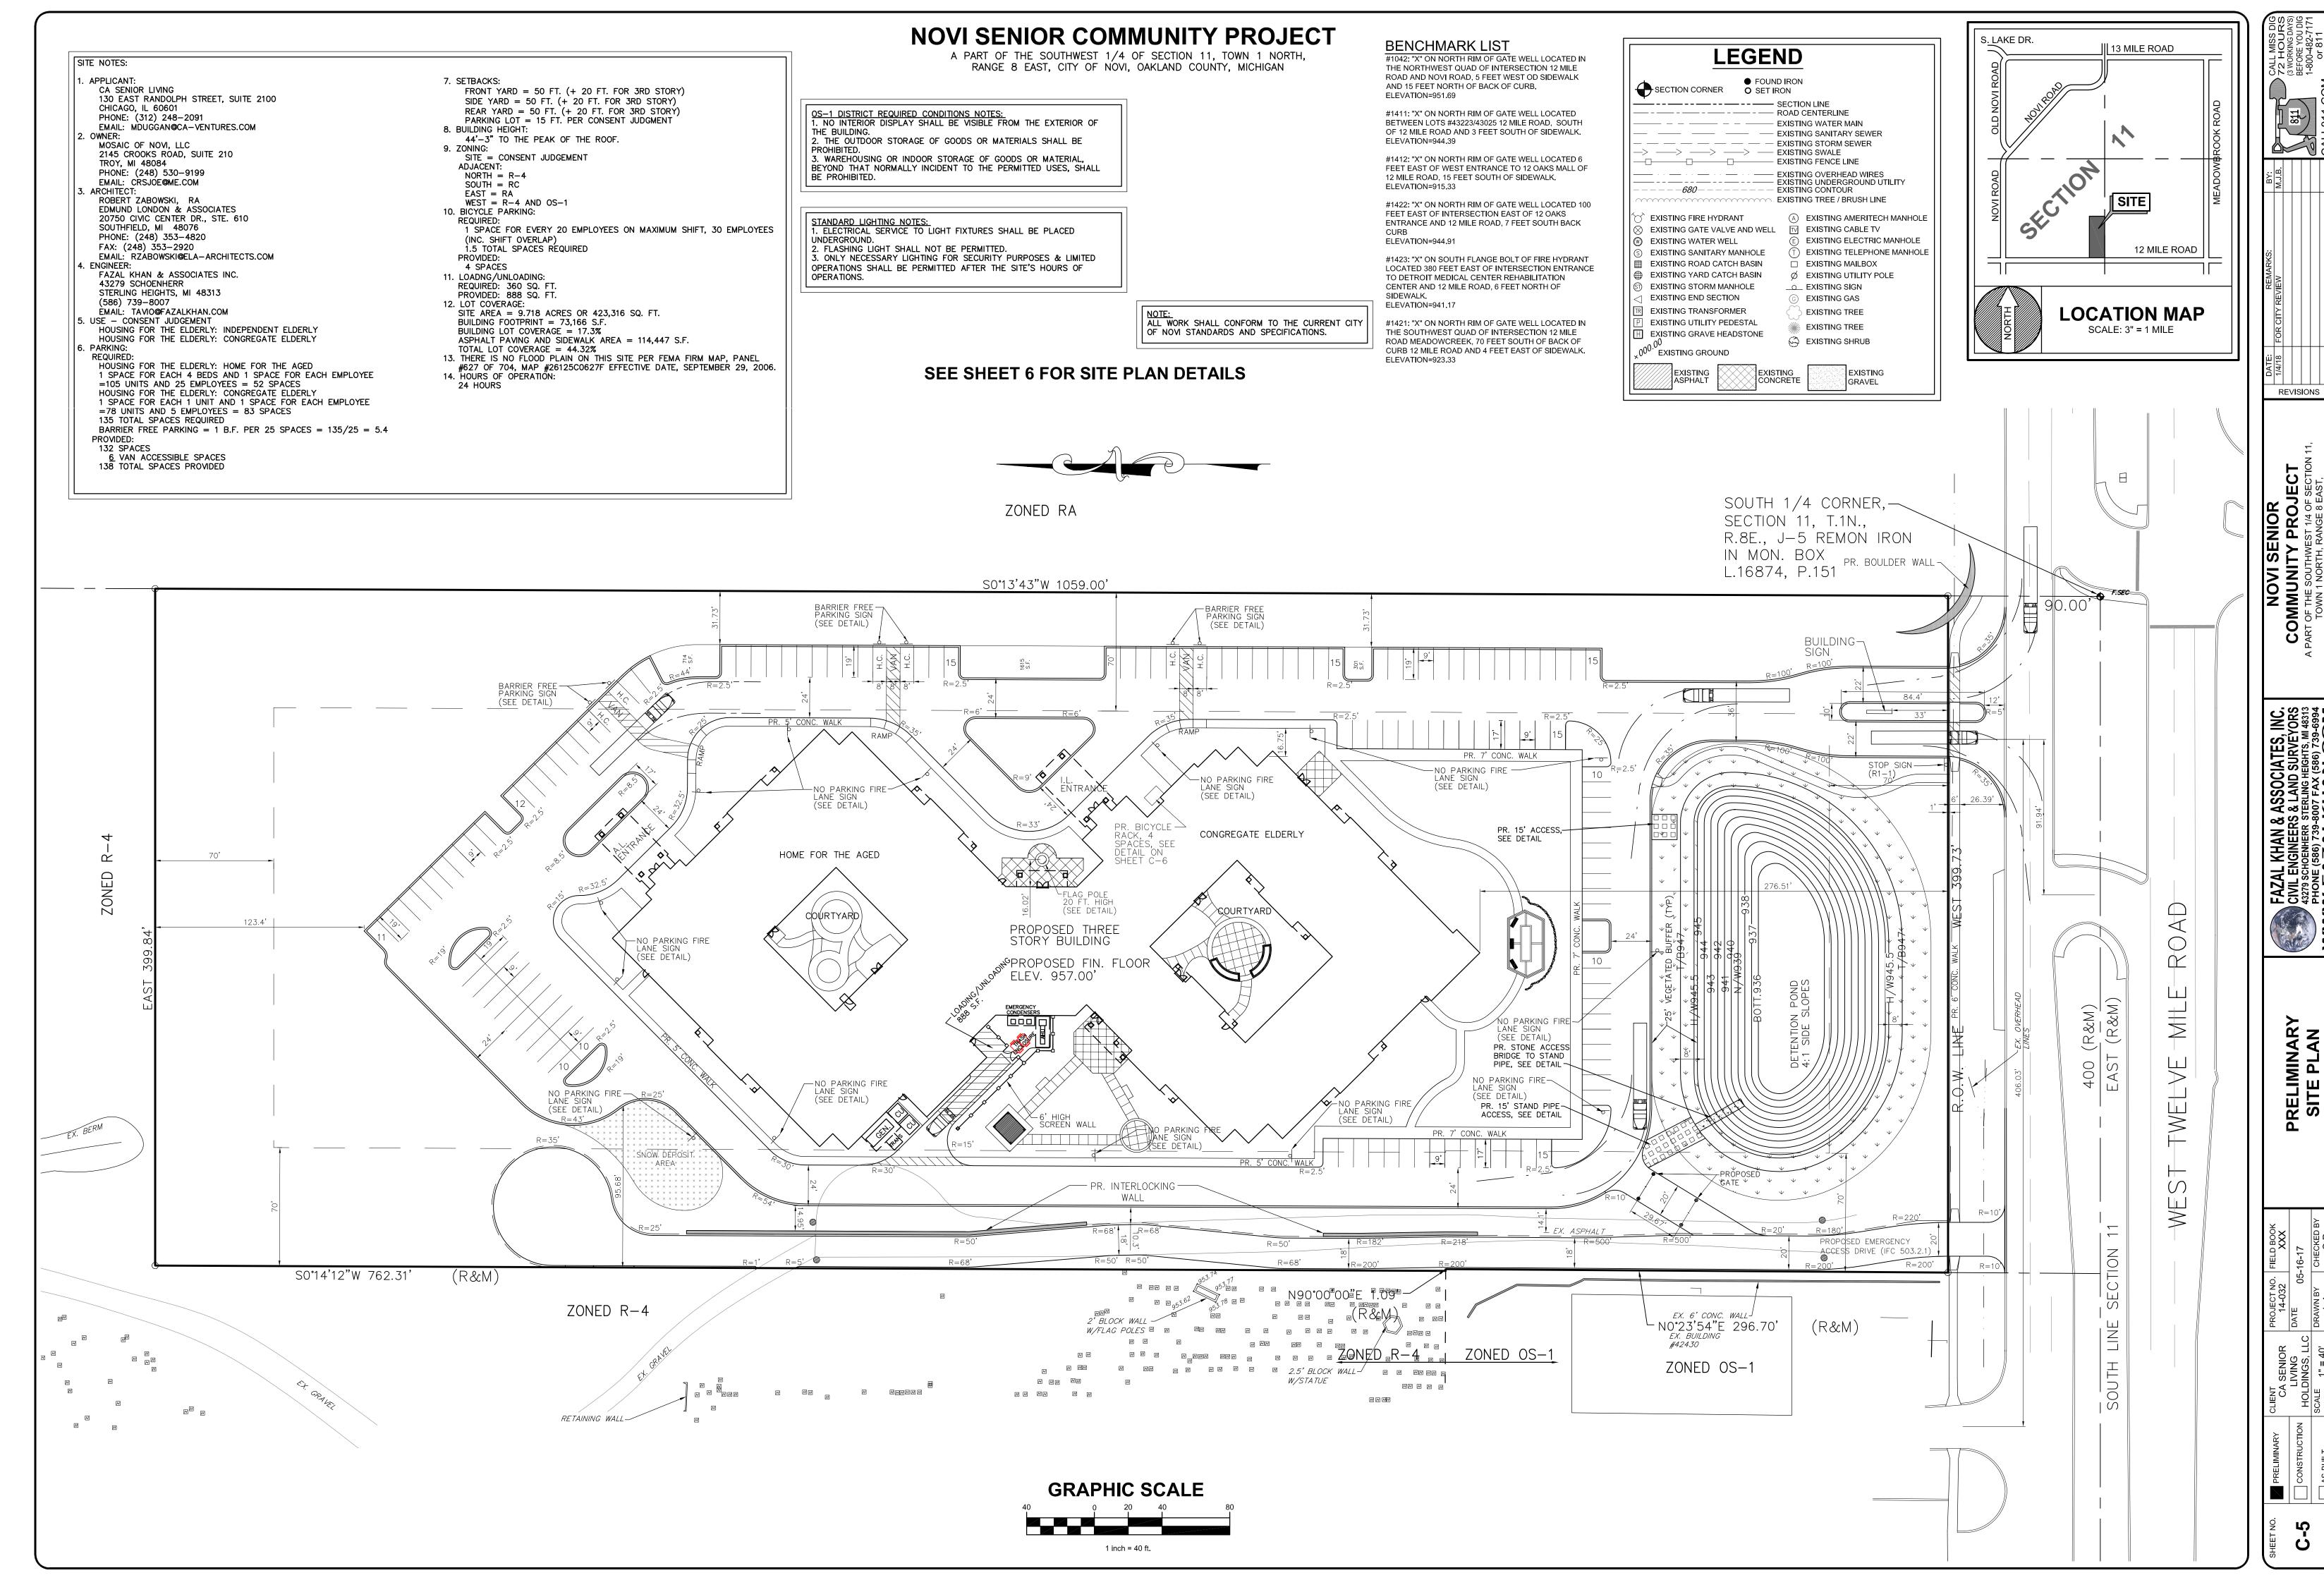


### **NOVI SENIOR COMMUNITY PROJECT**

A PART OF THE SOUTHWEST 1/4 OF SECTION 11, TOWN 1 NORTH, RANGE 8 EAST, CITY OF NOVI, OAKLAND COUNTY, MICHIGAN

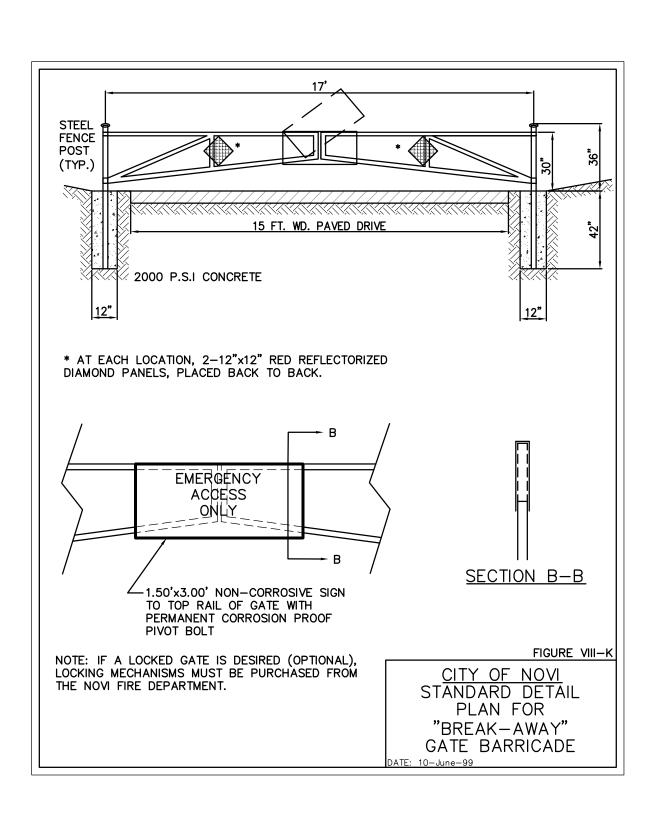

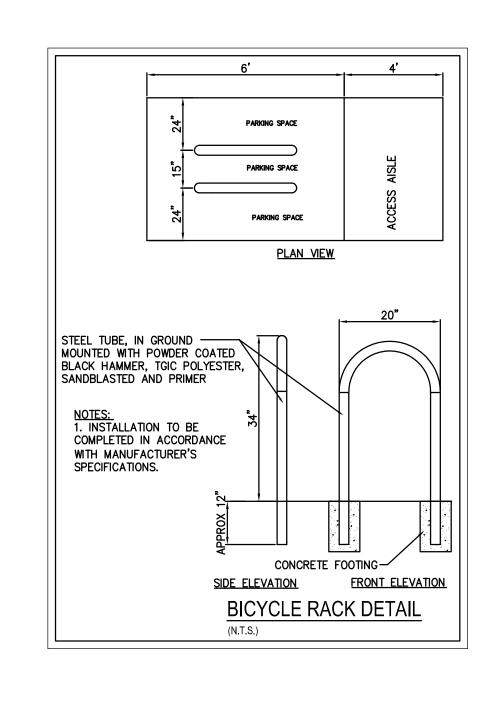

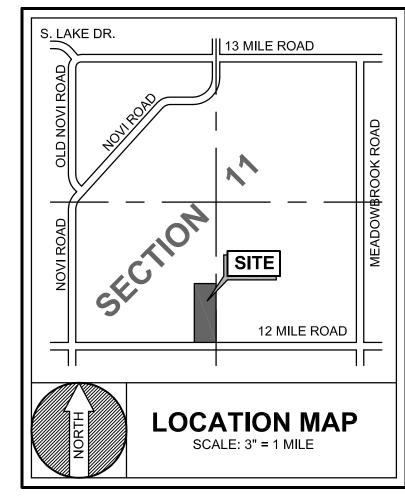



COMMUNITY PROJE

REVISIONS

PRELIMINARY SIT PLAN DETAILS

9

ALIGNED IN DIRECTION OF TRAVEL AND PERPENDICULAR (OR RADIAL) TO GRADE BREAK 4 4 4 6 9 9 DOME SECTION DOME SPACING DOME ALIGNMENT : SIDEWALK: NEAREST EDGE WITHIN 8" AND FURTHEST EDGE WITHIN 5' DF GRADE BREAK ON THE RAMP. DETECTABLE WARNING DETAILS

DETAILS SPECIFIED ON THIS PLAN APPLY TO ALL CONSTRUCTION, RECONSTRUCTION, OR ALTERATION OF STREETS, CURBS, OR SIDEWALKS BY ALL PUBLIC AGENCIES AND BY ALL PRIVATE DRGANIZATIONS CONSTRUCTING FACILITIES FOR PUBLIC USE. SIDEWALK RAMPS ARE TO BE LOCATED AS SPECIFIED ON THE PLANS OR AS DIRECTED BY THE ENGINEER. RAMPS SHALL BE PROVIDED AT ALL CORNERS OF AN INTERSECTION WHERE THERE IS EXISTING OR PROPOSED SIDEWALK AND CURB. RAMPS SHALL ALSO BE PROVIDED AT WALK LOCATIONS IN MID-BLOCK IN THE VICINITIES OF HOSPITALS, MEDICAL CENTERS, AND LARGE ATHLETIC FACILITIES. SURFACE TEXTURE OF THE RAMP SHALL BE THAT OBTAINED BY A COARSE BROOMING. TRANSVERSE TO THE SLOPE OF RAMP. SIDEWALK SHALL BE RAMPED WHERE THE DRIVEWAY CURB IS EXTENDED ACROSS THE WALK. CARE SHALL BE TAKEN TO ASSURE A UNIFORM GRADE ON THE RAMP, FREE OF SAGS AND SHORT GRADE CHANGES. WHERE CONDITIONS PERMIT, IT IS DESIRABLE THAT THE SLOPE OF THE RAMP BE IN ONLY ONE DIRECTION, PARALLEL TO THE DIRECTION OF TRAVEL. RAMP WIDTH SHALL BE INCREASED, IF NECESSARY, TO ACCOMMODATE SIDEWALK SNOW REMOVAL EQUIPMENT NORMALLY USED BY THE MUNICIPALITY.

THE SLOPE OF THE GUTTER PAN SHALL BE TRANSITIONED TO A MAXIMUM OF 5% IN THE AREA OF THE CURB CUT OF THE SIDEWALK RAMP. MAINTAIN THE NORMAL GUTTER PAN SLOPE ACROSS THE DRAINAGE STRUCTURE INLETS. THE TOP OF THE JOINT FILLER FOR ALL RAMP TYPES SHALL BE FLUSH WITH THE ADJACENT CONCRETE.


SIDEWALK RAMP DETAILS  $\frac{\text{4-16-2007}}{\text{PLAN DATE}}$  R-28-F  $\frac{\text{SHEET}}{\text{6 OF 6}}$ 

IF POSSIBLE, DRAINAGE STRUCTURES SHOULD NOT BE PLACED IN LINE WITH RAMPS. EXCEPT WHERE EXISTING DRAINAGE STRUCTURES ARE BEING UTILIZED IN THE NEW CONSTRUCTION, LOCATION OF THE RAMP CROSSWALK AND STOP LINE MARKINGS, IF USED, SHALL BE SO LOCATED AS TO STOP TRAFFIC SHORT OF RAMP CROSSINGS. SPECIFIC DETAILS FOR MARKING APPLICATIONS ARE GIVEN IN THE "MICHIGAN MANUAL OF UNIFORM TRAFFIC CONTROL DEVICES". DETECTABLE WARNINGS SHALL EXTEND THE FULL WIDTH OF THE CURB RAMP. THEY SHALL BE LOCATED SO THAT THE NEAREST EDGE OF THE DETECTABLE WARNING IS WITHIN 8" AND THE FURTHEST EDGE WITHIN 5' OF THE GRADE BREAK ON THE RAMP. FLARED SIDES WITH A SLOPE OF 10% MAXIMUM, MEASURED ALONG THE CURB LINE, SHALL BE PROVIDED WHERE A CIRCULATION PATH CROSSES THE SIDEWALK RAMP. FLARED SIDES ARE NOT REQUIRED WHERE THE EDGES OF A SIDEWALK RAMP ARE PROTECTED BY LANDSCAPING OR OTHER BARRIERS TO TRAVEL BY WHEELCHAIR USERS OR PEDESTRIANS ACROSS THE EDGE OF THE SIDEWALK RAMP. MICHIGAN DEPARTMENT OF TRANSPORTATION BUREAU OF HIGHWAY DEVELOPMENT STANDARD PLAN FOR

2 BRONZE SWIVEL SNAPS WITH 1-9" CAST ALUMINUM CLEAT -ALUMINUM FLASH COLLAR -3000 PSI CONCRETE HARDWOOD WEDGES -DRY SAND, TIGHTLY TAMPED -AFTER ALIGNING POLE FOUNDATION SLEEVE- 16 GA. HOT DIPPED GALV. STEEL STEEL CENTERING WEDGES 1/4" STEEL BASE PLATE -1/4" STEEL SUPPORT PLATE-WELDED TO GROUNDING SPIKE ELEVATION VIEW NOTES:

1. INSTALLATION TO BE COMPLETED IN ACCORDANCE WITH MANUFACTURER'S SPECIFICATIONS. FLAG POLE DETAIL


4"-14 GAUGE SPUN ALUMINUM-BALL GOLD ANODIZED SINGLE SHEAVE TRUCK, CAST— ALUMINUM REVÓLVING, NON-FOULING TYPE 1 SET OF HALYARD, #10 POLY-

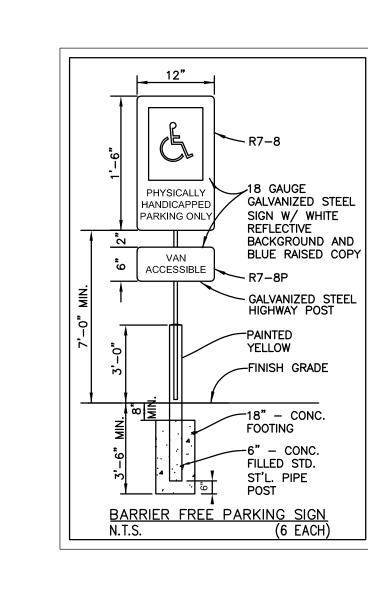


NOTE: ALL ONSITE SIGNING AND PAVEMENT MARKINGS


SHALL BE IN COMPLIANCE WITH THE MICHIGAN


MANUAL ON UNIFORM TRAFFIC CONTROL DEVICES.

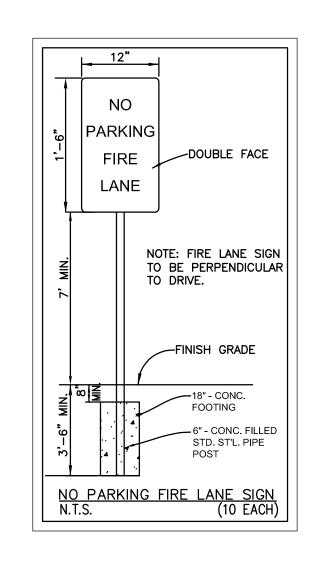


TRAFFIC CONTROL SIGN QUANTITIES "NO PARKING FIRE LANE" SIGN 14 EA. "BARRIER FREE PARKING" SIGN 6 EA. 1 EA. "STOP" SIGN

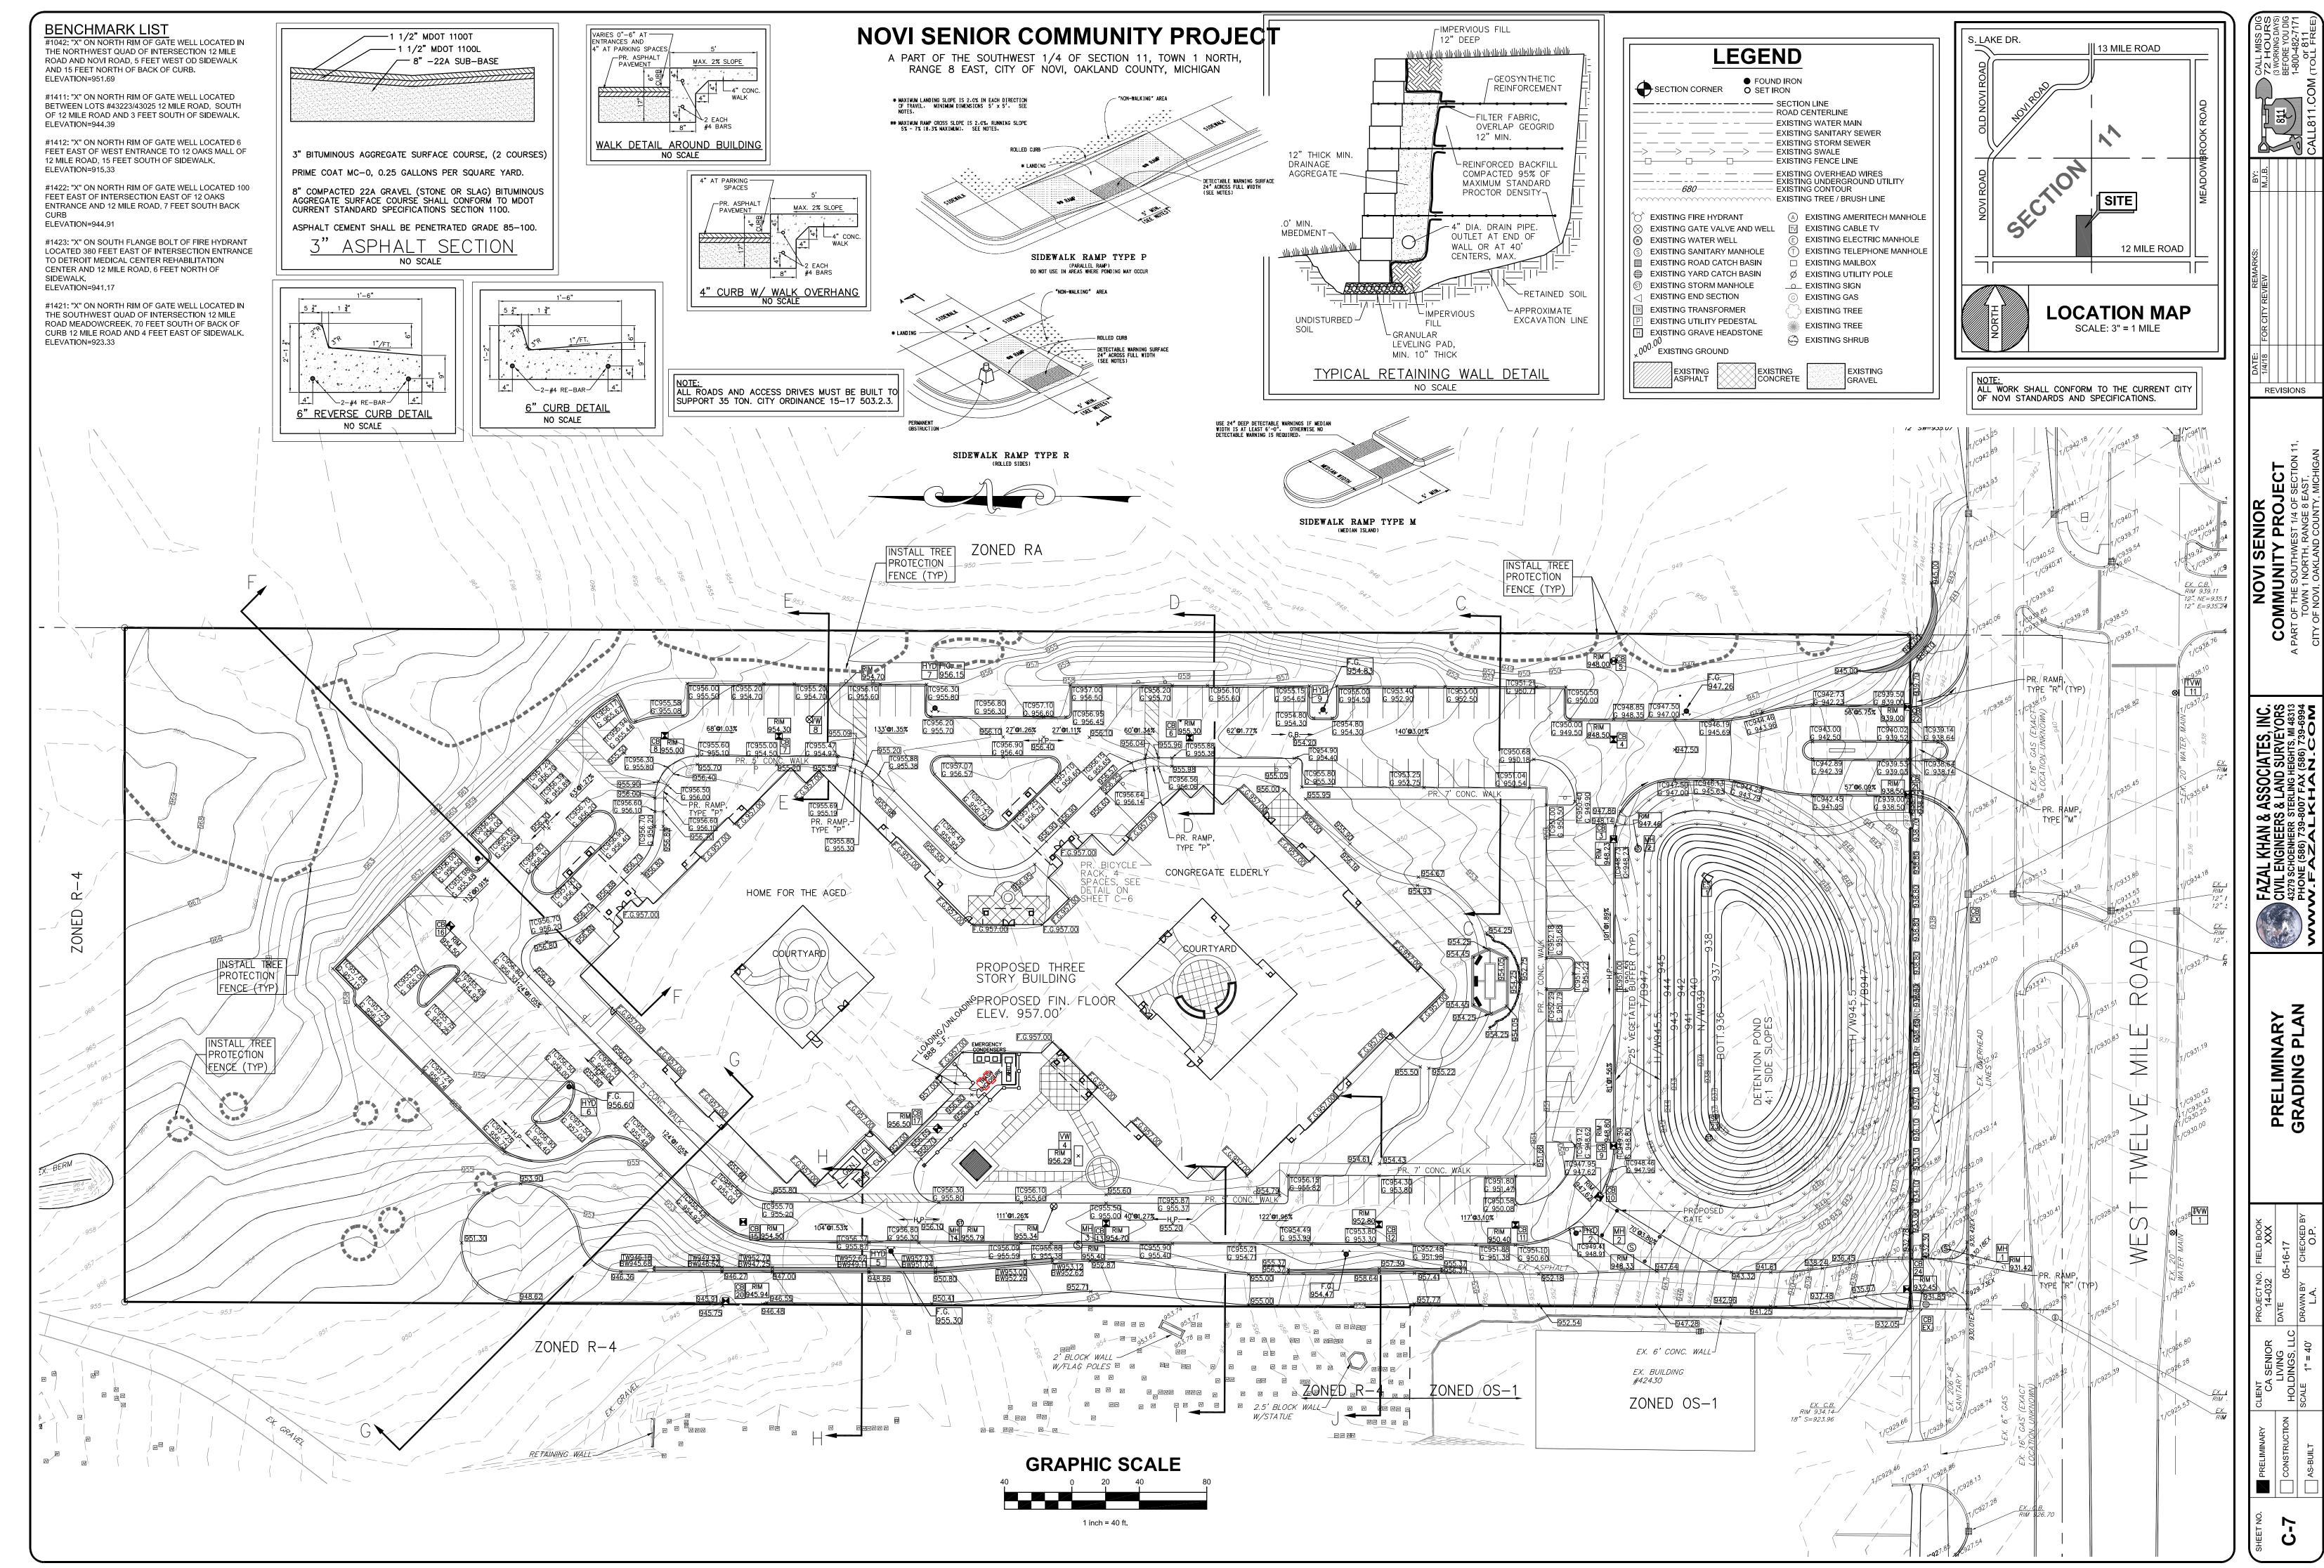

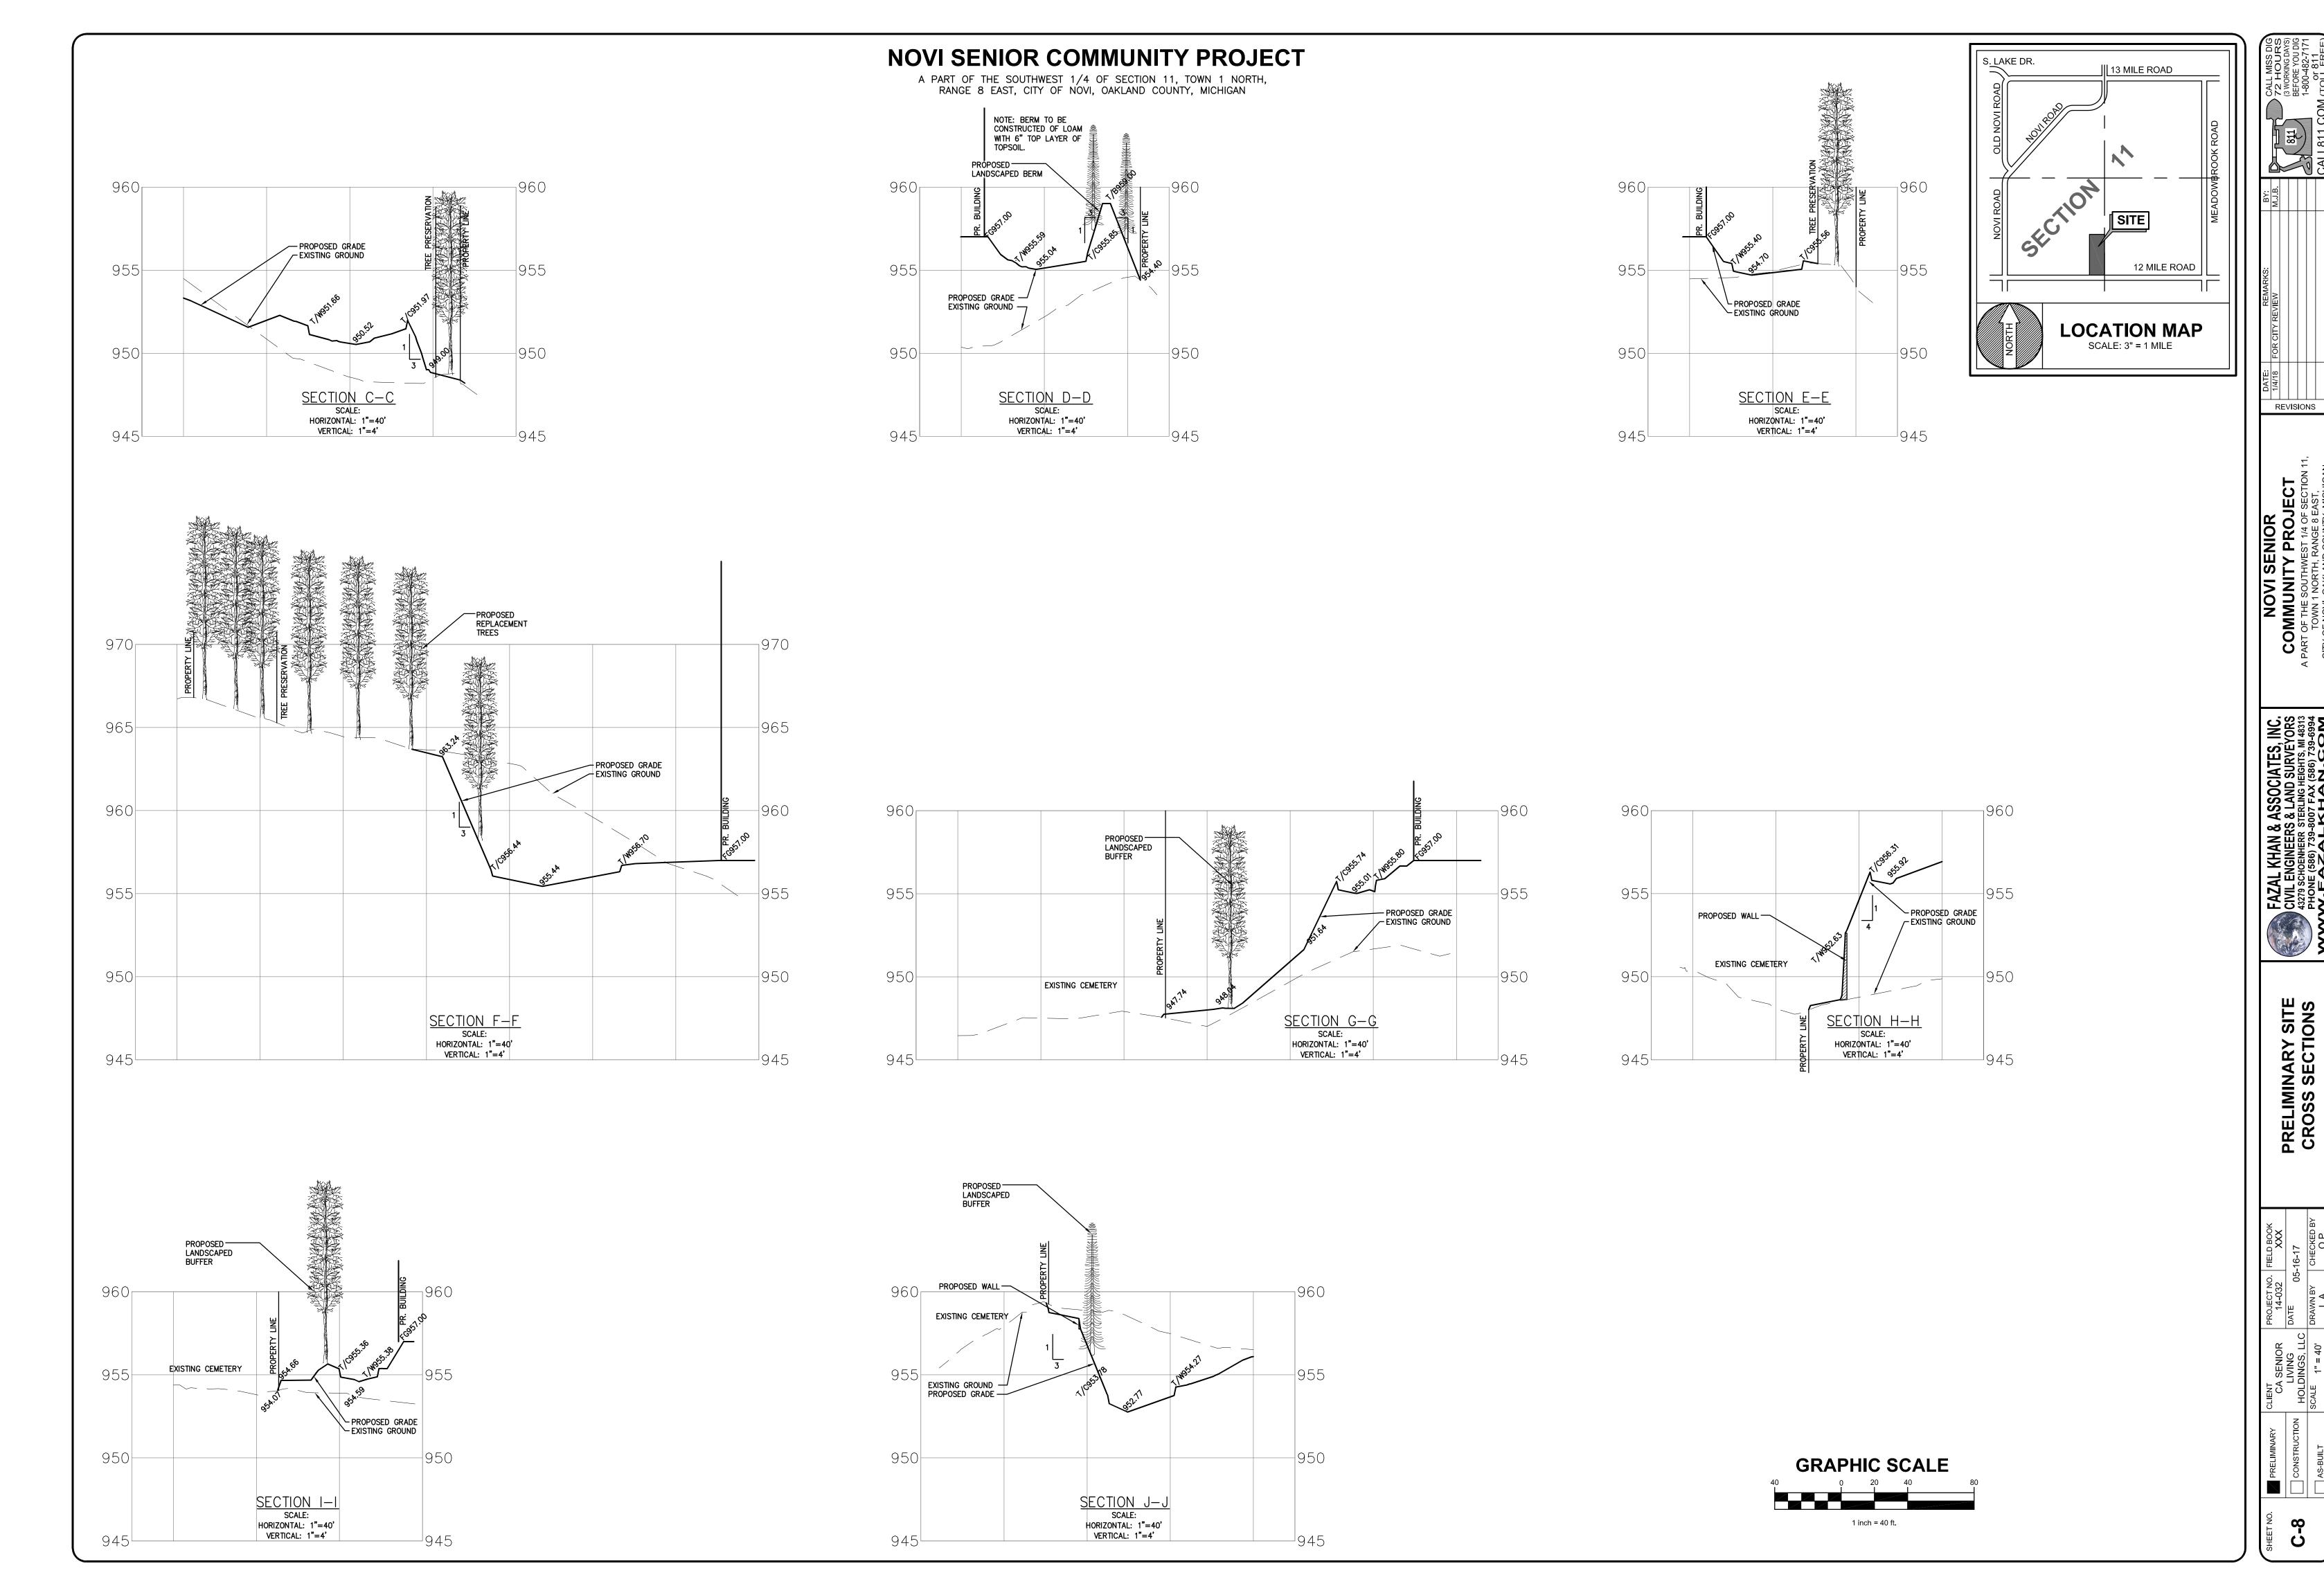

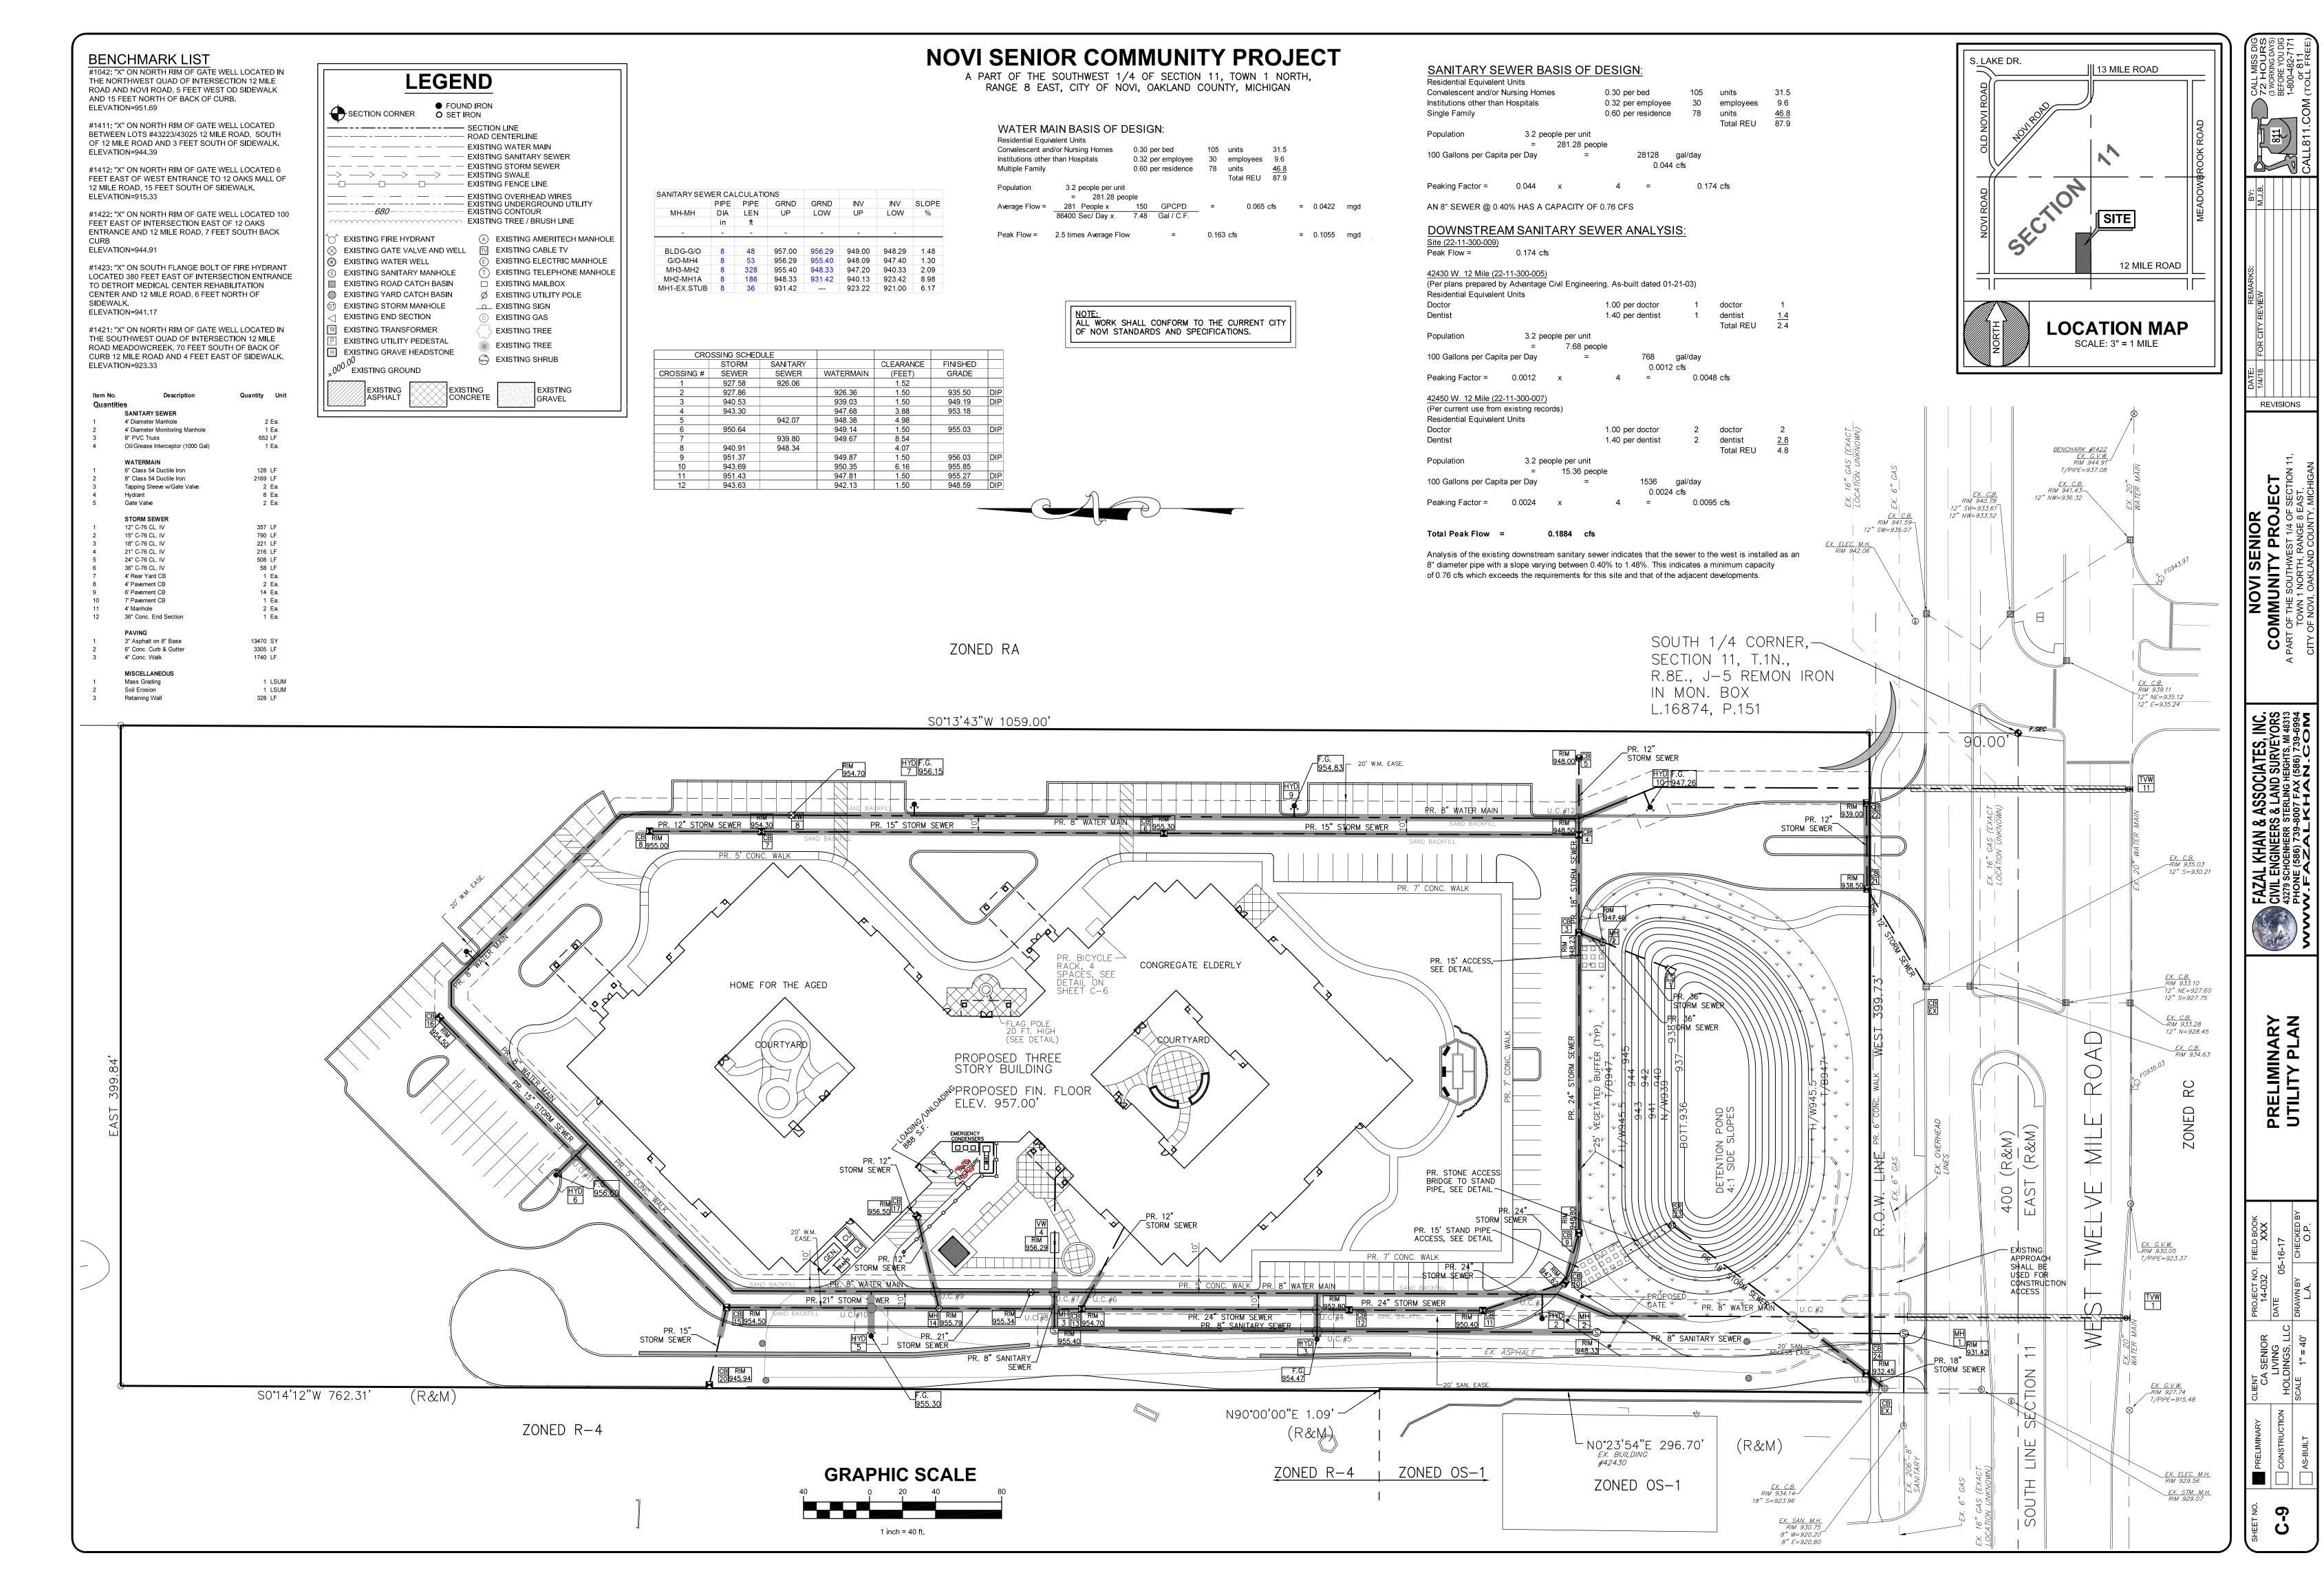

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HIGH WATER 945.50

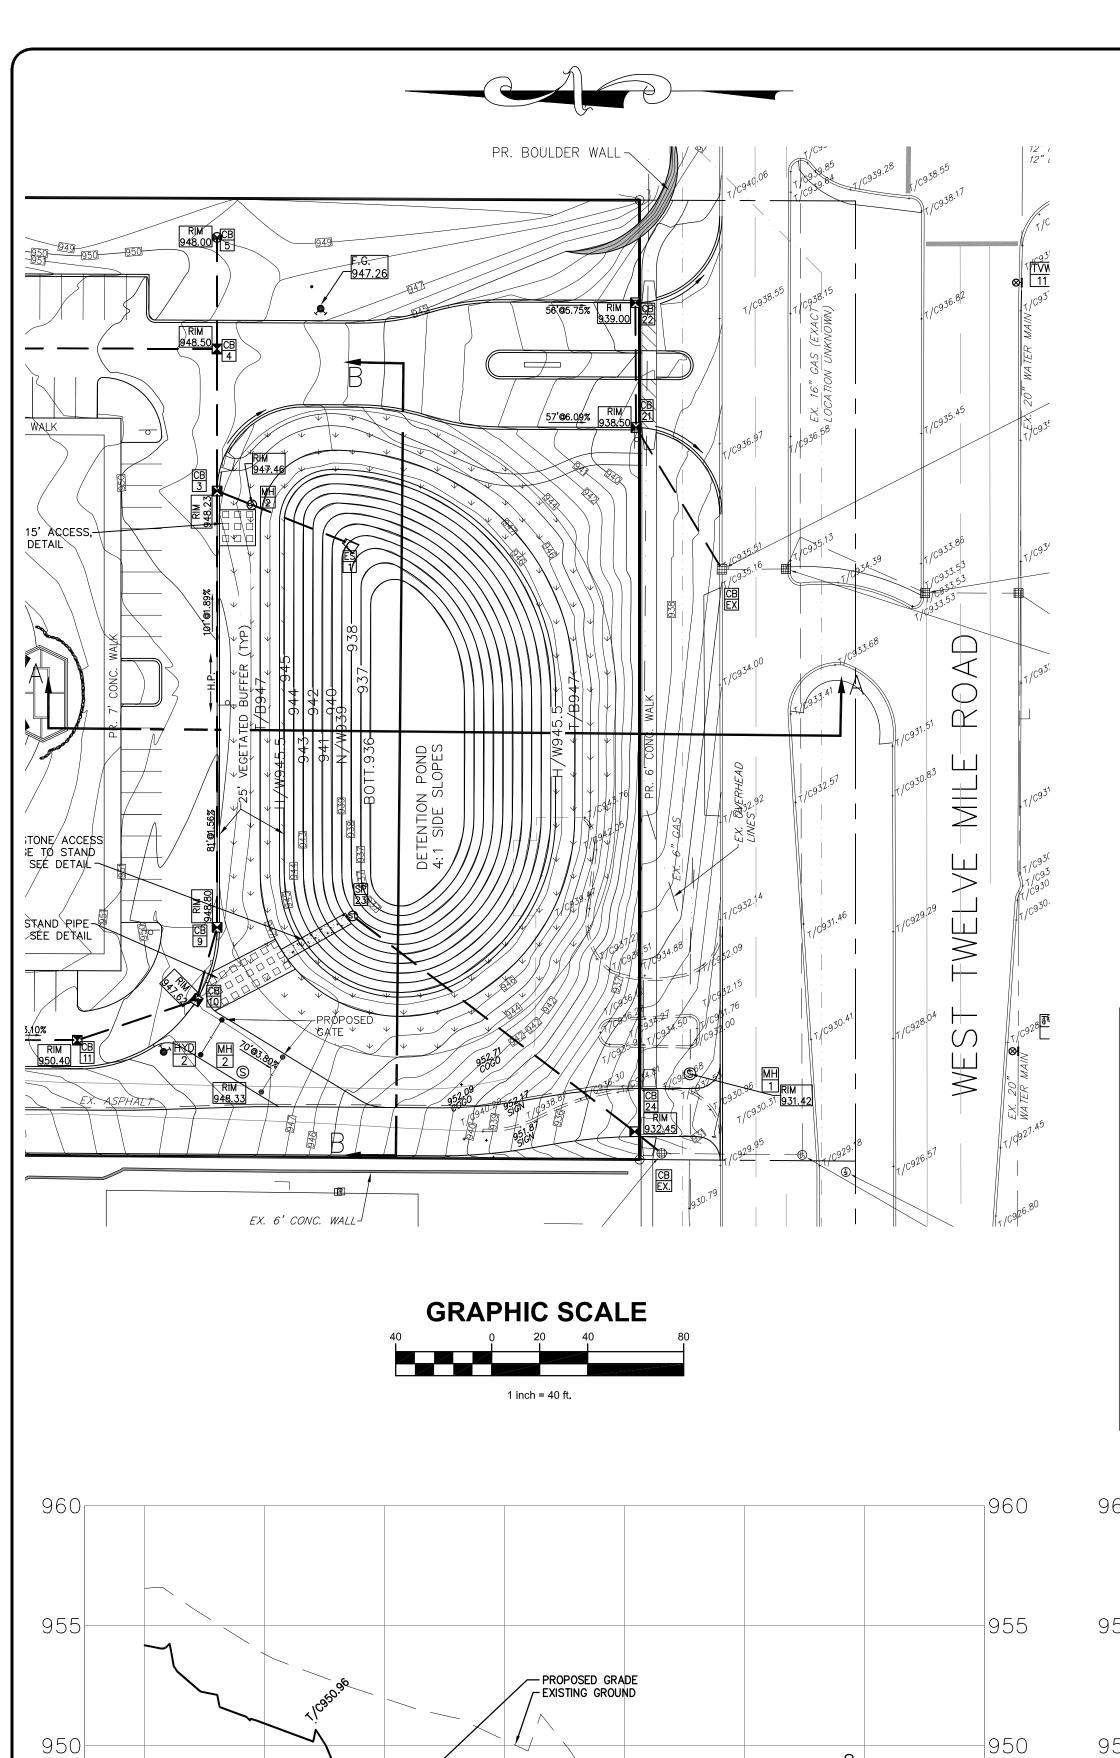NORMAL WATER 939.00

SECTION A-A


SCALE:


HORIZONTAL: 1"=40'


VERTICAL: 1"=4'

### **NOVI SENIOR COMMUNITY PROJECT**

A PART OF THE SOUTHWEST 1/4 OF SECTION 11, TOWN 1 NORTH, RANGE 8 EAST, CITY OF NOVI, OAKLAND COUNTY, MICHIGAN

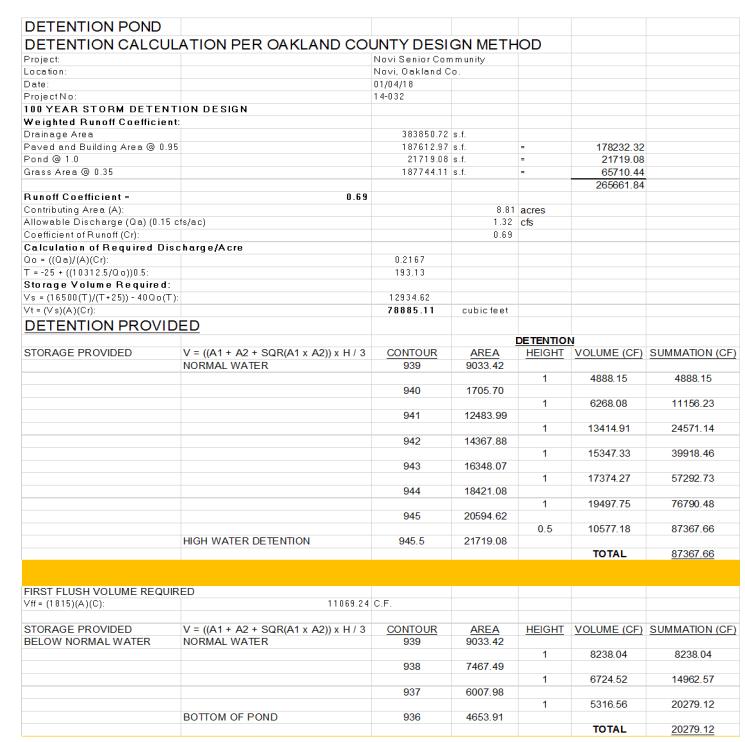

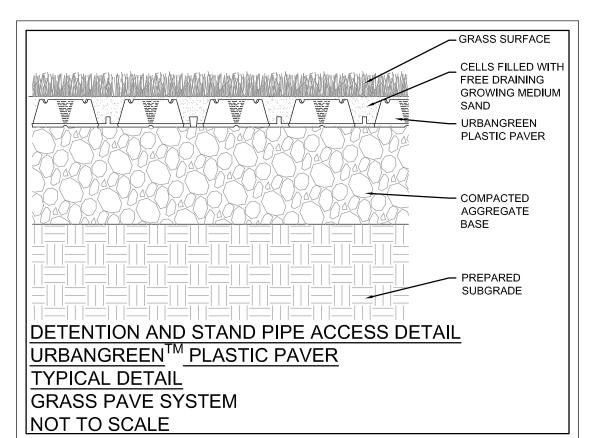

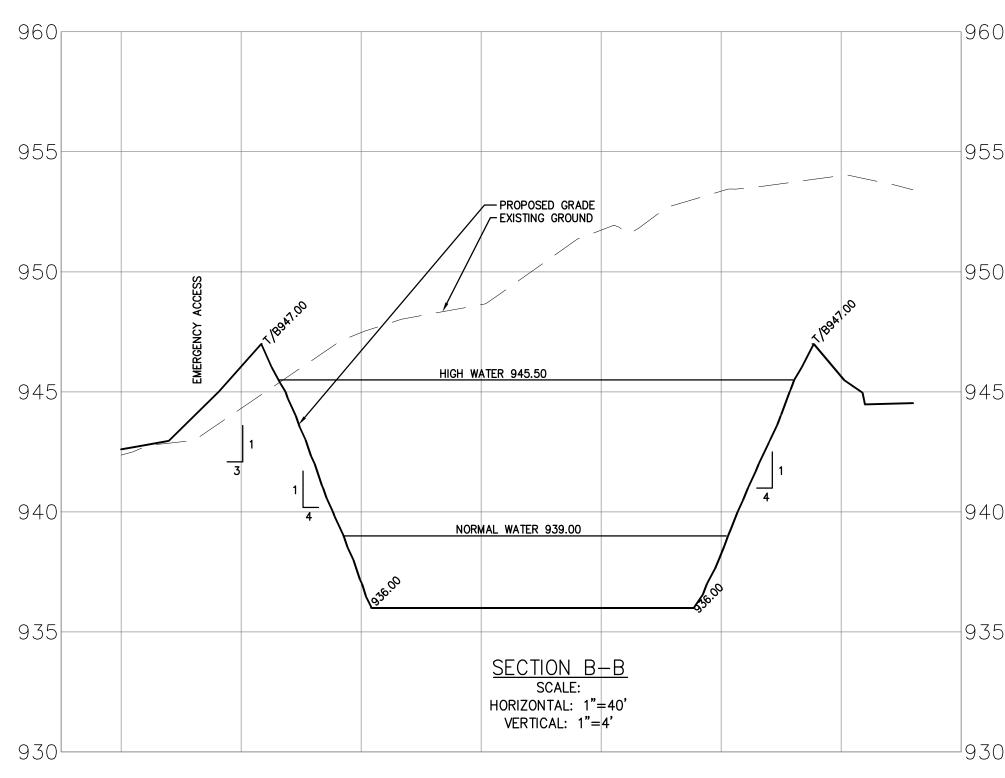

BENCHMARK LIST
#1042: "X" ON NORTH RIM OF GATE WELL LOCATED IN THE NORTHWEST QUAD OF INTERSECTION 12 MILE ROAD AND NOVI ROAD, 5 FEET WEST OD SIDEWALK AND 15 FEET NORTH OF BACK OF CURB. ELEVATION=951.69

#1411: "X" ON NORTH RIM OF GATE WELL LOCATED BETWEEN LOTS #43223/43025 12 MILE ROAD, SOUTH OF 12 MILE ROAD AND 3 FEET SOUTH OF SIDEWALK. ELEVATION=944.39

#1412: "X" ON NORTH RIM OF GATE WELL LOCATED 6 FEET EAST OF WEST ENTRANCE TO 12 OAKS MALL OF 12 MILE ROAD, 15 FEET SOUTH OF SIDEWALK. ELEVATION=915.33

#1422: "X" ON NORTH RIM OF GATE WELL LOCATED 100 FEET EAST OF INTERSECTION EAST OF 12 OAKS ENTRANCE AND 12 MILE ROAD, 7 FEET SOUTH BACK ELEVATION=944.91


#1423: "X" ON SOUTH FLANGE BOLT OF FIRE HYDRANT LOCATED 380 FEET EAST OF INTERSECTION ENTRANCE TO DETROIT MEDICAL CENTER REHABILITATION CENTER AND 12 MILE ROAD, 6 FEET NORTH OF SIDEWALK. ELEVATION=941.17


#1421: "X" ON NORTH RIM OF GATE WELL LOCATED IN THE SOUTHWEST QUAD OF INTERSECTION 12 MILE ROAD MEADOWCREEK, 70 FEET SOUTH OF BACK OF CURB 12 MILE ROAD AND 4 FEET EAST OF SIDEWALK. ELEVATION=923.33

LEGEND	S. LAKE DI
FOUND IRON O SET IRON SECTION CORNER O SET IRON SECTION LINE SEXISTING SANITARY SEWER SEXISTING SWALE SEXISTING OVERHEAD WIRES SECTION LINE SEXISTING OVERHEAD WIRES SEXISTING CONTOUR SEXISTING CONTOUR SEXISTING FIRE HYDRANT  EXISTING AMERITECH MANHOLE	NOVI ROAD OLD NOVI ROAD
<ul> <li>EXISTING GATE VALVE AND WELL</li> <li>EXISTING CABLE TV</li> <li>EXISTING WATER WELL</li> <li>EXISTING ELECTRIC MANHOLE</li> <li>EXISTING TELEPHONE MANHOLE</li> <li>EXISTING MAILBOX</li> <li>EXISTING YARD CATCH BASIN</li> <li>EXISTING WATER WELL</li> <li>EXISTING TELEPHONE MANHOLE</li> <li>EXISTING MAILBOX</li> <li>EXISTING UTILITY POLE</li> <li>EXISTING SIGN</li> <li>EXISTING GAS</li> <li>EXISTING TRANSFORMER</li> <li>EXISTING TREE</li> <li>EXISTING TREE</li> <li>EXISTING TREE</li> <li>EXISTING TREE</li> <li>EXISTING TREE</li> <li>EXISTING TREE</li> <li>EXISTING SHRUB</li> </ul>	NORTH



NOTE: THE STORM WATER MANAGEMENT SYSTEM SHALL BE MAINTAINED BY THE OWNER.

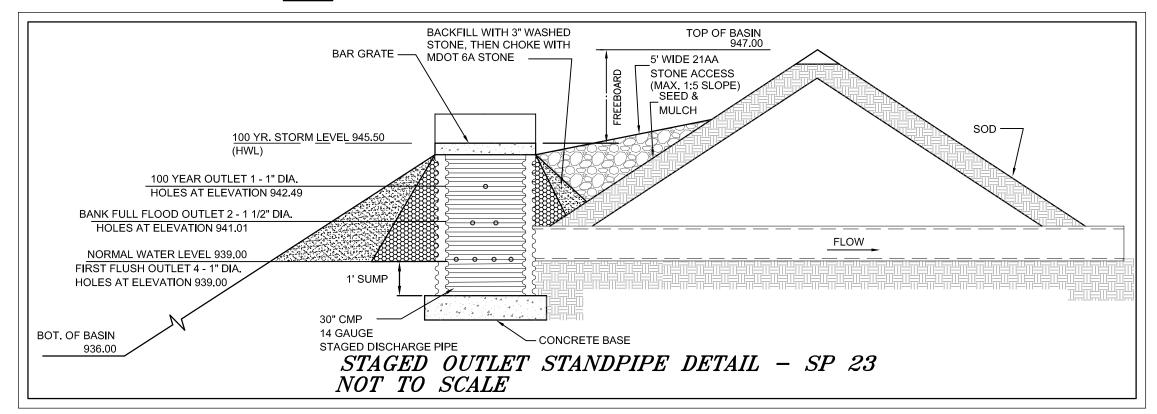

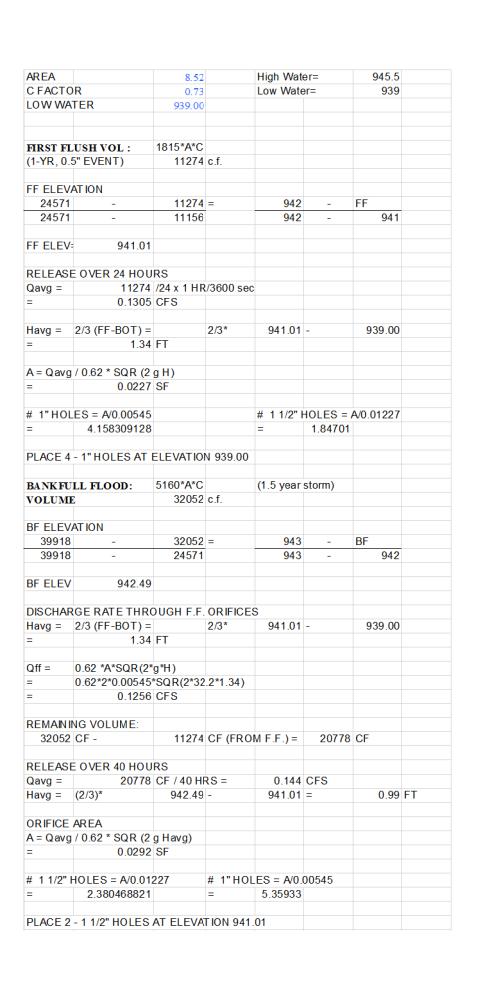


100-YEAI	R EVENT:	See Deter	ntion Calcu	ılations			
		80881.59	c.f.				
100 YEAF	RELEVATION						
87368	-	80881.6	=	945.5	-	100 YEAR	3
87368	-	76790		945.5	-	945	
400 \/ \( \)	) FI F\/	045.40					
100 YEAR	R ELEV =	945.19					
DISCHAR	RGE RATE THRO	DUGH FIRS	ST FLUSH	I AND BAN	NK FULL	ORIFICES	
				.,			
Qbf =	0.62 *A*SQR(2*	g*H)					
=	0.62*2*0.01227		.2*945.19	941.01)			
=	0.2498	CFS					
Qff =	0.62 *A*SQR(2*						
=	0.62*4*0.00545		.2*(945.19	9-939.00))			
=	0.2701	CFS					
	E OVER 40 HOU		D 151 40 114	21122			
	BLE OUTFLOW:				050		
Qall =	80881.58732			0.562 0.2701		0.0417	OFC
0.562	-	0.2498 (bf)	-		=	0.0417	CFS
Havg =	(2/3)*	945.19	_	(ff) 942.49	  -	1.80	FT
iavy -	(2/3)	343.13	_	374.43		1.00	1 1
ORIFICE	AREA						
	0.62 * SQR (2 g	Havg)					
=	0.006						
# 1 1/2" H	HOLES = A/0.01	227	# 1" HOL	ES = A/0.	00545		
	0.508961704		=	1.14586			
=							

REVISIONS


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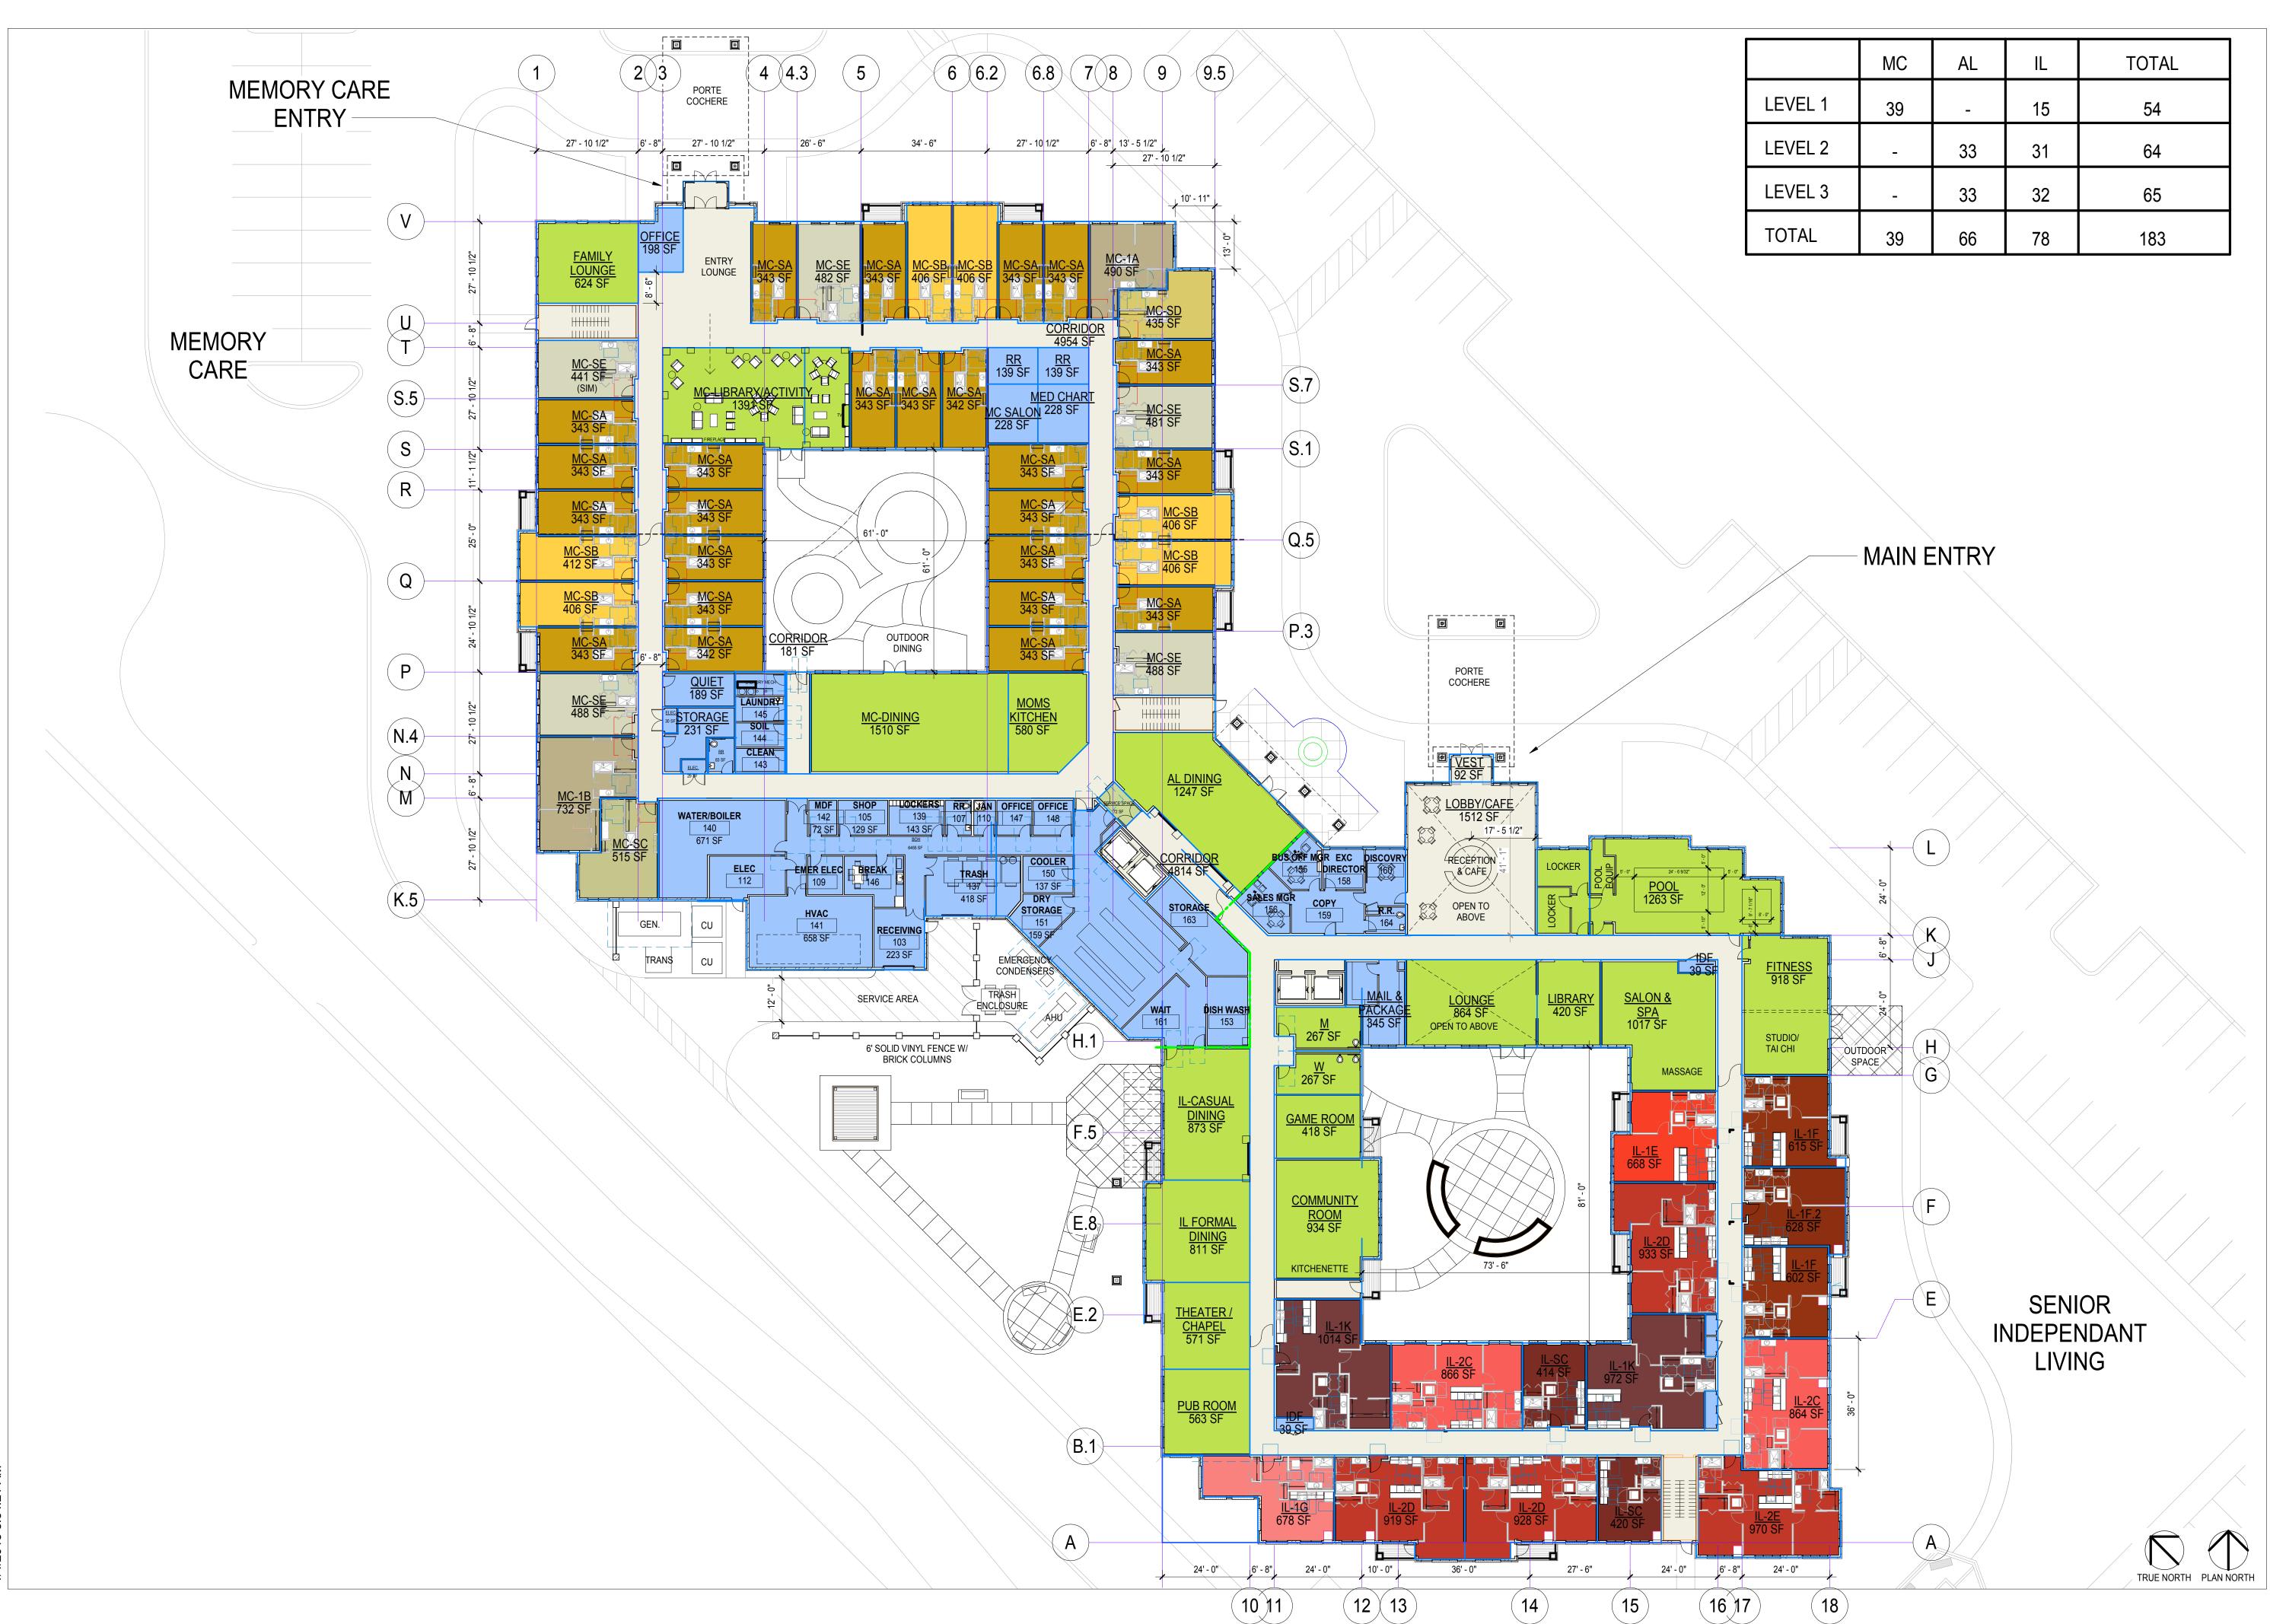
945

940

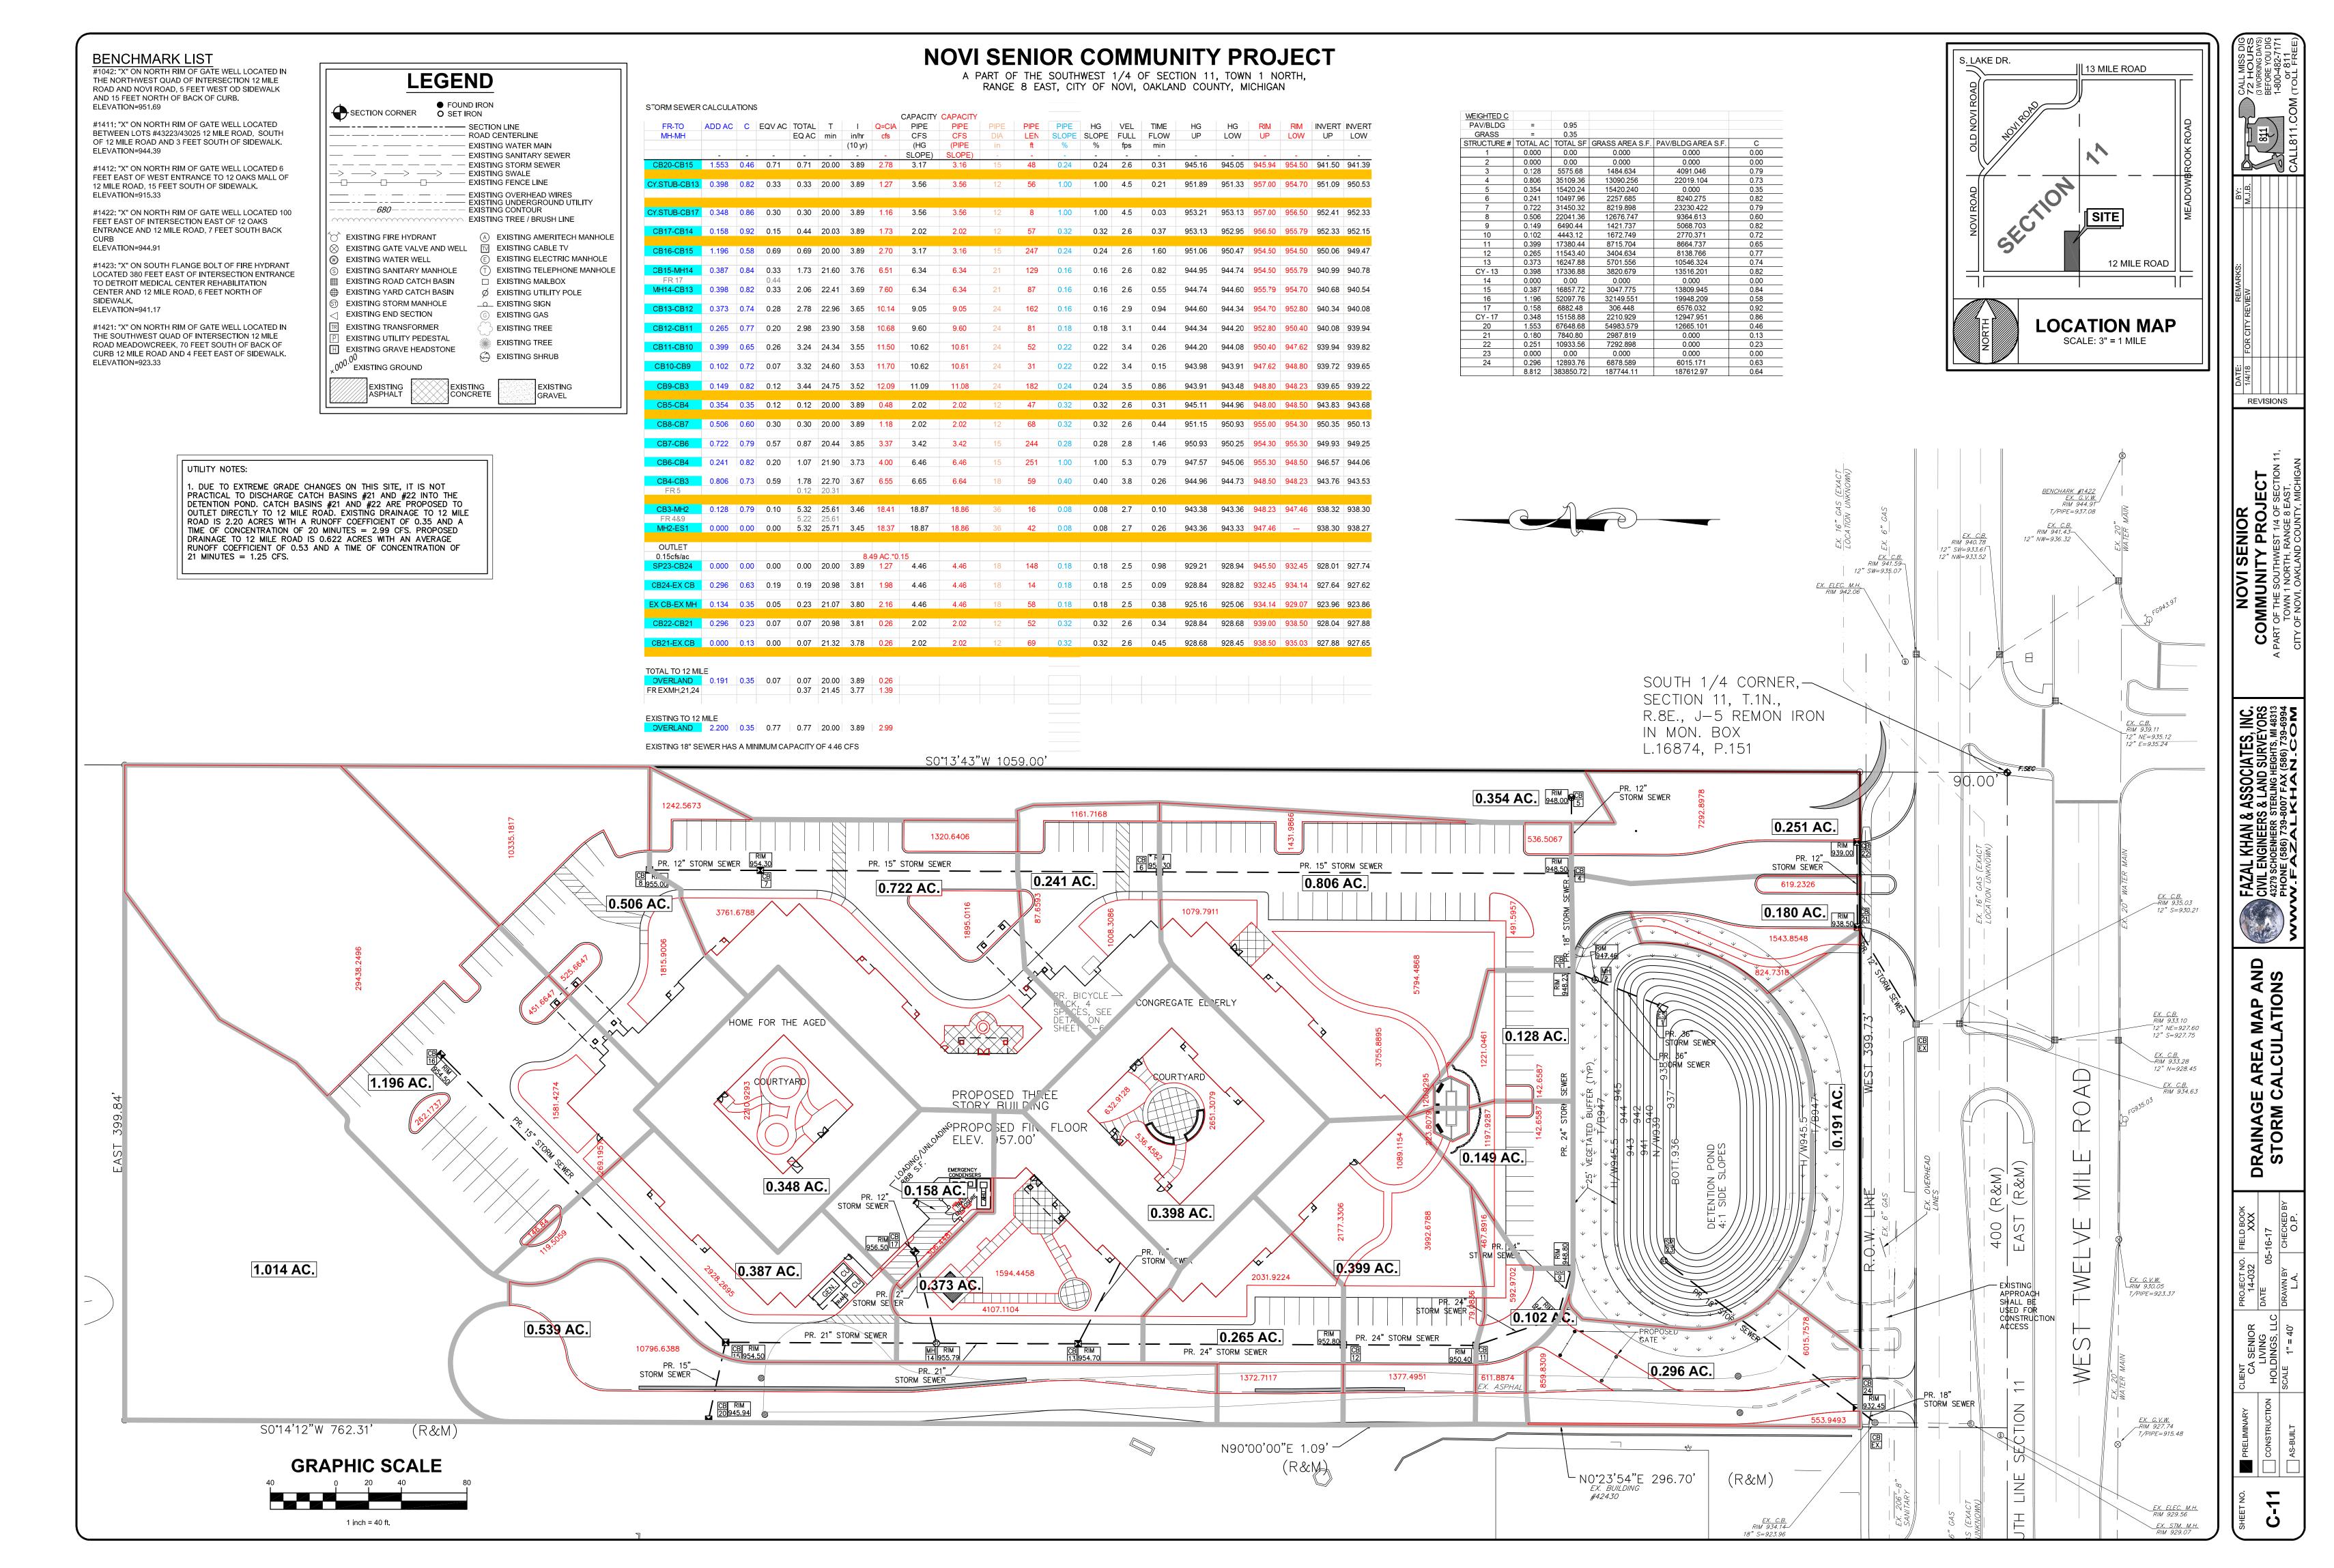

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Engineering

Boarman Kroos Vogel Group Inc.

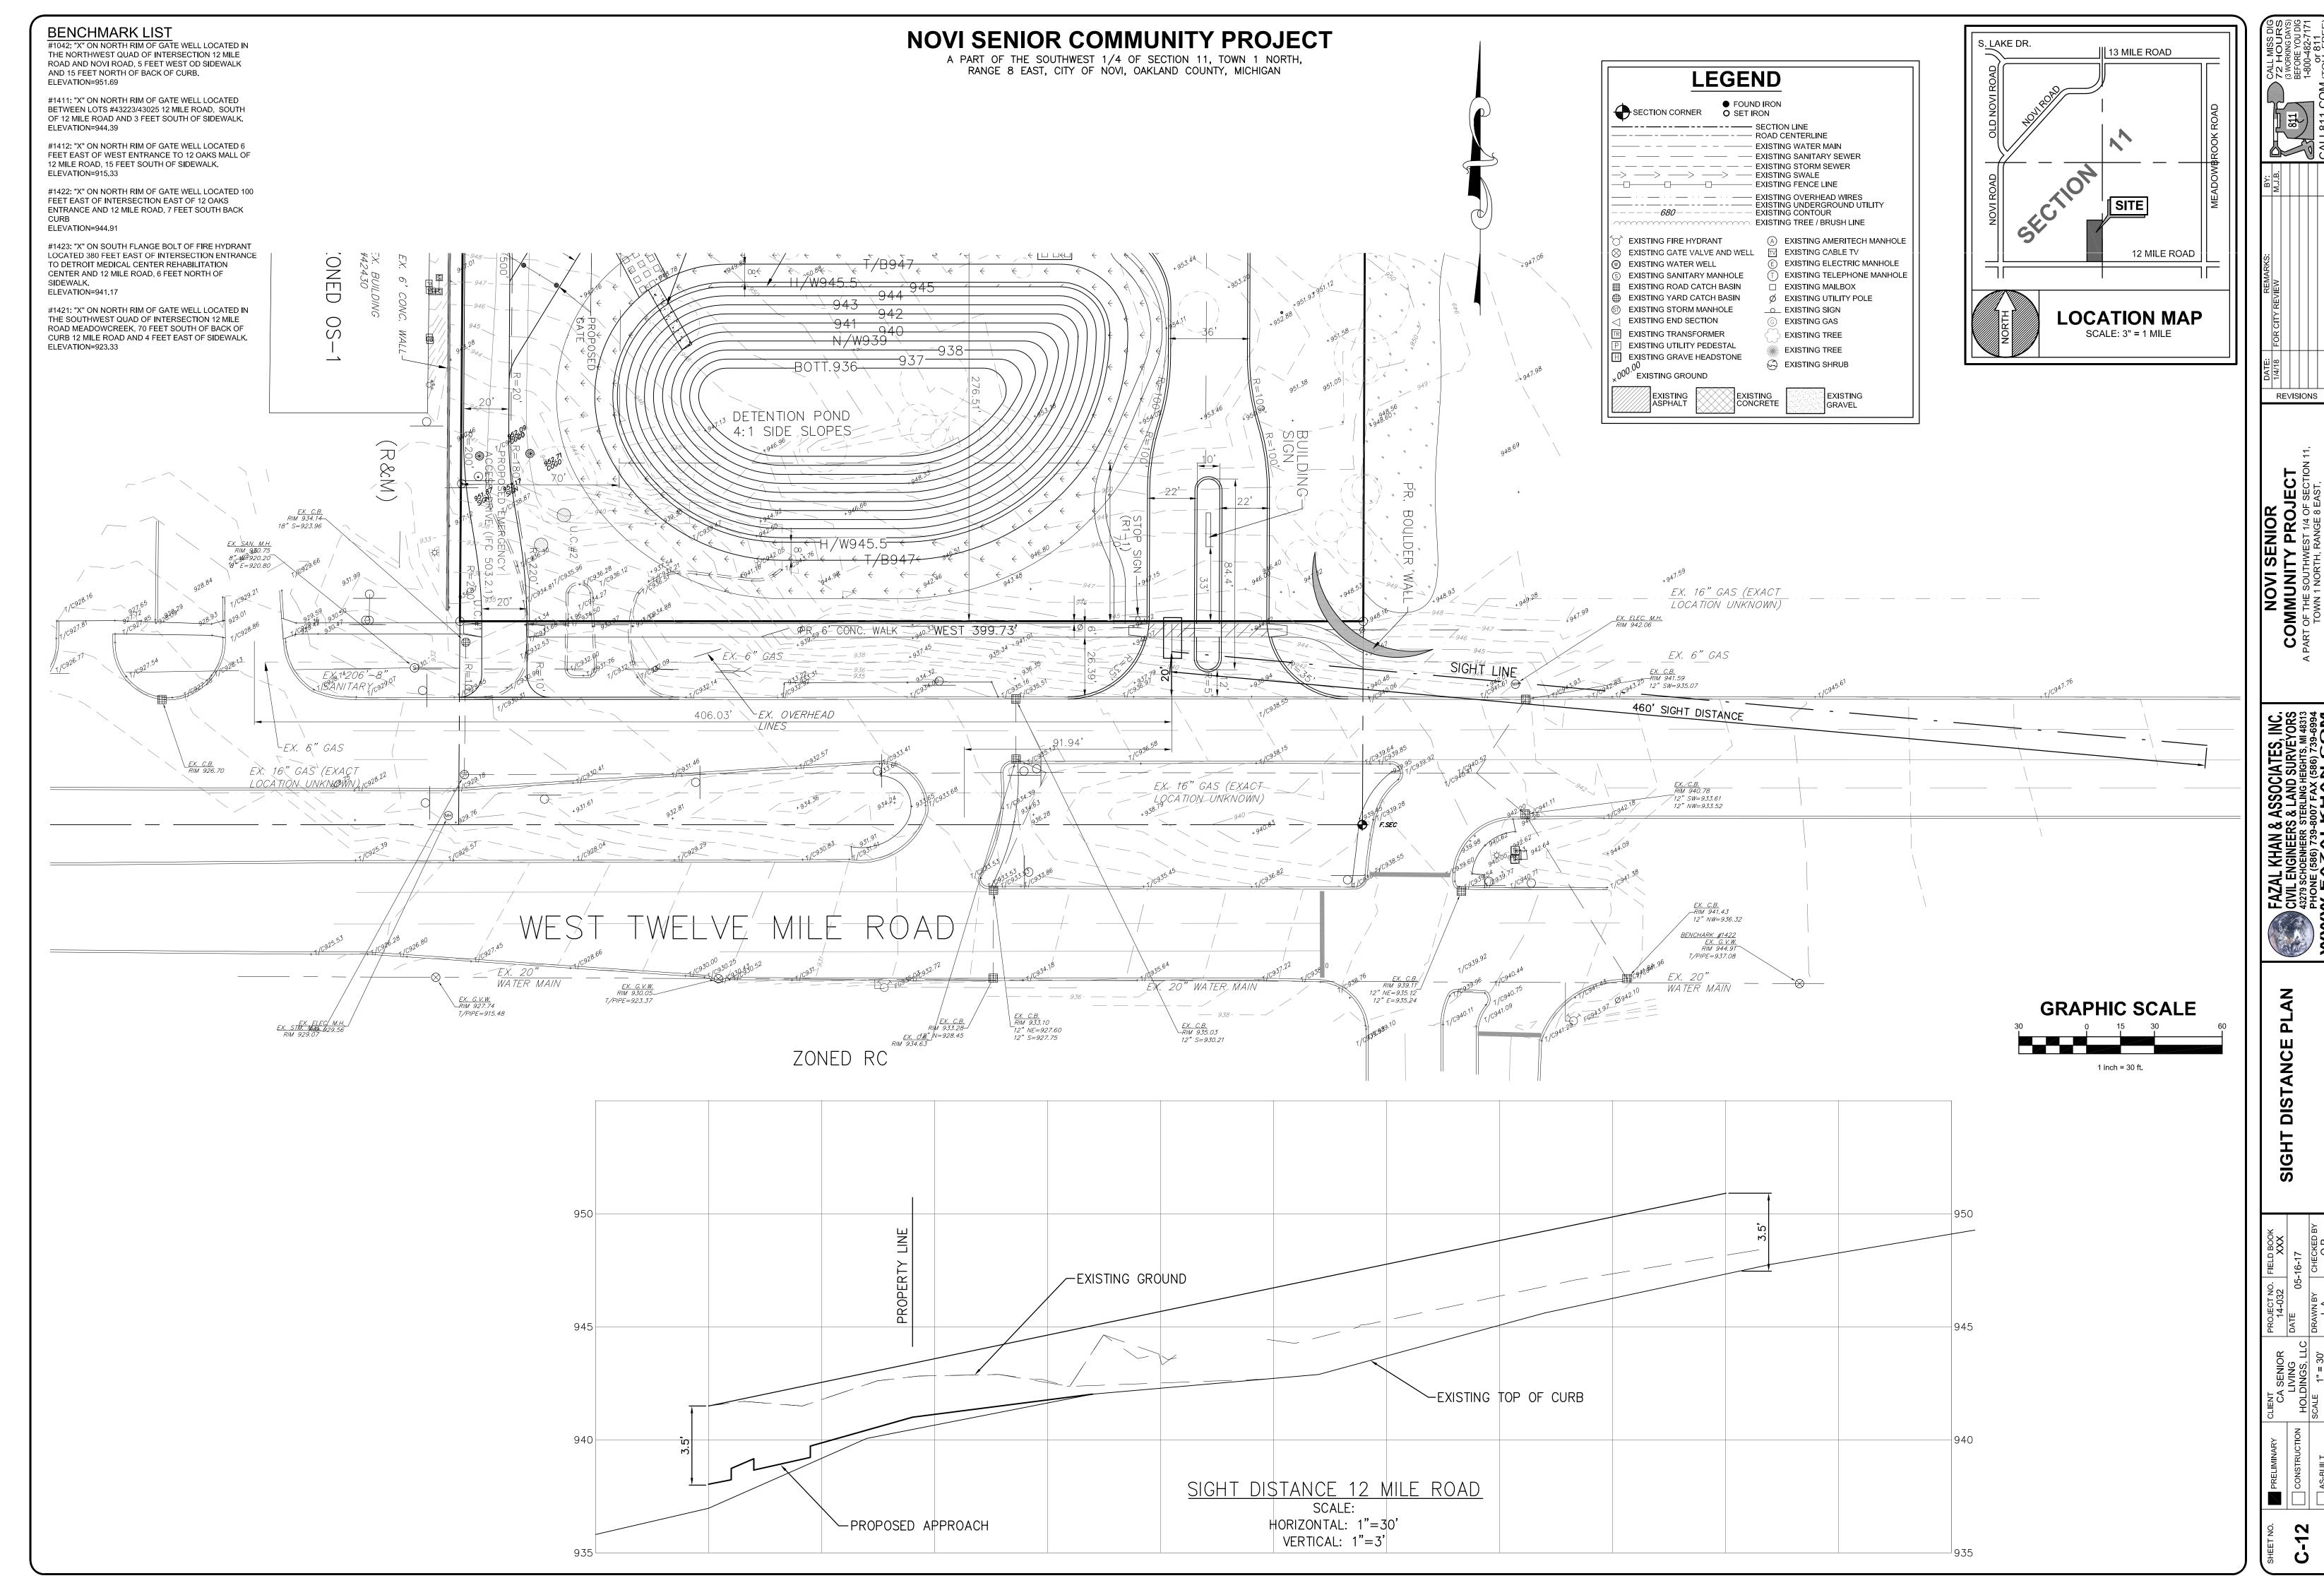343 South Dearborn Street Fisher Building, Suite 203 Chicago, IL 60604 Telephone: 312.279.0470 w w w. b k v g r o u p. c o m EOE

CONSULTANTS

PROJECT TITLE

CA Novi Senior Housing

**KEY PLAN** 

ISSUE # DATE DESCRIPTION

### CERTIFICATION

I hereby certify that this plan, specification or report was prepared by me or under my direct supervision and that I am a duly Licensed Professional Architect under the laws of the State of Michigan

wek Bow mae

Jack O Boarman
1301033020
License Number

Date

DATE
DRAWN BY
CHECKED BY

Date

Date

1/4/18

CHECKED BY
CJP

1966.10

1/4/18


COMMISSION NUMBER

SHEET TITLE

LEVEL 1

SHEET NUMBER

A1.1

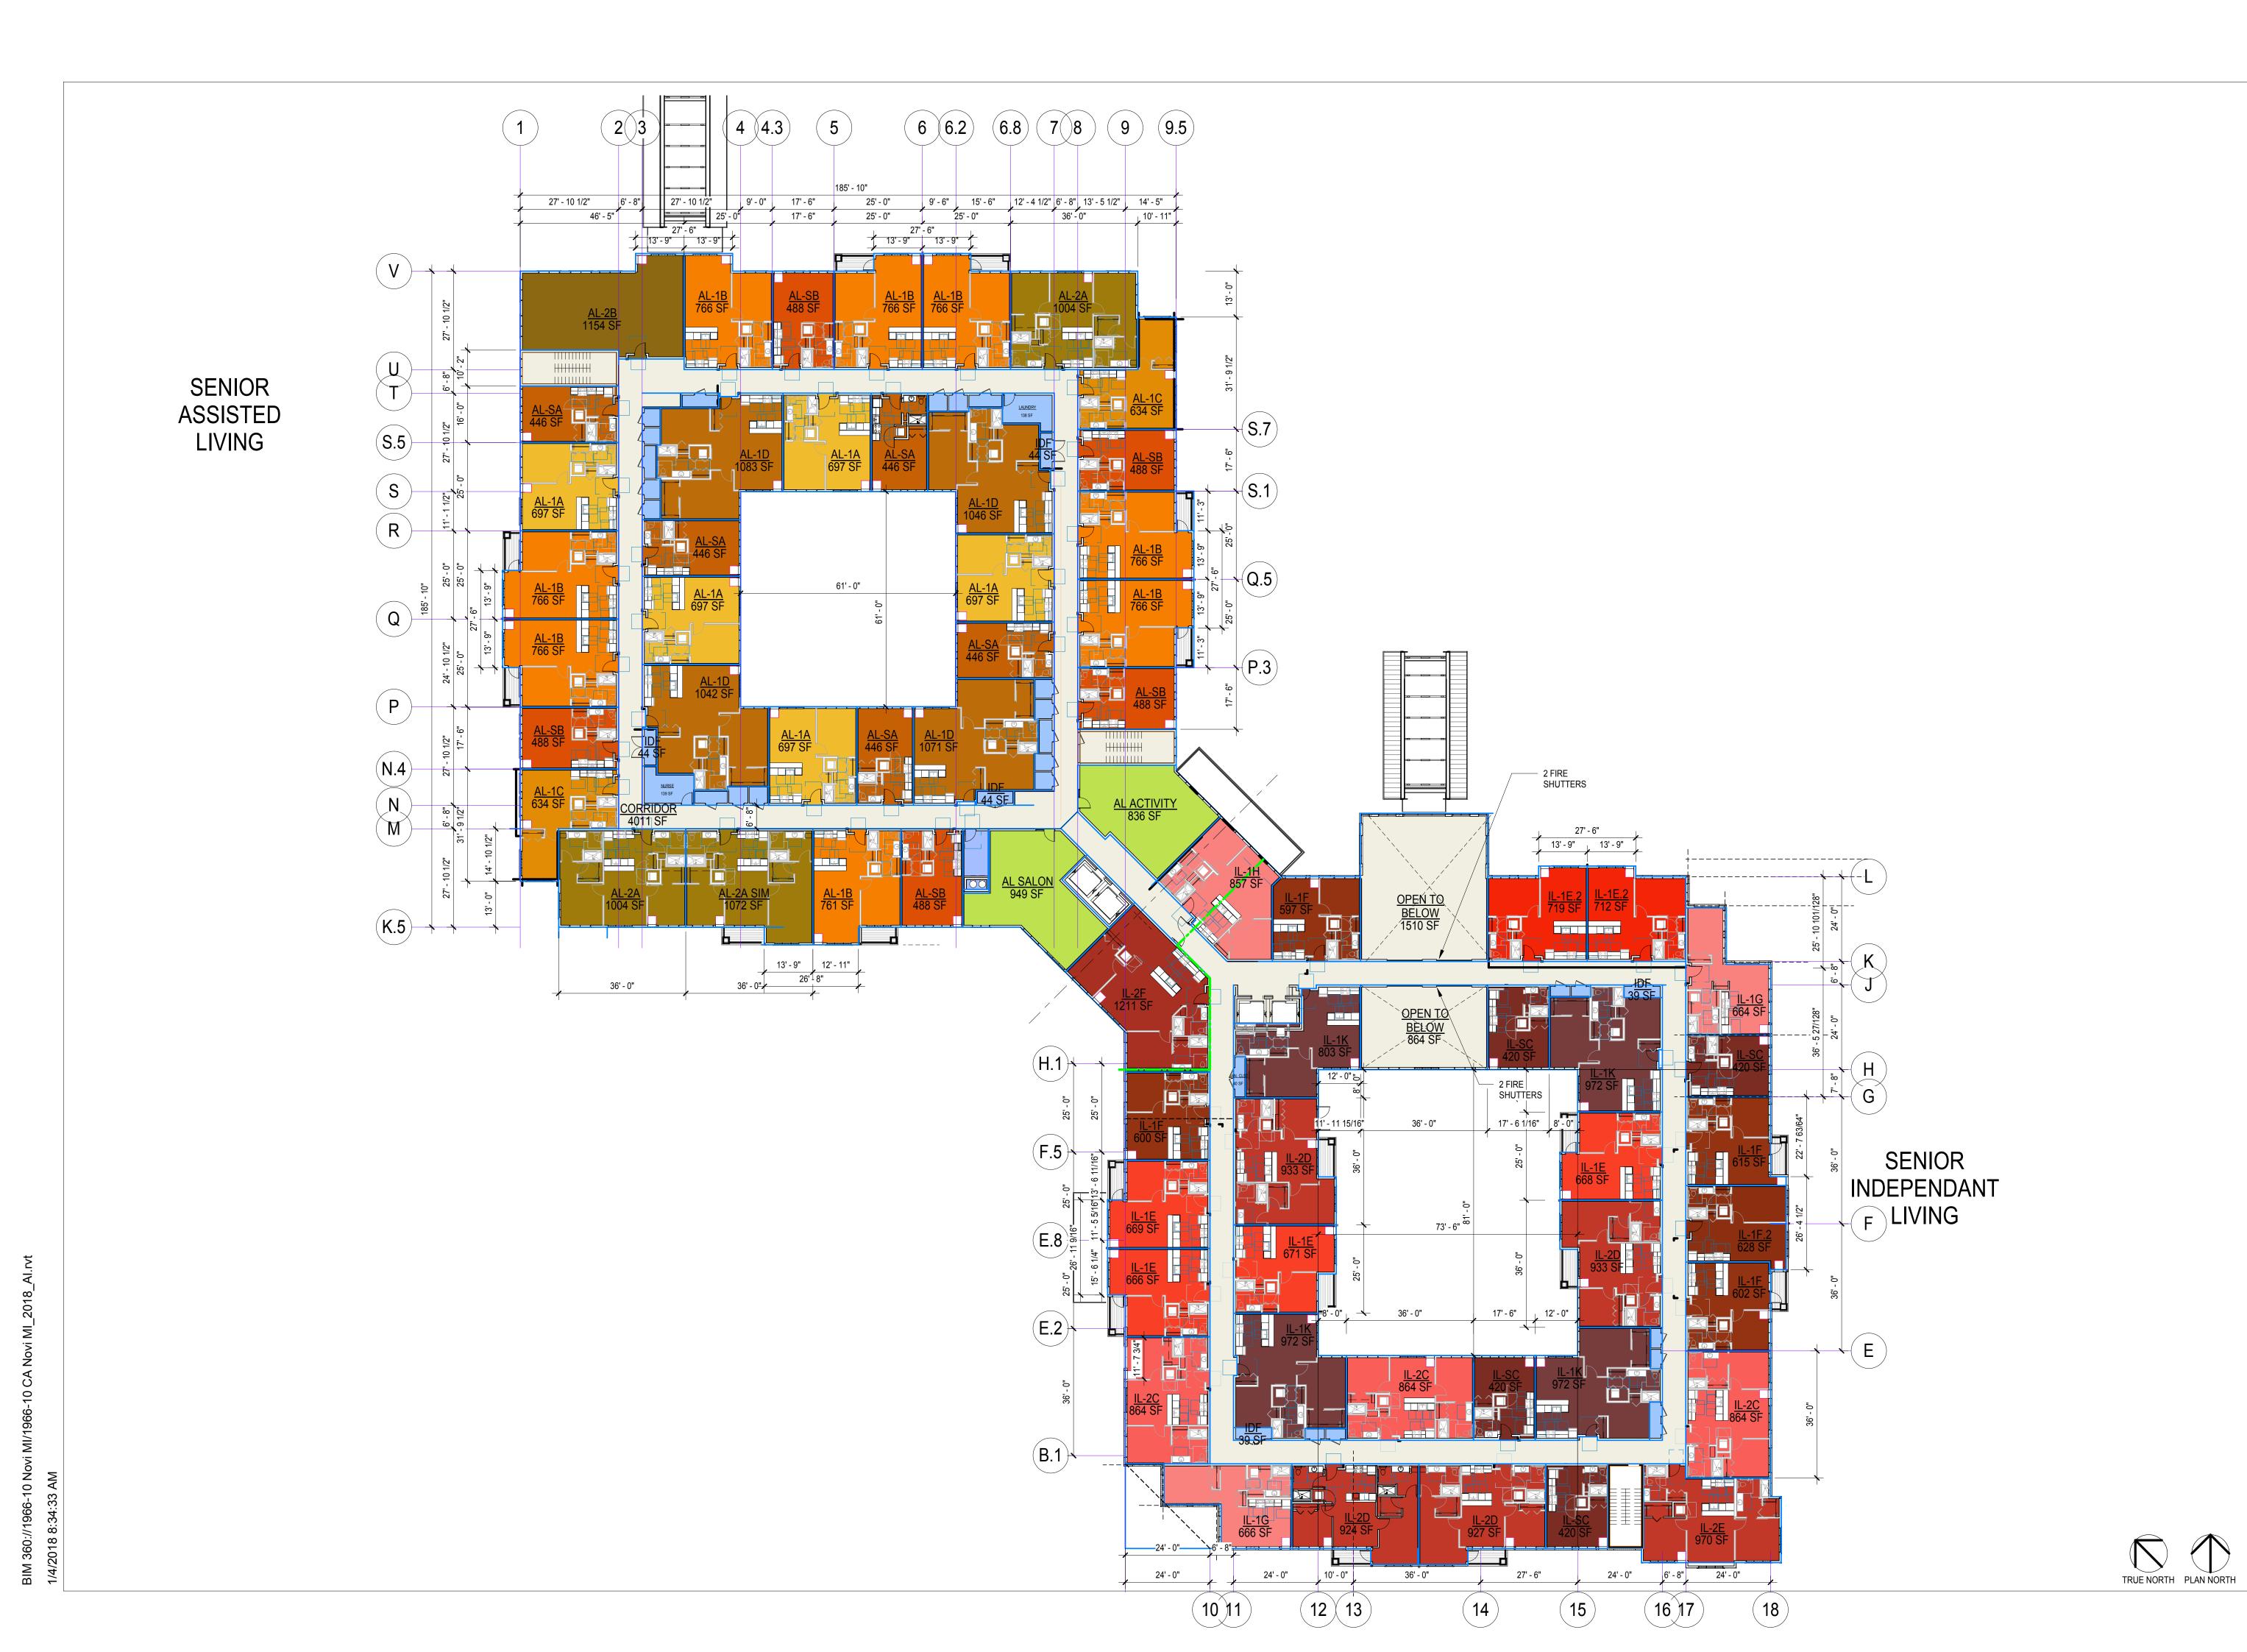

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DATE 1/4/18

DATE 1/4/18

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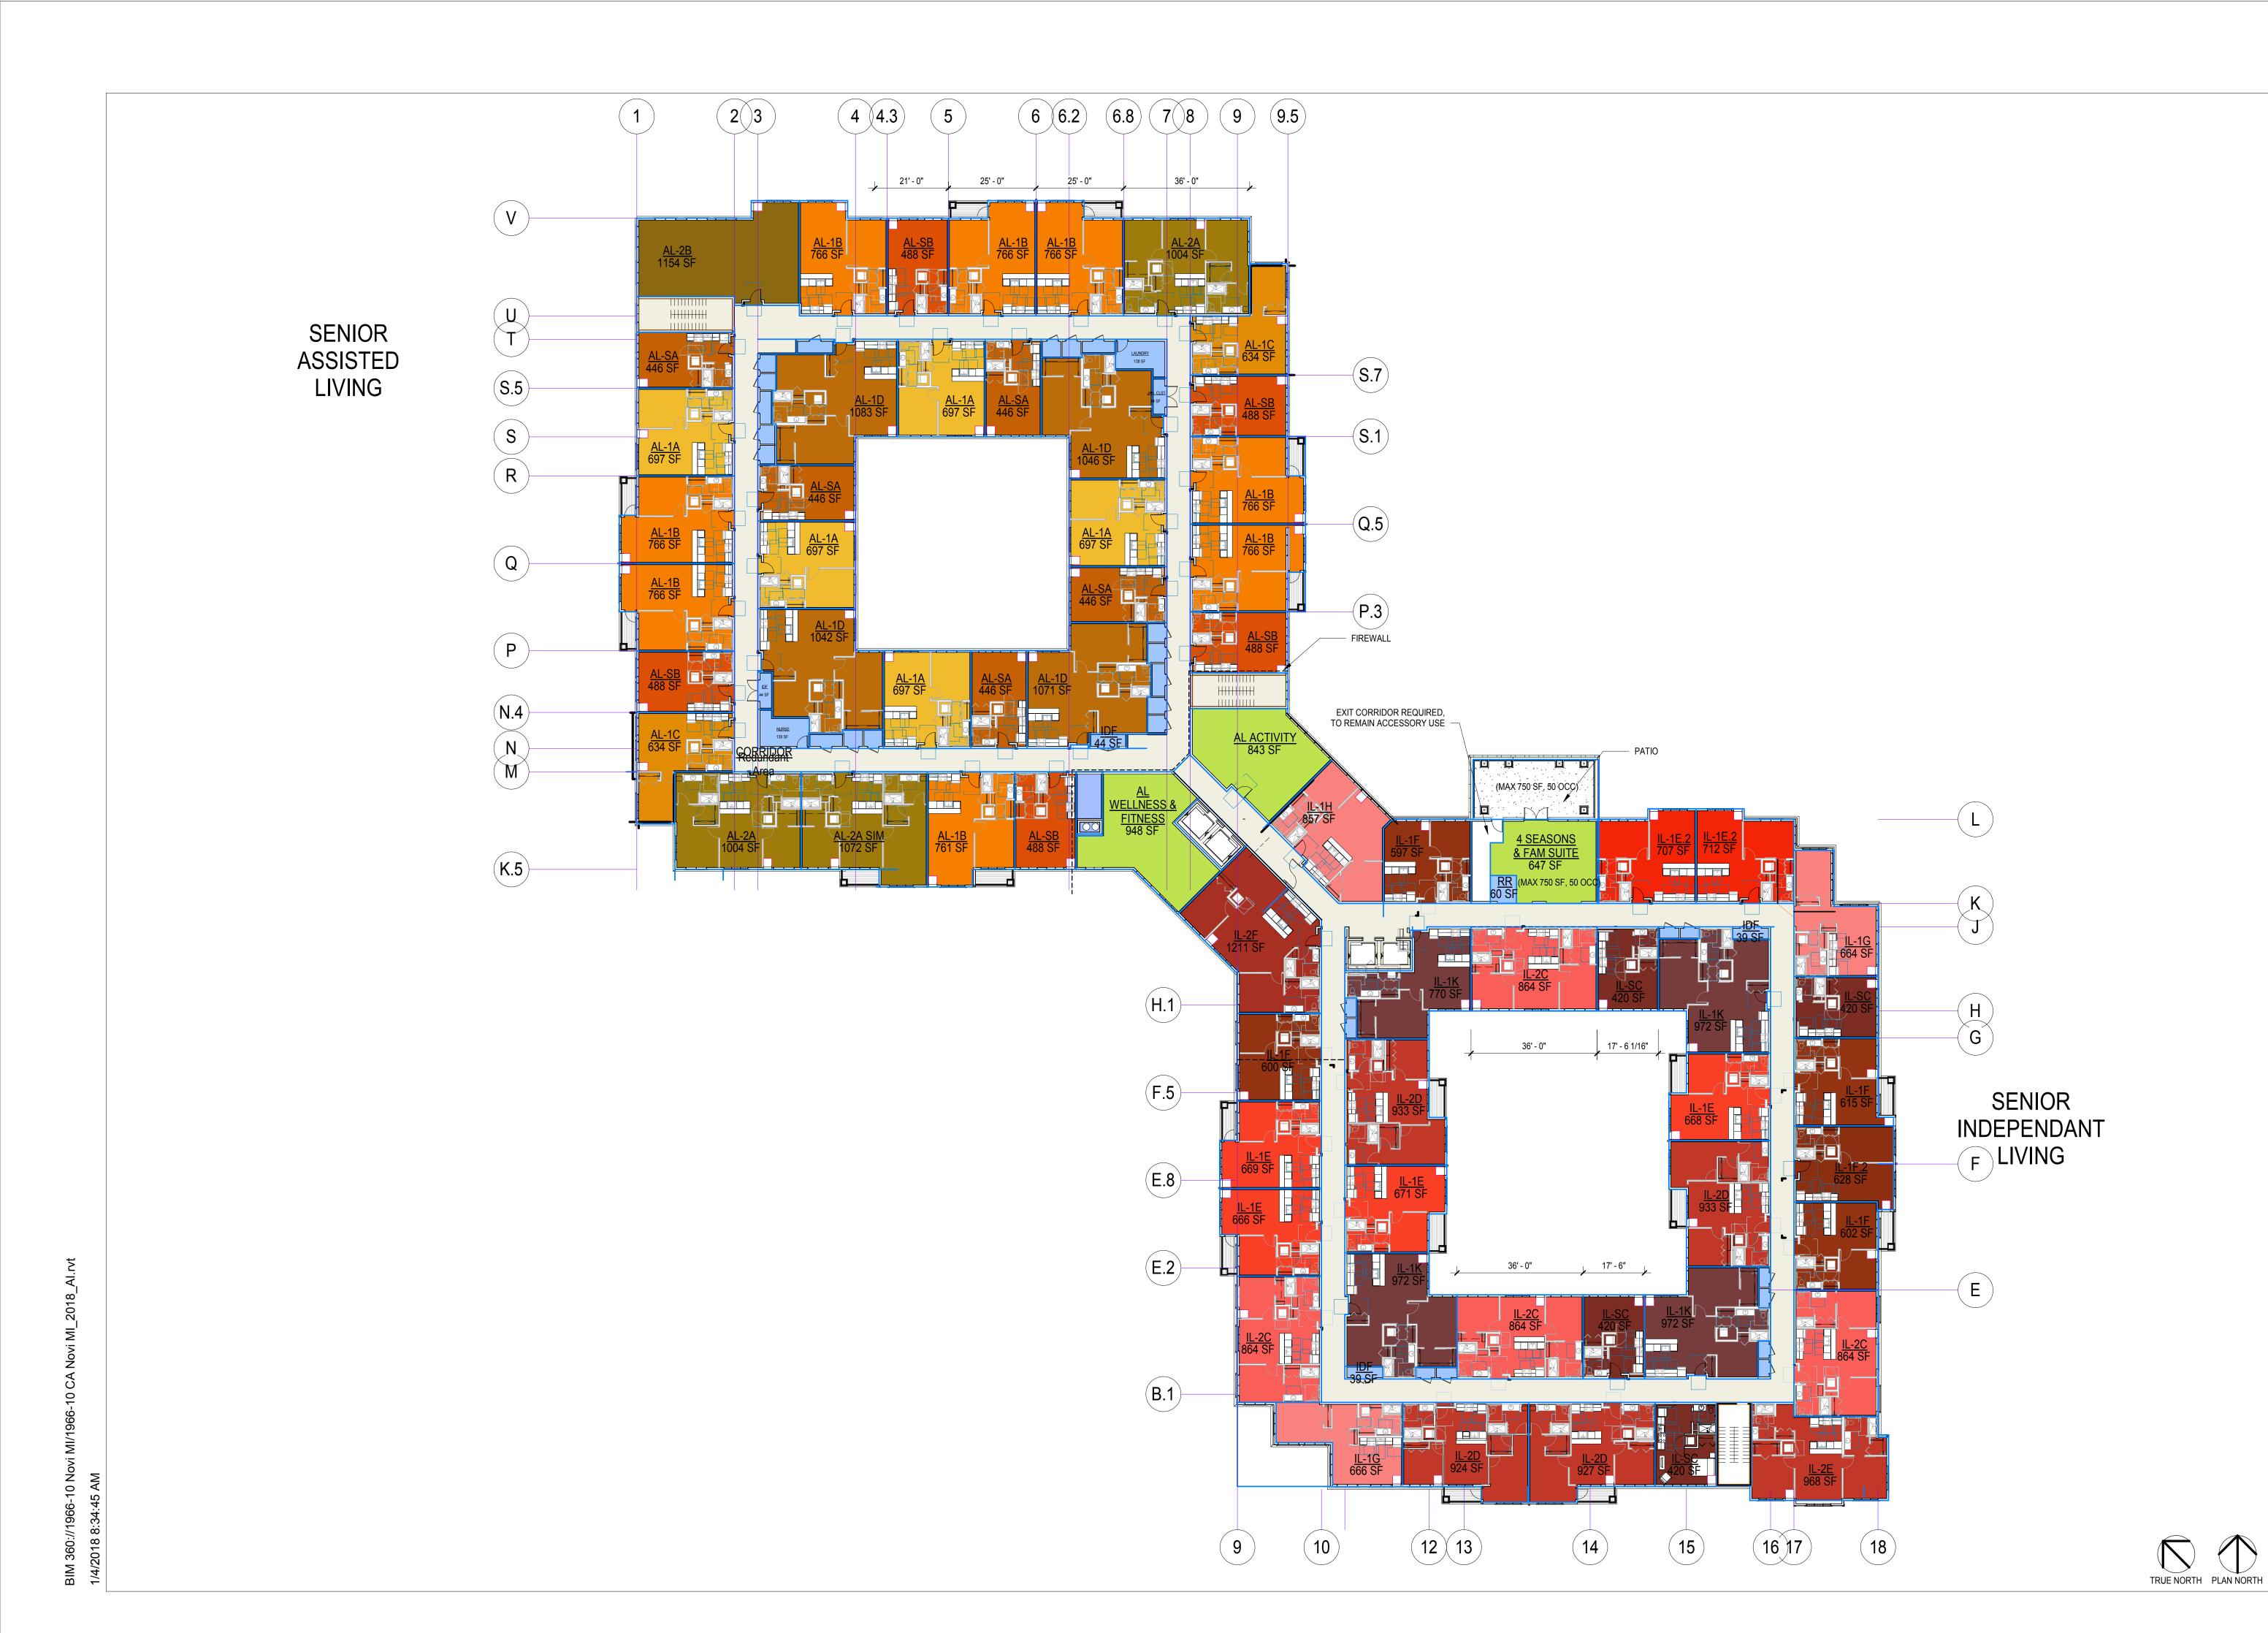
COMMISSION NUMBER 1966.10

SHEET TITLE

LEVEL 2

SHEET NUMBER

A1.2



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COMMISSION NUMBER	1966.10

SHEET TITLE

LEVEL 3

SHEET NUMBER

A1.3







Birdseye View - Northeast









Perspective View - South



Perspective View- Southwest







EAST LINK - FRONT ENTRY

BKV

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COMMISSION NUMBER 1966.10

SHEET TITLE

EXTERIOR ELEVATIONS

SHEET NUMBER

TRUE NORTH PLAN NORTH

A5.1



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Landscape Architecture
Engineering

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### PROJECT TITLE

CA Novi Senior Housing

**KEY PLAN** 

ISSUE # DATE DESCRIPTION

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License Number

DATE 1/19/18
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1966.10

1/19/18

Date


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COMMISSION NUMBER

EXTERIOR ELEVATIONS


SHEET NUMBER

A5.2

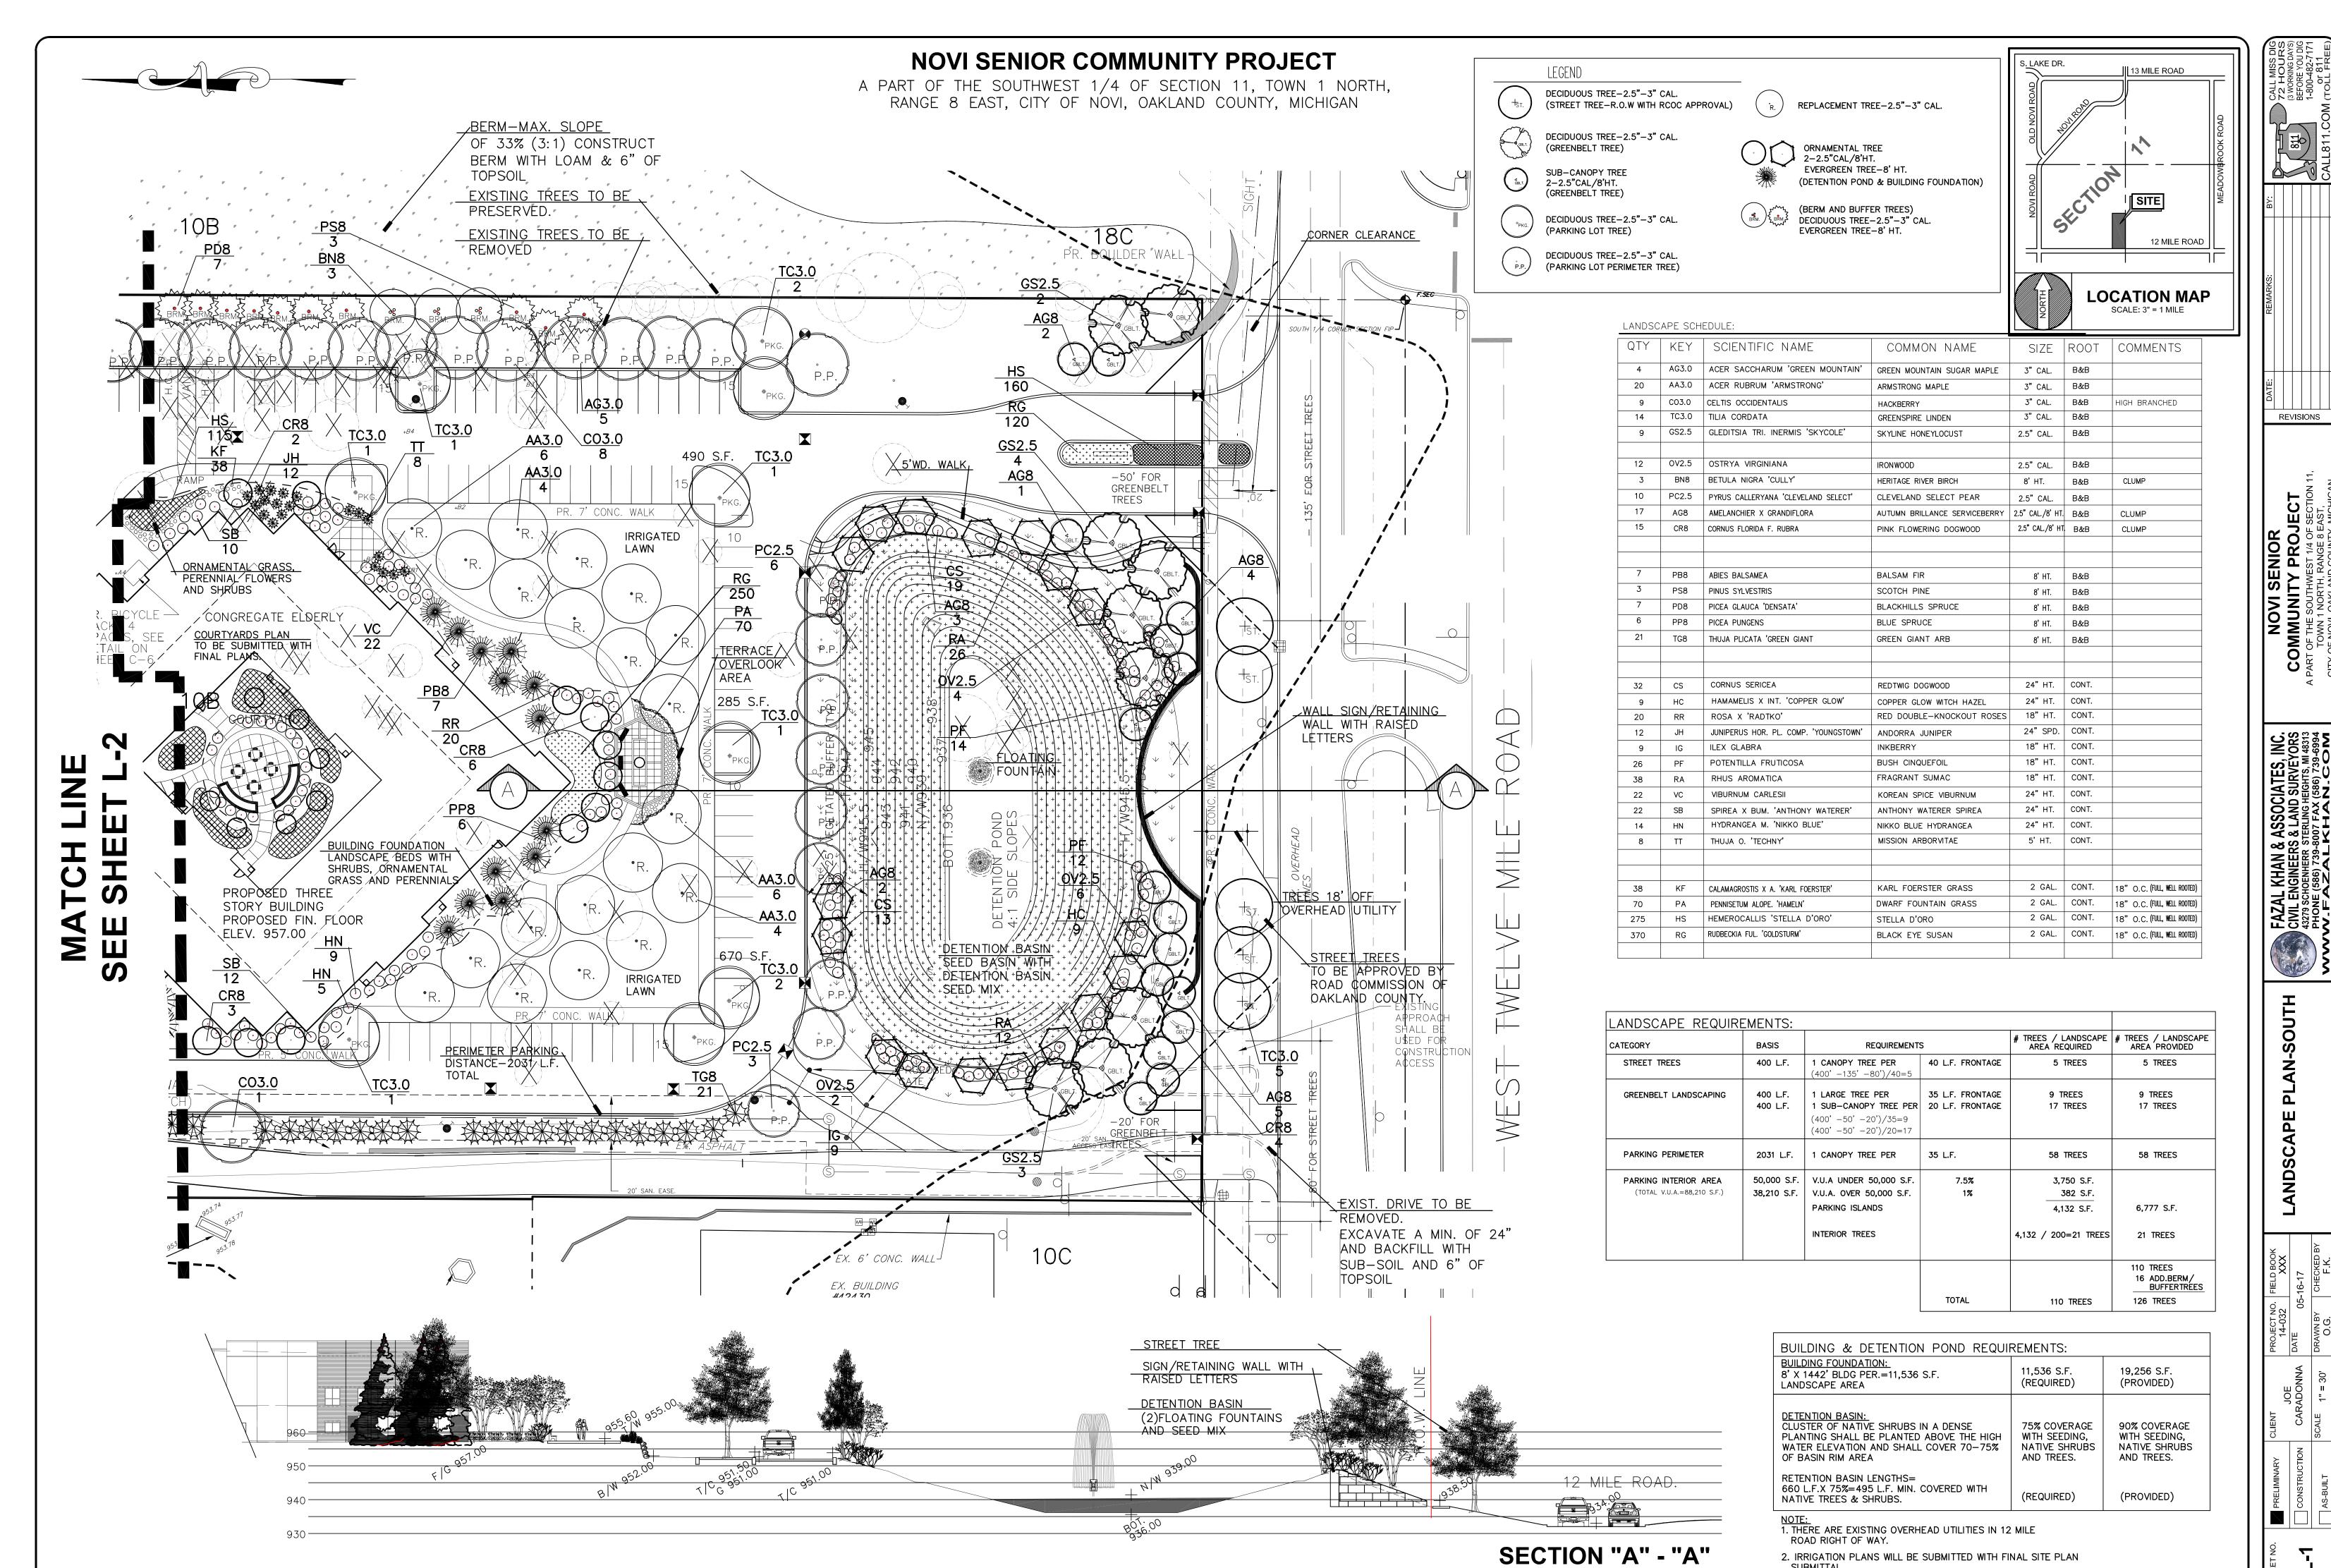

SUBMITTAL.

SCALE: 1"=20'

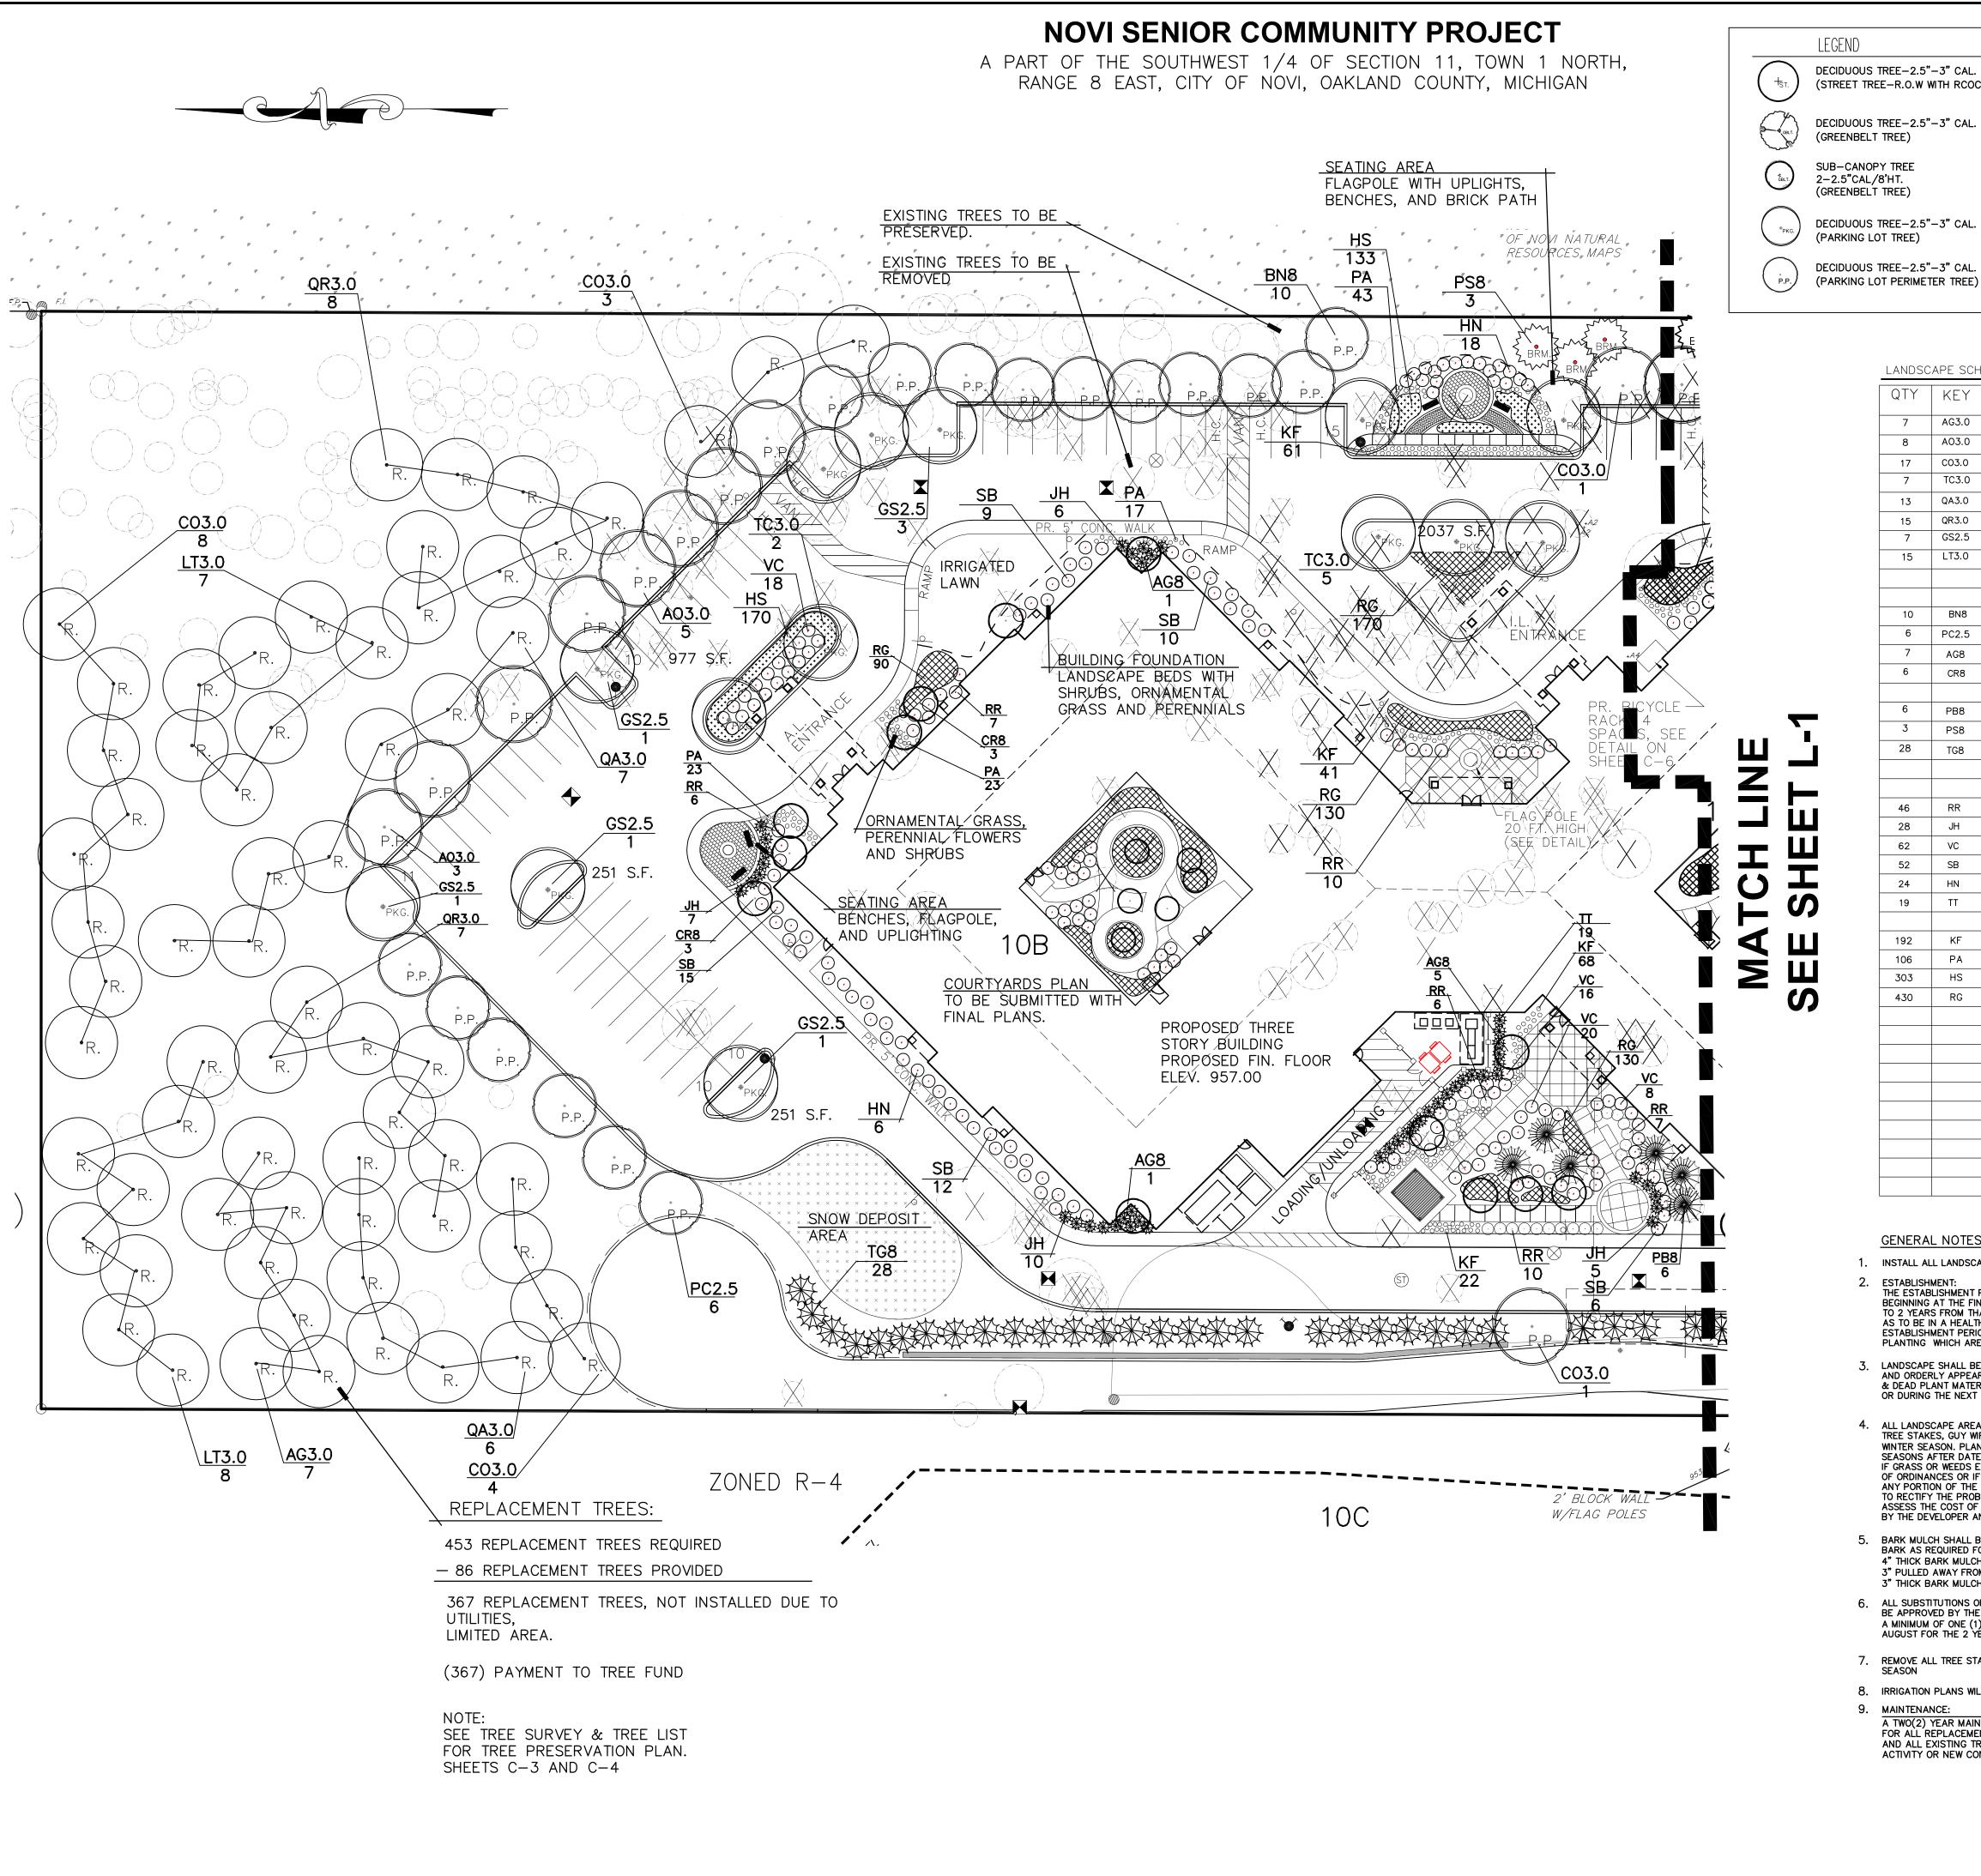

DECIDUOUS TREE-2.5"-3" CAL. (STREET TREE-R.O.W WITH RCOC APPROVAL)

REPLACEMENT TREE-2.5"-3" CAL.


EVERGREEN TREE-8' HT.



ORNAMENTAL TREE 2-2.5"CAL/8'HT. EVERGREEN TREE-8' HT.



(DETENTION POND & BUILDING FOUNDATION) (BERM AND BUFFER TREES) DECIDUOUS TREE-2.5"-3" CAL.

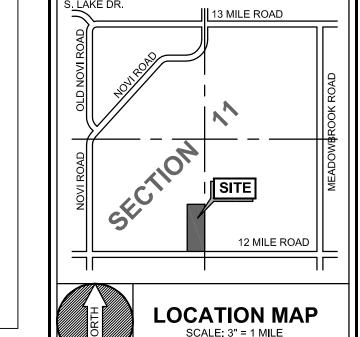

REVISIONS

LANDSCAPE SCHEDULE:

QTY | KEY | SCIENTIFIC NAME COMMON NAME SIZE ROOT COMMENTS AG3.0 ACER SACCHARUM 'GREEN MOUNTAIN' GREEN MOUNTAIN SUGAR MAPLE 3" CAL. B&B 8 A03.0 ACER RUBRUM 'OCTOBER GLORY' 3" CAL. B&B OCTOBER GLORY MAPLE 17 CO3.0 CELTIS OCCIDENTALIS 3" CAL. B&B HIGH BRANCHED HACKBERRY TC3.0 TILIA CORDATA 3" CAL. B&B GREENSPIRE LINDEN 13 QA3.0 QUERCUS ALBA 3" CAL. B&B WHITE OAK 15 QR3.0 QUERCUS RUBRA 3" CAL. B&B RED OAK 7 GS2.5 GLEDITSIA TRI. INERMIS 'SKYCOLE' SKYLINE HONEYLOCUST 2.5" CAL. 15 LT3.0 LIRIODENDRON TULIPIFERA TULIPTREE 3" CAL. B&B 10 BN8 BETULA NIGRA 'CULLY' HERITAGE RIVER BIRCH 8' HT. B&B 6 PC2.5 PYRUS CALLERYANA 'CLEVELAND SELECT' CLEVELAND SELECT PEAR 2.5" CAL. B&B AMELANCHIER X GRANDIFLORA AUTUMN BRILLANCE SERVICEBERR 2.5" CAL./8' HT. B&B CLUMP CR8 | CORNUS FLORIDA F. RUBRA PINK FLOWERING DOGWOOD 2.5" CAL./8' HT. B&B PB8 ABIES BALSAMEA BALSAM FIR 8' HT. B&B PS8 PINUS SYLVESTRIS SCOTCH PINE 8' HT. B&B 28 | TG8 | THUJA PLICATA 'GREEN GIANT GREEN GIANT ARB 8' HT. B&B ROSA X 'RADTKO' RED DOUBLE-KNOCKOUT ROSES 18" HT. CONT. 24" SPD. CONT. 28 JUNIPERUS HOR. PL. COMP. 'YOUNGSTOWN' ANDORRA JUNIPER 24" HT. CONT. VIBURNUM CARLESII KOREAN SPICE VIBURNUM 24" HT. CONT. SPIREA X BUM. 'ANTHONY WATERER' ANTHONY WATERER SPIREA HYDRANGEA M. 'NIKKO BLUE' 24" HT. CONT. NIKKO BLUE HYDRANGEA 19 TT THUJA O. 'TECHNY' MISSION ARBORVITAE 5' HT. CONT. KARL FOERSTER GRASS 2 GAL. | CONT. | 18" O.C. (FULL, WELL ROOTED) 192 KF CALAMAGROSTIS X A. 'KARL FOERSTER' 2 GAL. | CONT. | 18" O.C. (FULL, WELL ROOTED) DWARF FOUNTAIN GRASS PA PENNISETUM ALOPE. 'HAMELN' 2 GAL. CONT. 18" O.C. (FULL, WELL ROOTED) 303 HS HEMEROCALLIS 'STELLA D'ORO' STELLA D'ORO RG RUDBECKIA FUL. 'GOLDSTURM' 2 GAL. | CONT. | 18" O.C. (FULL, WELL ROOTED) BLACK EYE SUSAN

### **GENERAL NOTES:**

- 1. INSTALL ALL LANDSCAPING BETWEEN MARCH 15th AND NOVEMBER 15th OF 2017.
- THE ESTABLISHMENT PERIOD FOR THE PLANT MATERIAL GUARANTEE WILL OCCUR BEGINNING AT THE FINAL CERTIFICATE OF OCCUPANCY INSPECTION APPROVAL TO 2 YEARS FROM THAT DATE. ALL PLANTINGS SHALL BE PROPERLY PLANTED AS TO BE IN A HEALTHY, GROWING CONDITION AT COMMENCEMENT OF THE ESTABLISHMENT PERIOD, AT THE END OF THE ESTABLISHMENT PERIOD, PLANTING WHICH ARE 20% DEAD OR GREATER, SHALL BE REPLACED.
- 3. LANDSCAPE SHALL BE MAINTAINED IN A HEALTHY, NEAT AND ORDERLY APPEARANCE, FREE FROM REFUSE. ALL UNHEALTHY & DEAD PLANT MATERIAL SHALL BE REPLACED WITHIN 1 YEAR, OR DURING THE NEXT APPROPRIATE PLANTING PERIOD.
- ALL LANDSCAPE AREAS SHALL HAVE AN AUTOMATIC IRRIGATION SYSTEM, TREE STAKES, GUY WIRES, AND TREE WRAP TO BE REMOVED AFTER ONE WINTER SEASON. PLANTINGS SHALL BE GUARANTEED FOR TWO(2) GROWING SEASONS AFTER DATE OF THE ACCEPTANCE OF THE INSTALLATION. IF GRASS OR WEEDS EXCEED THE HEIGHT SPECIFIED IN THE NOVI CODE OF ORDINANCES OR IF SHRUBS ARE ALLOWED TO OBSTRUCT VISION ACROSS ANY PORTION OF THE ISLAND AND THE RESPONSIBLE PARTY IS UNWILLING TO RECTIFY THE PROBLEM THE CITY WILL ABATE SUCH VIOLATIONS AND SHALL ASSESS THE COST OF SUCH ABATEMENT MEASURES IN THE MANNER PROPOSED BY THE DEVELOPER AND APPROVED BY THE CITY IN SUCH INSTRUMENT.
- 5. BARK MULCH SHALL BE NATURAL COLOR, FINELY SHREDDED HARDWOOD BARK AS REQUIRED FOR ALL PLANTINGS. 4" THICK BARK MULCH FOR TREES, IN A 4-FOOT DIAMETER CIRCLE WITH 3" PULLED AWAY FROM TRUNK. 3" THICK BARK MULCH FOR SHRUBS AND 2" THICK BARK FOR PERENNIALS.
- 6. ALL SUBSTITUTIONS OR DEVIATIONS FROM THE LANDSCAPE PLAN MUST BE APPROVED BY THE CITY OF NOVI PRIOR TO INSTALLATION. A MINIMUM OF ONE (1) CULTIVATION IN PLANTED AREAS IN JUNE, JULY AND AUGUST FOR THE 2 YEAR WARRANTY PERIOD.
- 7. REMOVE ALL TREE STAKES, GUY WIRES, AND TREE WRAP AFTER ONE(1) WINTER
- 8. IRRIGATION PLANS WILL BE SUBMITTED WITH FINAL LANDSCAPE PLANS.
- MAINTENANCE: A TWO(2) YEAR MAINTENANCE GUARANTEE IS REQUIRED FOR ALL REPLACEMENT TREES PLANTED ON-SITE AND ALL EXISTING TREES ADJACENT TO GRADING ACTIVITY OR NEW CONSTRUCTION.

### **PLANTING NOTES:**

- LANDSCAPE CONTRACTOR (CONTRACTOR) SHALL VISIT SITE. INSPECT EXISTING CONDITIONS AND REVIÉW PROPOSED PLANTING AND RELATED WORK. IN CASE OF DISCREPANCY BETWEEN PLAN AND PLANT LIST, PLAN SHALL GOVERN QUANTITIES. CONTACT LANDSCAPE ARCHITECT WITH ANY CONCERNS.
- 2. CONTRACTOR SHALL VERIFY LOCATIONS OF ALL ON-SITE UTILITIES PRIOR TO BEGINNING CONSTRUCTION ON HIS/HER PHASE OF WORK. ELECTRIC, GAS, TELEPHONE, CABLE TELEVISION MAY BE LOCATED BY CALLING MISS DIG 1-800-482-7171. ANY DAMAGE OR INTERRUPTION OF SERVICES SHALL BE THE RESPONSIBILITY OF CONTRACTOR. CONTRACTOR SHALL COORDINATE ALL RELATED ACTIVITIES WITH OTHER TRADES ON THE JOB AND SHALL REPORT ANY UNACCEPTABLE JOB CONDITIONS TO OWNER'S REPRESENTATIVE PRIOR TO COMMENCING.
- 3. ALL PLANT MATERIAL TO BE PREMIUM GRADE NURSERY STOCK. AND SHALL SATISFY AMERICAN ASSOCIATION OF NURSERYMEN STANDARD FOR NURSERY STOCK, ALL PLANT MATERIAL TO BE NORTHERN GROWN, NO 1 GRADE. TREES SHALL BE STAKED, WRAPPED, WATERED AND MULCHED PER CITY OF NOVI DETAILS AND SPECIFICATION.
- INSTALL SOD IN ALL AREAS INDICATED ON PLAN. SOD TO BE WELLTHE AUTOMATIC IRRIGATION SYSTEM SHALL PROVIDE 100% COVERAGE ON ALL LAWN AREAS.
- 5. GUARANTEE OF PLANTS FOR TWO(2) YEARS SHALL BEGIN AFTER ACCEPTANCEBY LANDSCAPE ARCHITECT AND/OR PROJECT REPRESENTATIVE. THE CONTRACTOR SHALL GUARANTEE ALL PLANTS TO BE IN A HEALTHY, VIGOROUS CONDITION FOR A PERIOD OF TWO(2) YEARS FOLLOWING ACCEPTANCE. CONTRACTOR SHALL REPLACE WITHOUT COST TO OWNER, ANY DEAD OR UNACCEPTABLE PLANTS, AS DETERMINED BY PROJECT REPRESENTATIVE DURING AND AT THE END OF THE GUARANTEE PERIOD. THE TWO(2) YEAR WARRANTY PERIOD WILL BEGIN AFTER THE "CITY OF NOVI" HAS APPROVED THE TREES.

PLANT TREES & SHRUBS GENERALLY NO CLOSER FOLLOWING DISTANCES, FROM PROPERTY LINES, FROADS. AND WALKWAYS:	
PROPERTY LINES	4'
PUBLIC UTILITIES	
OVERHEAD LINES	15'
HYDRANTS	15'
ROADS	10'
WALKWAYS	4'

6. ALL REQUIRED LANDSCAPE MATERIAL INDICATED ON THE APPROVED PLANS WILL BE REQUIRED THROUGHOUT THE LIFE OF THE PROJECT AND MUST BE REPLACED IF REMOVED OR

**NOVI SENIOR COMMUNITY PROJECT** 

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FOLLOWING DISTANCES, FROM PROPERTY LINES, PUBLIC UTILITIES ROADS, AND WALKWAYS:

PROPERTY LINES	4'
PUBLIC UTILITIES	6'
OVERHEAD LINES	15'
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6. ALL REQUIRED LANDSCAPE MATERIAL INDICATED ON THE APPROVED PLANS WILL BE REQUIRED THROUGHOUT THE LIFE OF THE PROJECT AND MUST BE REPLACED IF REMOVED OR

### 7. WOODLAND PRESERVATION:

TO PRESERVE WOODLAND CHARACTER OF EXISTING WOODLAND. TREE PROTECTION FENCING SHALL BE INSTALLED PRIOR TO CONSTRUCTION AND SHALL REMAIN UNTIL CONSTRUCTION IS COMPLETE. NO ACTIVITY INCLUDING STORAGE OF EQUIPMENT, VEHICULAR PARKING ETC. SHALL TAKE PLACE WITHIN THE BOUNDARIES

OF FENCED-OFF AREA. THE OWNER SHALL PROVIDE ON-GOING MAINTENCE AFTER CONSTRUCTION IS COMPLETE. THE OWNER SHALL PROHIBIT THE USE OF LAWN MOWERS. WEED WHIPS, FERTILIZERS, AND IRRIGATION FROM IMPACTING EXISTING WOODLANDS.

### REPLACEMENT TREES:

REPLACEMENT TREE PLANTED ON-SITE, INCLUDING UNDERSTORY VEGETATION AND GROUNDCOVER WILL BECOME REGULATED.

### REQUIRED REPLACEMENT TREES:

8" < 11" = 1 REPLACEMENT TREE > 11" < 20" = 2 REPLACEMENT TREES > 20" < 29" = 3 REPLACEMENT TREES

PRELIMIN	NARY COST C	PINION:
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COMMON	NAME	COST	TOT

= 4 REPLACEMENT TREES

124	SHADE TREES	\$400.00	\$49,600
81	EVERGREEN TREE	\$325.00	\$26,325
86	SUB CANOPY	\$250.00	\$21,500
374	DECIDUOUS SHRUB	\$50.00	<b>\$</b> 18,700
77	EVERGREEN SHRUB	\$50.00	<b>\$</b> 3,850
1784	PERENNIALS	\$15.00	\$26,760

\$146,735

700 L.F.	EDGING	\$1.50 L.F.	<b>\$1,</b> 050
160 CY	MULCH	\$35.00 CY	<b>\$</b> 5,600
2970 SY	SOD	\$6.00 SY	<b>\$</b> 17,820
7500 SY	HYDRO-SEED	\$3.00 SY	\$22,500
2370 SY	DETENTION BASIN SEED	\$3.00 SY	\$7,110

\$54,080 \$200,815 TOTAL

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TO INSURE PROPER MAINTENANCE AS A CONDITION OF FINAL SITE PLAN APPROVAL THE PROPERTY OWNER SHALL ENTER INTO AND RECORD WITH THE OFFICE OF THE OAKLAND COUNTY REGISTER OF DEEDS A LANDSCAPE MAINTENANCE AGREEMENT, OR INCLUDE SUCH PROVISIONS AS PART OF SUBDIVISION RESTRICTIONS OR CONDOMINIUM MASTER DEED, EACH OF WHICH SHALL BE APPROVED BY THE CITY ATTORNEY. THIS INSTRUMENT SHALL IDENTIFY THE MIN. PLAN OF MAINTENANCE, THE PERSON OR ENTITY RESPONSIBLE FOR MAINTENANCE.

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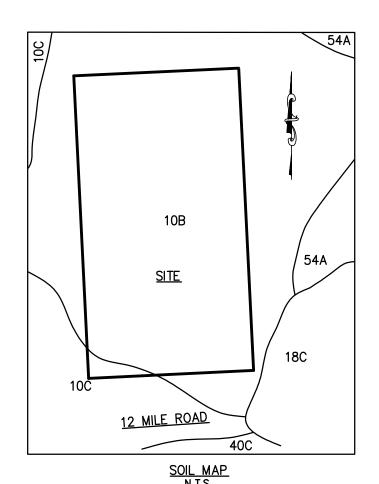
- 5. WOODLAND PERMIT:
- PERMIT REQUIRED BEFORE, REMOVING ANY EXISTING ON-SITE TREE.
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SOIL TYPES 10B Marlette sandy loam, 1 to 6 percent slopes 10C Marlette sandy loam, 6 to 12 percent slopes 18C Fox sandy loam, 6 to 12 percent slopes 40A Udorthents, loamy, nearly level 40C Udorthents, loamy, rolling 54A Matherton sandy loam, 0 to 3 percent slopes

## (734)222-9690 OFFICE ROOT BALL DIRT IS TO BE REMOVED FROM ROOT FLARE, TYP. ROW OF DO NOT PILE MULCH AGAINST PLANT STEMS 18" O.C. 2" SHREDDED BARK MULCH SPECIFIED PLANTING MIX REMOVE ALL CONTAINERS PRIOR TO PLANTING

PERENNIAL PLANTING DETAIL NOT TO SCALE

### Stormwater Seed Mix


A wetland seed mix for saturated soils in a detention pond or for seeding a saturated basin, this mix will tolerate highly flucturating water levels and poor water quality associated with urban stormwater wetlands and ponds.

Botanical Name	Common Name	PLS Ounces/Acre
Permanent Grasses/Sedges/Ru	ushes:	
Carex crisatella	Crested Oval Sedge	2.00
Carex Iurida	Bottlebrush Sedge	3.00
Carex vulpinoidea	Brown Fox Sedge	6.00
Elymus virginicus	Virginia Wild Rye	13.50
Glyceria striata	Fowl Manna Grass	1.25
Juncus effusus	Common Rush	2.00
Leersia oryzoides	Rice Cut Grass	1.00
Panicum virgatum	Switch Grass	2.00
Scirpus atrovirens	Dark Green Rush	2.00
Scirpus cypernus	Wool Grass	1.00
Scirpus fluviatilis	River Bulrush	0.25
Scirpus validus	Great Bulrush	3.00
	Total	37.00
Temporary Cover:		
Avena sativa	Common Oat	360.00
Lolium multiflorum	Annual Rye	100.00
	Total	460.00
Forbs & Shrubs:		
Alisma spp.	Water Plantain (Various Mix)	4.25
Asclepias incarnata	Swamp Milkweed	1.50
Aster novae-angliae	New England Aster	1.50
Bidens spp.	Bidens (Various Mix)	2.00
Helenium autumnale	Sneezeweed	2.00
Iris virginica	Blue Flag	4.00
Lycopus americanus	Common Water Horehound	0.25
Mimulus ringens	Monkey Flower	1.00
Penthorum sedoides	Ditch Stonecrop	0.50
Polygonum spp.	Pinkweed (Various Mix)	4.00
Rudbeckia subtomentosa	Sweet Black-Eyed Susan	1.00
Rudbeckia triloba	Brown-Eyed Susan	1.50
Sagittaria latifolia	Common Arrowhead	1.00
Senna hebacarpa	Wild Senna	1.00
Solidago riddelli	Riddell's Goldenrod	0.50
I		


Purple Meadow Rue


SEED SUPPLIER CONTACT: CARDNO JF NEW 605 S. MAIN STREET ANN ARBOR, MI 48104


Thalictrum dasycarpum

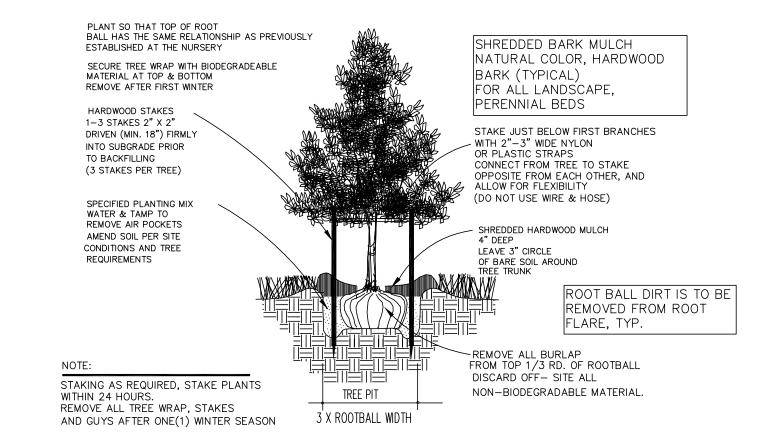

### DECIDUOUS TREE PLANTING DETAIL

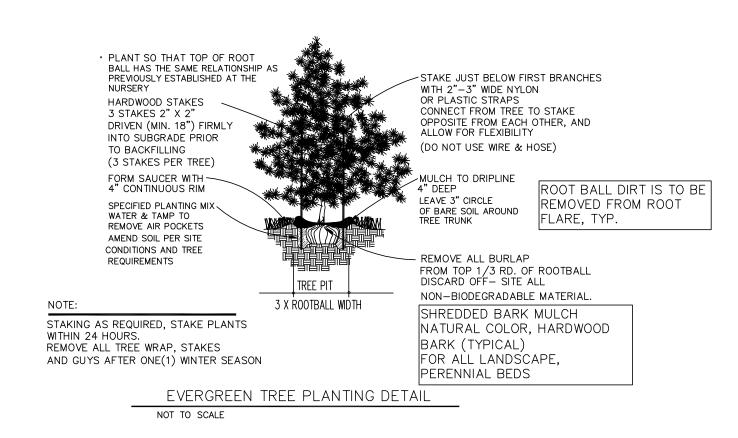

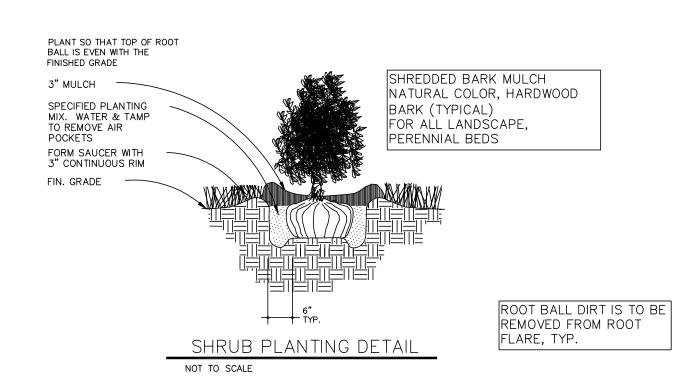


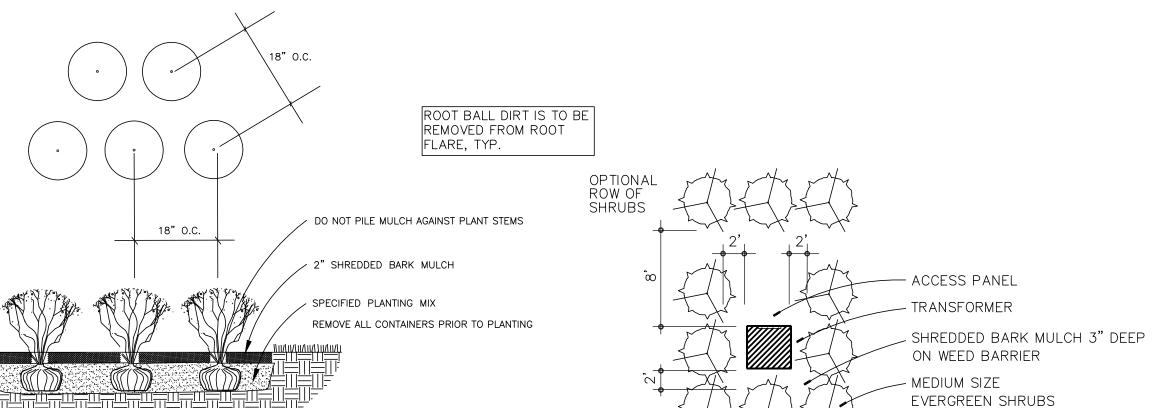

SCREENING FOR TRANSF./UTILITY BOXES

2.00

28.00

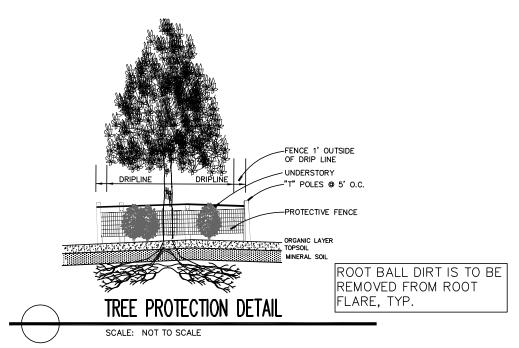

- 1. IDENTIFY ON SITE ALL TREES OR AREAS OF TREES WHICH ARE BEING PROPOSED TO BE PRESERVED WITH FLUORESCENT ORANGE SPRAY PAINT(CHALK BASE) OR BY RED FLAGGING TAPE.
- 2. ERECT BARRIERS OF FOUR(4) FOOT HIGH FENCING STAKED WITH METAL "T-POST" FIVE(5) FEET ON CENTER OR ALL SUCH TREES OR GROUPS OF TREES PROPOSED TO REMAIN.
- 3. PROTECTIVE BARRIERS ARE TO BE ERECTED PRIOR TO ANY CLEARING OR GRUBBING ON THE SITE, AND BARRIERS ARE TO REMAIN IN TACT UNTIL APPROVED BY THE CITY TO BE REMOVED, OR WHEN A CERTIFICATE OF OCCUPANCY IS ISSUED.
- 4. KEEP CLEAR ALL DEBRIS OR FILL, EQUIPMENT, AND MATERIAL FROM WITHIN THE REQUIRED PROTECTIVE BARRIER.
- 5. DURING CONSTRUCTION, THE OWNER, DEVELOPER, OR AGENT SHALL NOT CAUSE OR PERMIT ANY ACTIVITY WITHIN THE FENCE LINE OF ANY PROTECTED TREE OR GROUP OF TREES INCLUDING, BUT NOT LIMITED TO, THE STORAGE EQUIPMENT, DUMPSTER BOULDERS, DIRT, AND EXCAVATED MATERIAL, BUILDING OR WASTE MATERIAL, OR ANY OTHER MATERIAL HARMFUL TO THE LIFE OF A TREE.
- 6. NO DAMAGING ATTACHMENT, WIRES (OTHER THAN CABLE WIRES FOR TREES) SIGNS OR PERMITS MAY BE FASTENED TO ANY TREE PROTECTED BY THIS

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